# RESIDENTIAL OPEN SPACE PRESERVATION SUBDIVISION "VIOLETTE ESTATES"

TAX MAP 1, LOT 82 SCRIBNER ROAD, FREMONT, NH

# SHEET INDEX

CS **COVER SHEET** 

A1 OVERALL SUBDIVISION PLAN

SUBDIVISION PLANS

C1A-C1B EXISTING CONDITIONS PLAN

OVERALL SITE PLAN

C2A-C2B SITE PLANS

OVERALL GRADING & DRAINAGE PLAN

C3A-C3B GRADING AND DRAINAGE PLANS

PLAN AND PROFILE

ROADWAY CROSS-SECTIONS

APPLICANT / DEVELOPER

H1 HIGHWAY ACCESS PLAN

D1-D5 DETAIL SHEETS

HAUS EMILY, LLC

(603) 765-8995

PO BOX 219

(603) 772-4746

56 WESTVILLE ROAD #4

CONTACT: GARY DENSEN

85 PORTSMOUTH AVENUE

STRATHAM, NH 03885

CONTACT: BARRY GIER


CIVIL ENGINEER / SURVEYOR

JONES & BEACH ENGINEERS, INC.

EMAIL: BGIER@JONESANDBEACH.COM

PLAISTOW, NH 03865

**EROSION AND SEDIMENT CONTROL DETAILS** 

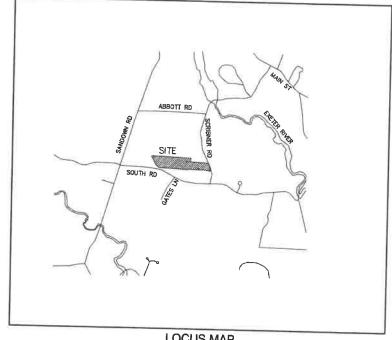

LOCUS MAP SCALE 1" = 2000

TYPE OF PERMIT ENVIRONMENTAL SERVICES -

29 HAZEN DRIVE, P.O. BOX 95 CONCORD, NEW HAMPSHIRE 03302-0095 (603) 271-3503 RESPONSIBLE CONSULTANT: EXPIRATION: JONES & BEACH ENGINEERS, INC.

STATUS

SUBMITTED;

PERMIT NO

EXPIRATION:

NHDES WETLAND PERMIT: NEW HAMPSHIRE DEPARTMENT OF ENVIRONMENTAL SERVICES-PERMIT NO WETLANDS BUREAU 29 HAZEN DRIVE, P.O. BOX 95 DATED: CONCORD, NEW HAMPSHIRE 03302

(603) 271-2147 RESPONSIBLE CONSULTANT-JONES & BEACH ENGINEERS, INC.

USEPA NPDES PHASE II CONSTRUCTION GENERAL PERMIT, NOTICE OF INTENT (NOI), AND NOTICE OF TERMINATION (NOT) TO BE FILED IN ACCORDANCE WITH FEDERAL AND LOCAL REGULATIONS PRIOR TO AND FOLLOWING CONSTRUCTION: EPA STORMWATER NOTICE PROCESSING CENTER MAIL CODE 4203M, US EPA 1200 PENNSYLVANIA AVENUE, NW WASHINGTON, DC 20460 RESPONSIBLE CONSULTANT: JONES & BEACH ENGINEERS, INC.

# TYPE OF PERMIT

FREMONT SITE PLAN APPROVAL: TOWN OF FREMONT PLANNING BOARD SUBMITTED: 295 MAIN STREET PERMIT NO. (603) 895-3200 EXT 3ng JONES & BEACH ENGINEERS INC.

DATED: EXPIRATION:

**STATUS** 

- ON NOV. 4<sup>TM</sup>, 2020 THE FREMONT PLANNING BOARD VOTED TO APPROVE ONE (1) ADDITIONAL BONUS LOT FOR THE PROJECT PER SECT. 1902.8.C OF THE TOWN OF FREMONT ZORING REGULATIONS.
- THE FREMONT PLANNING BOARD VOTED ON DECEMBER 2<sup>III</sup>, 2020 TO GRANT THE FOLLOWING WAIVERS TO THE FREMONT SUBDIVISION REGULATIONS:
  A) SECTION 31. SITE SPECIFIC SOILS MAPPING
  B) SECTION 32. ST. SPELL RADIUS ON LOT
  C) SECTION 10.02.R CULL-DE-NG RODA LENGTH
  D) SECTION 10.02.R CULL-DE-NG RODA LENGTH
  D)

TAX MAP 1, LOT 82

APPLICANT HERITAGE FARM TRUST STEPHEN L BASSETT, TRUSTEE PO BOX 212 NEWFIELDS, NH 03856

TOTAL LOT AREA 978,485± SQ. FT. 22.46± ACRES

APPROVED - FREMONT, NH PLANNING BOARD

DATE:

# Checked: BWG Scale: AS NOTED Project No.:19175.1 Drawing Name: 19175-PLAN.dwg

THIS PLAN SHALL NOT BE MODIFIED WITHOUT WRITTEN PERMISSION FROM JONES & BEACH ENGINEERS, INC. (JBE). ANY ALTERATIONS, AUTHORIZED OR OTHERWISE, SHALL BE AT THE USER'S SOLE RISK AND WITHOUT LIABILITY TO JBE.



OWNER OF RECORD

HERITAGE FARM TRUST

NEWFIELDS, NH 03856

PO BOX 212

LEE, NH 03824

(603) 659-0416

STEPHEN L BASSETT, TRUSTEF

WETLAND CONSULTANT

WEST ENVIRONMENTAL, INC.

122 MAST ROAD, SUITE 6

CONTACT: MARK WEST

2	12/10/20	REVISED PER PB COMMENTS	Disec
1	11/23/20	REVISED PER PB COMMENTS	BWG
0	9/25/20	ISSUED FOR REVIEW	ERE
REV.	DATE	REVISION	BY

**ELECTRIC** 

PO BOX 330

EVERSOURCE

(800) 662-7764

TELEPHONE

(603) 427-5525

CABLE TV XFINITY

740 N COMMERCIAL ST

1575 GREENLAND ROAD

CONTACT: JOE CONSIDINE

GREENLAND, NH 03840

334-B CALEF HIGHWAY EPPING, NH 03042-2325 (603) 679-5695


MANCHESTER, NH 03105-0330


CONSOLIDATED COMMUNICATIONS

Designed and Produced in NH Jones & Beach Engineers, Inc. 85 Portsmouth Ave. Civil Engineering Services E-MAIL: JBE@JONESANDBEACH.COM

Plan Name:	COVER SHEET
Project:	VIOLETTE ESTATES FREMONT, NH
Owner of Record:	HERITAGE FARM TRUST PO BOX 212, NEWFIELDS, NH 03856

CS

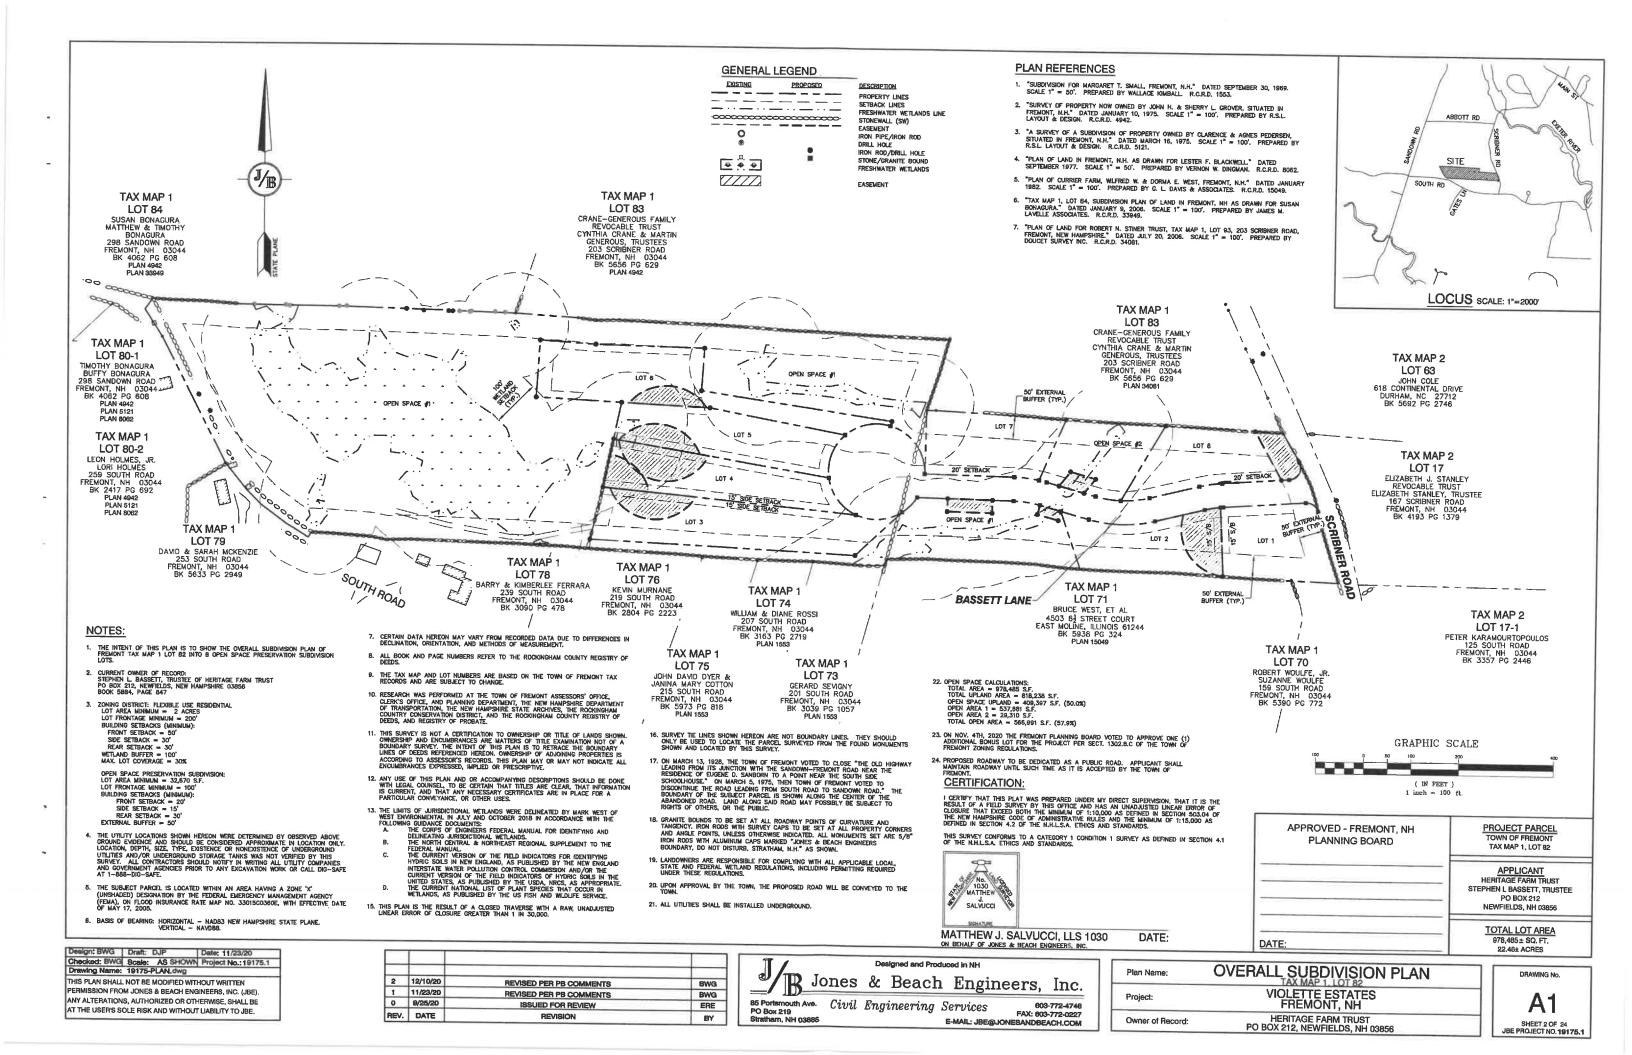

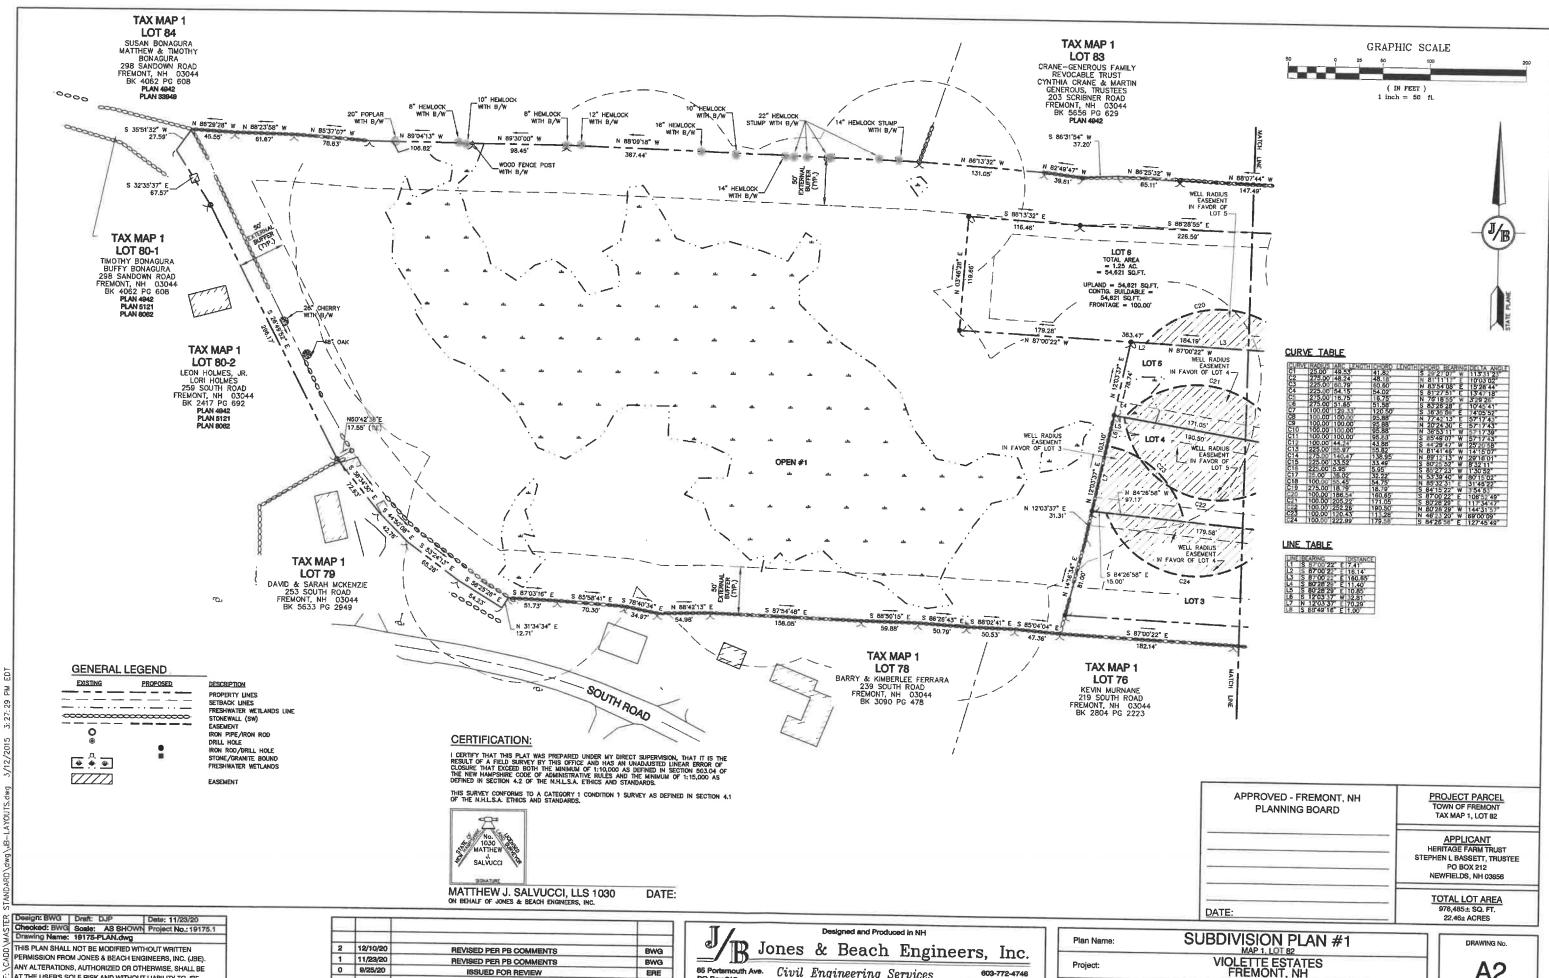

AT THE USER'S SOLE RISK AND WITHOUT LIABILITY TO JBE.


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1	11/23/20	REVISED PER PB COMMENTS	BWG
0	9/25/20	ISSUED FOR REVIEW	ERE
REV.	DATE	REVISION	BY

11/		De	signed and Pro	duced in NH		
B Jo	nes	&	Beach	n Engi	neers,	Inc.
85 Portsmouth Ave. PO Box 219 Stratham, NH 03885	Civil	Eng	ineering		603 FAX: 603 @JONESANDSE	1-772-4746 1-772-0227

E-MAIL: JBE@JONESANDBEACH.COM

Plan Name:	SUBDIVISION PLAN #1	
Project:	VIOLETTE ESTATES FREMONT, NH	
Owner of Record:	HERITAGE FARM TRUST PO BOX 212, NEWFIELDS, NH 03856	

SHEET 3 OF 24 JBE PROJECT NO. 19175.1

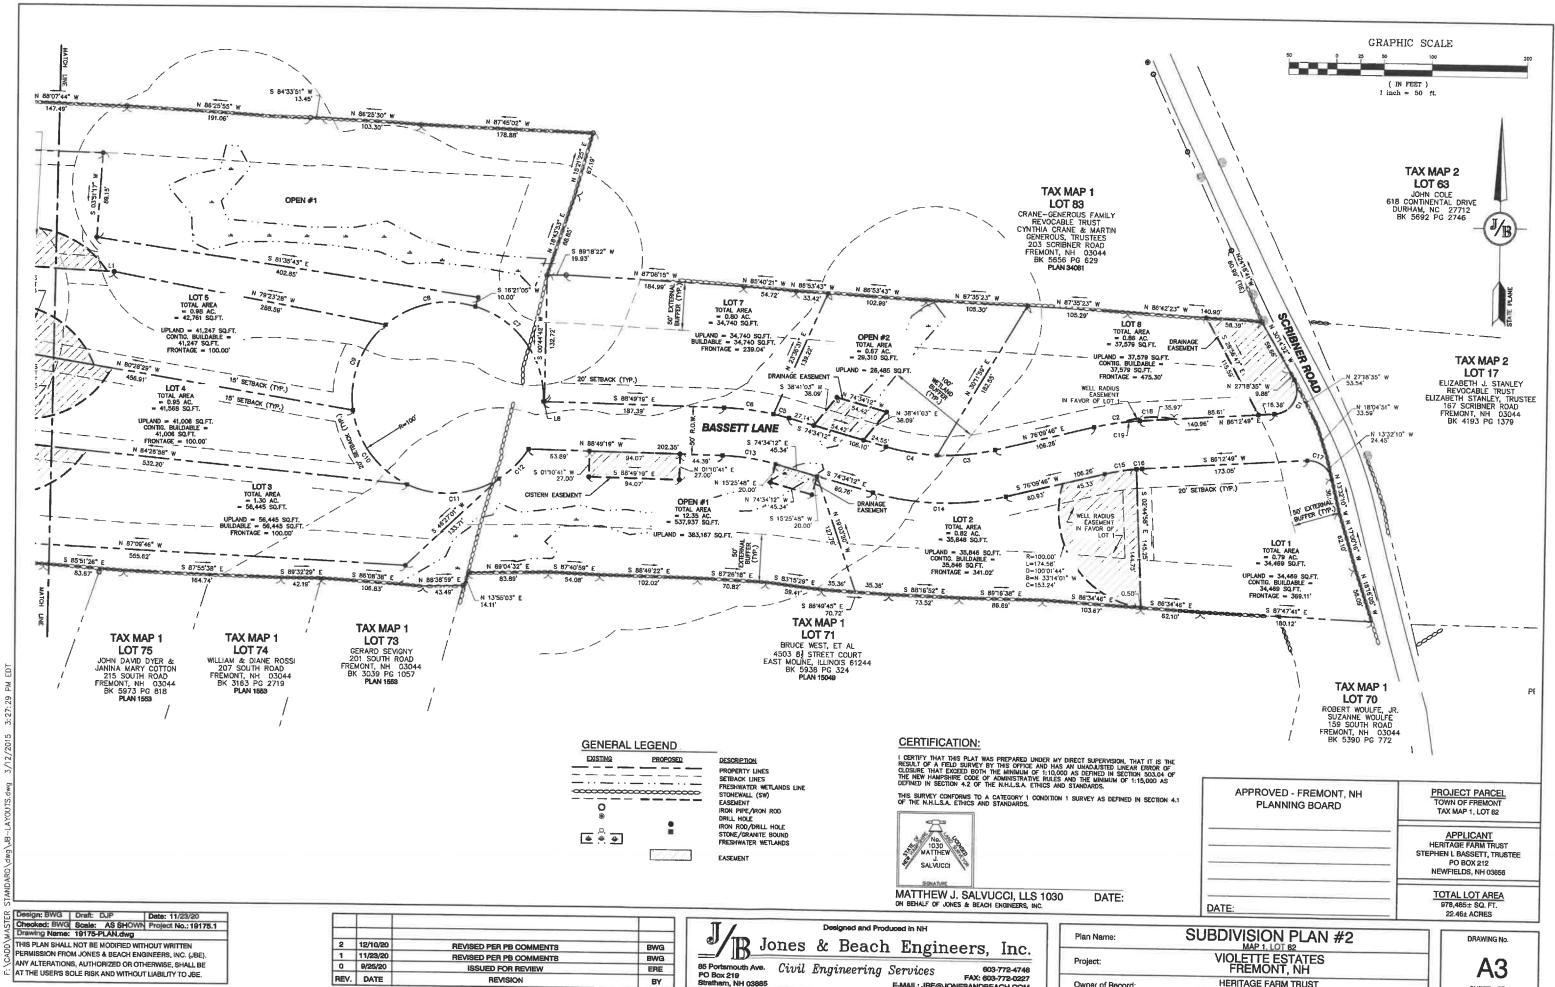

E-MAIL: JBE@JONESANDBEACH.COM

AT THE USER'S SOLE RISK AND WITHOUT LIABILITY TO JBE.

REV. DATE REVISION BY

Plan Name:	SUBDIVISION PLAN #2	
Project:	VIOLETTE ESTATES FREMONT, NH	
Owner of Record:	HERITAGE FARM TRUST PO BOX 212, NEWFIELDS, NH 03856	

**A3** SHEET 4 OF 24 JBE PROJECT NO. 19175.1

# SUBDIVISION NOTES:


- THE INTENT OF THIS PLAN IS TO SHOW A YIELD PLAN OF AN 7-LOT RESIDENTIAL CONVENTIONAL SUBDIVISION ON MAP 1, LOT 82, LOTS TO BE SERVED BY ON-SITE SEPTIC AND WELLS.
- 2. ZONING DISTRICT: FLEXGILE USE RESIDENTAIL


  LOT AREA MINIMUM = 87,120 SF
  MINIMUM CONTINUOUS UPLAND AREA = 43,560 SF
  LOT PROVINGE MINIMUM = 200'

  (100' ALLOWED ON EXTERIOR CURVE W/ 200' AVG. LOT WIDTH)

  BULLDING SETBACKS (MINIMUM):

  FRONT SETBACK = 50'
  SIDE SETBACK = 30'
  REAR SETBACK = 30'
  WETAND SETBACK = 100'
  MAX. LOT COVERAGE = 30%
- 3. PROPOSED ROAD LENGTH = 1,434 LF
- 4. WETLAND IMPACT = 492 SQ.FT.
- 5. WAIVERS REQUIRED:
   SECTION 10.02.R. TABLE 1: CUL-DE-SAC LENGTH GREATER THAN 800'

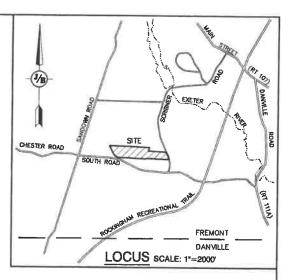

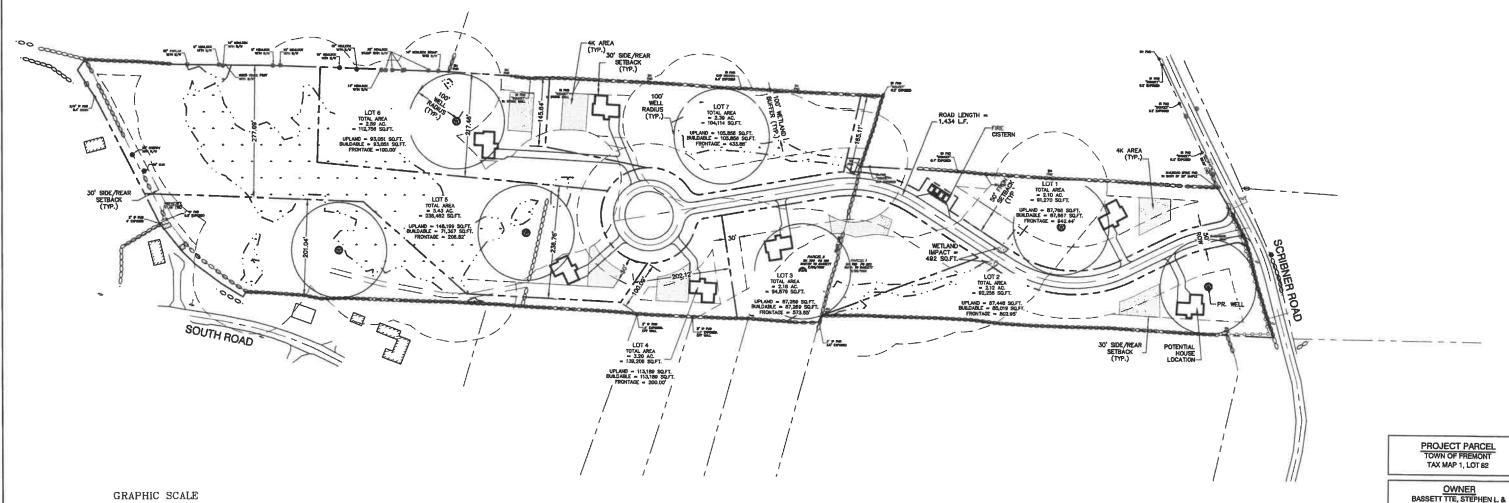

100	9	50	100	200	400
	-				
			( IN )	FEET )	
			1 inch =		

APPLICANT
HAUS EMILY, LLC
56 WESTVILLE ROAD #4 PLAISTOW, NH 03865

HERITAGE FARM TRUST P.O. BOX 212 NEWFIELDS, NH 03856 BK 5884, PG 0847

TOTAL LOT AREA 978,484.5 SQ. FT. 22.46 ACRES

Date: 04/30/20 Design: BWG | Draft: BWG Checked: BAJ Scale: 1\*=100' Project No.: 19175
Drawing Name: 19175-YIELD THIS PLAN SHALL NOT BE MODIFIED WITHOUT WRITTEN PERMISSION FROM JONES & BEACH ENGINEERS, INC. (JBE). ANY ALTERATIONS, AUTHORIZED OR OTHERWISE, SHALL BE

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2	06/17/20	REVISED PER TOWN COMMENTS	BWG
1	05/27/20	REVISED PER TOWN PLANNER COMMENTS	BWG
0	04/29/20	ISSUED FOR REVIEW	BWG
REV.	DATE	REVISION	BY


Designed and Produced in NH Jones & Beach Engineers, Inc.

85 Portsmouth Ave. PO Box 219
Stratham, NH 03885

RE-MAIL: JBEG 603-772-4746 FAX: 603-772-0227 E-MAIL: JBE@JONESANDBEACH.COM

Plan Name:	CONCEPTUAL YIELD PLAN
Project:	SCRIBNER ROAD FREMONT, NH
Owner of Record:	STEPHEN L. BASSETT TTE & HERITAGE FARM TRUST PO BOX 212, NEWFIELDS, NH 03856

DRAWING No.

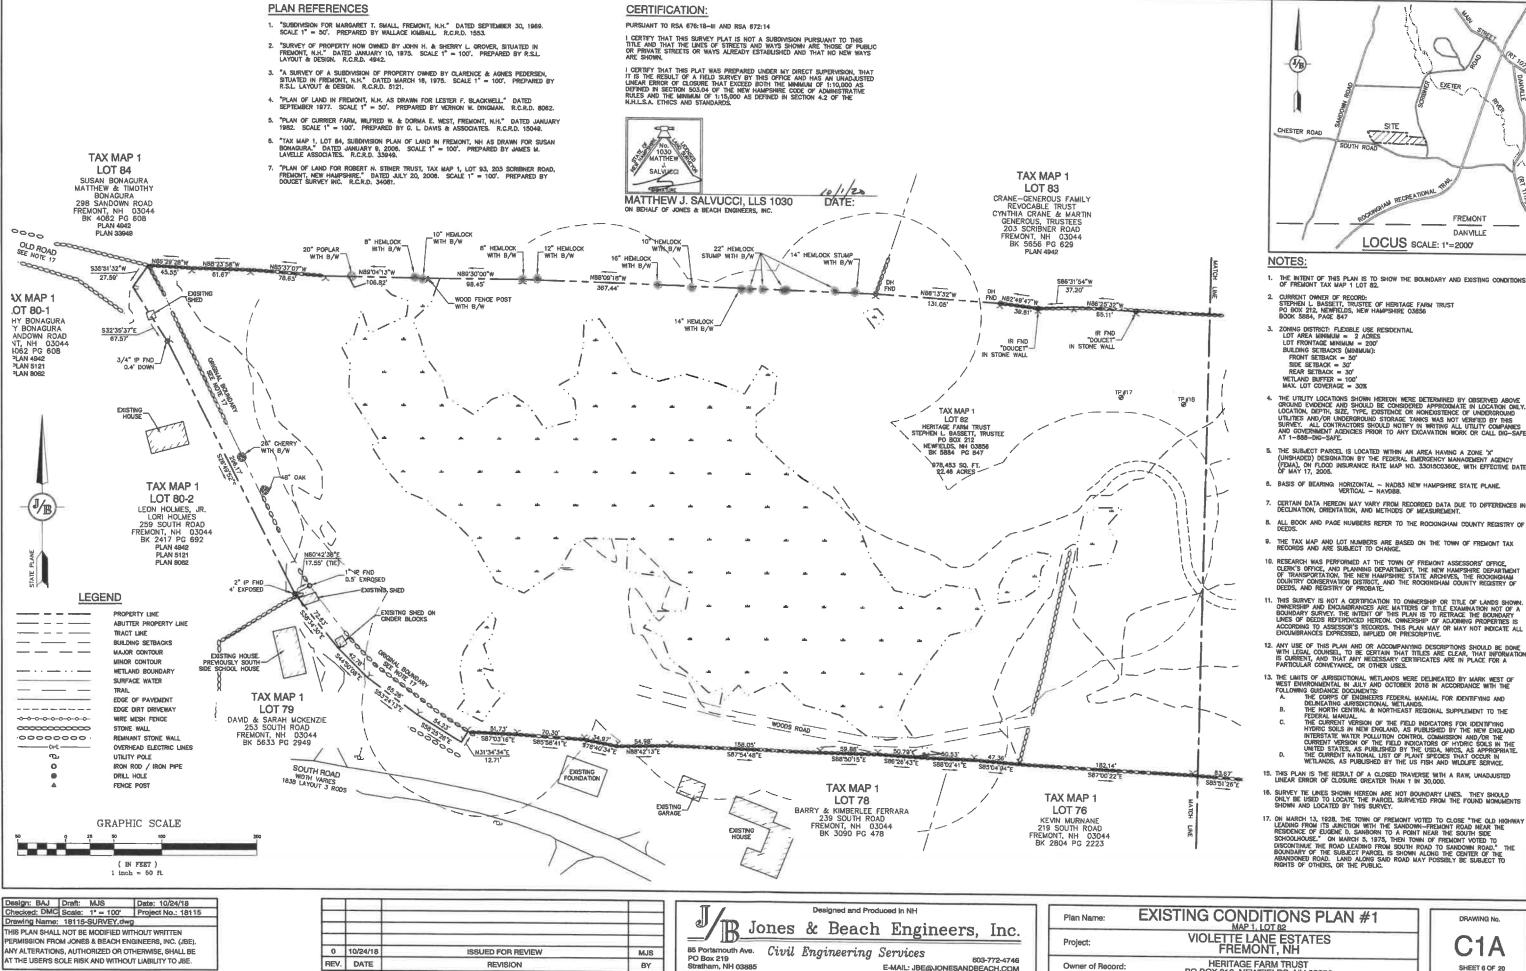


Project No.: 18115	
OUT WRITTEN	
NEERS, INC. (JBE). ERWISE, SHALL BE	
LIABILITY TO JBE.	

0	10/24/18	ISSUED FOR REVIEW	MJS
REV.	DATE	REVISION	BY

Plan Name:	EXISTING CONDITIONS PLAN #1
Project:	VIOLETTE LANE ESTATES FREMONT, NH
Owner of Record:	HERITAGE FARM TRUST PO BOX 212, NEWFIELDS, NH 03856

SHEET 6 OF 20

JBE PROJECT NO. 18115

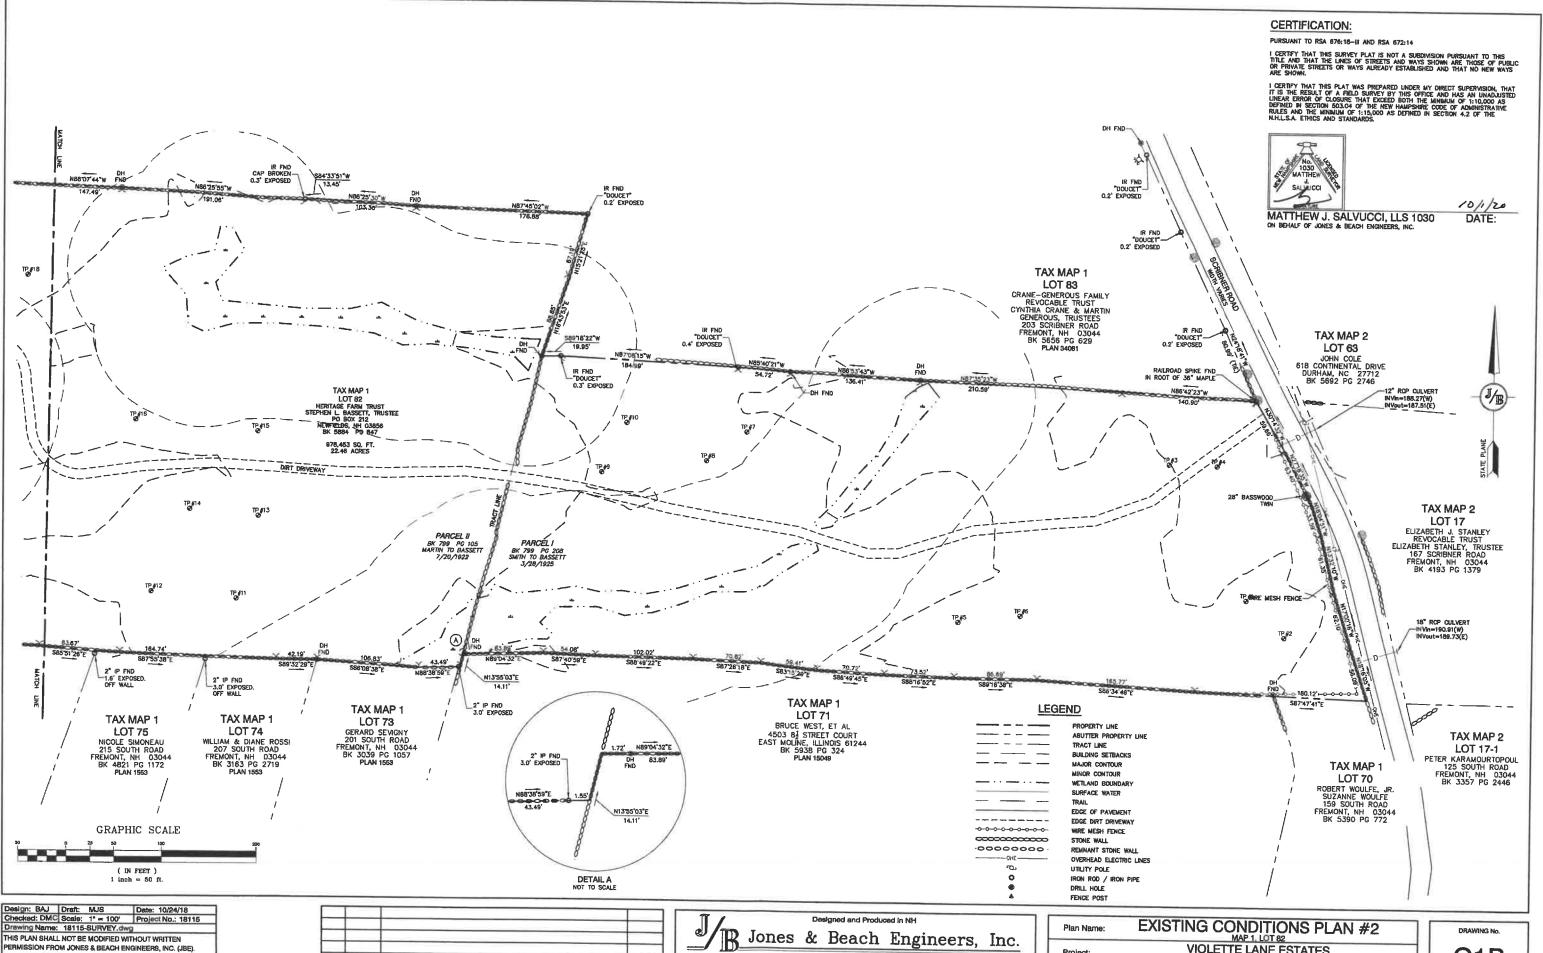

ANY ALTERATIONS, AUTHORIZED OR OTHERWISE, SHALL BE AT THE USER'S SOLE RISK AND WITHOUT LIABILITY TO JBE.


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0	10/24/18	ISSUED FOR REVIEW	MJS
REV.	DATE	REVISION	BY

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	Jones	&	Beach	Engineers,	Inc.
			iden comien a S		

civil Engineering Services PO Box 219 603-772-4746 E-MAIL: JBE@JONESANDBEACH.COM

Plan Name:	EXISTING CONDITIONS PLAN #2
Project:	VIOLETTE LANE ESTATES FREMONT, NH
Owner of Record:	HERITAGE FARM TRUST PO BOX 212, NEWFIELDS, NH 03856

C<sub>1</sub>B SHEET 7 OF 20 JBE PROJECT NO. 18115

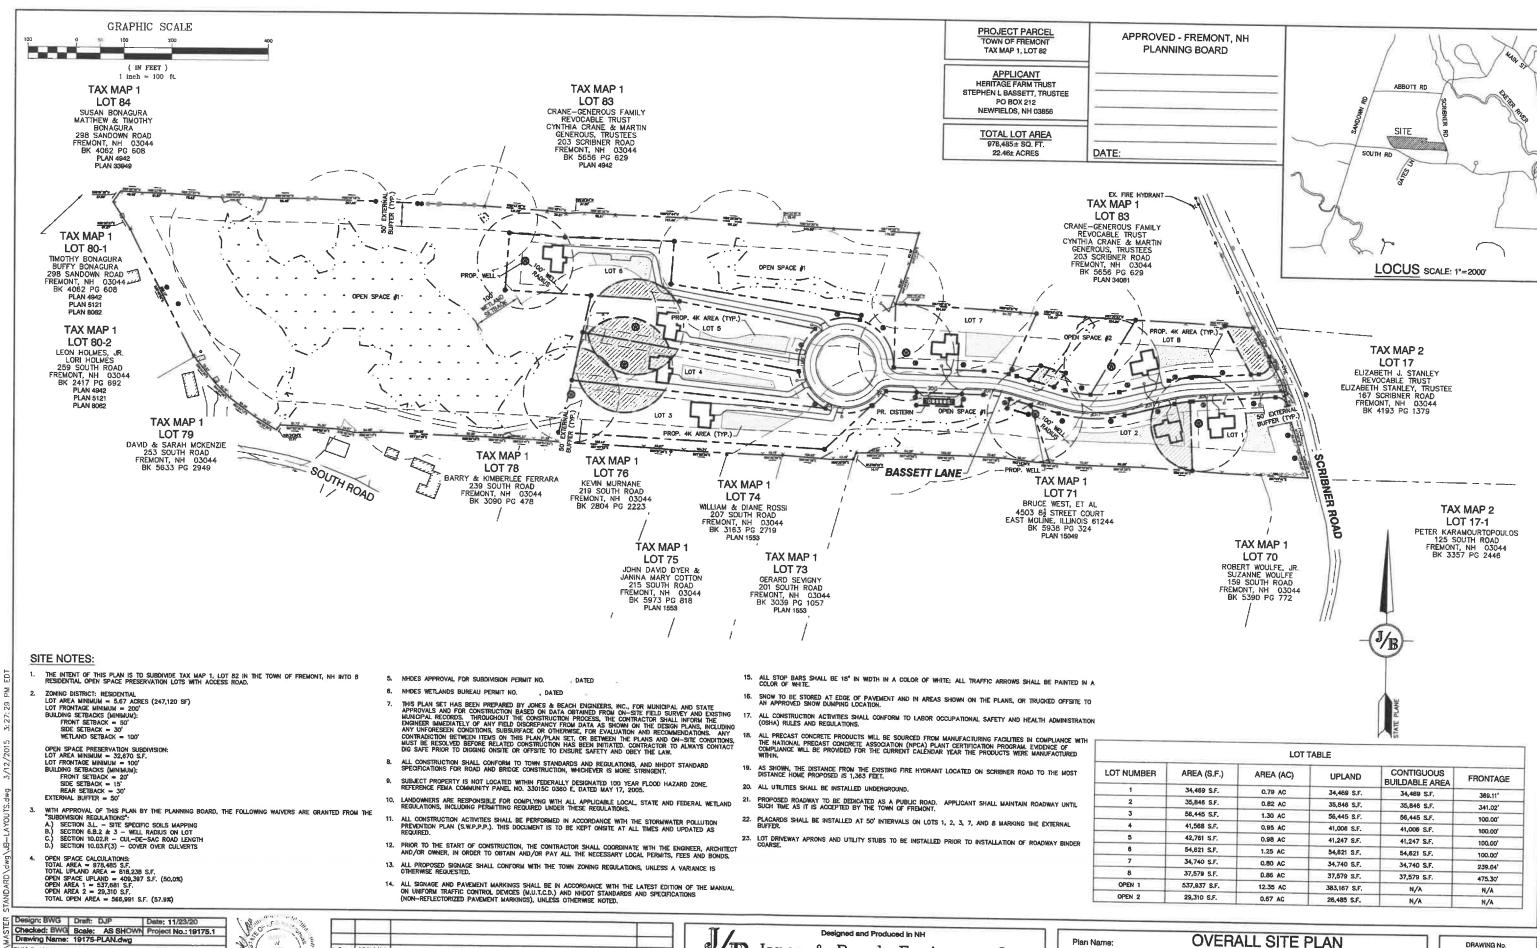

Drawing Name: 19175-PLAN.dwg

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BWG	REVISED PER PB COMMENTS	12/10/20	2
BWG	REVISED PER PB COMMENTS	11/23/20	1
ERE	ISSUED FOR REVIEW	9/25/20	0
BY	REVISION	DATE	REV.

Jones & Beach Engineers, Inc.


B5 Fortsmouth Ave. Civil Engineering Services

603-772-476

E-MAIL: JBE@JONESANDBEACH.COM

	Plan Name:	OVERALL SITE PLAN		
	Project:	VIOLETTE ESTATES FREMONT, NH		
	Owner of Record:	HERITAGE FARM TRUST		

C2
SHEET 8 OF 24
JBE PROJECT NO. 19175.1

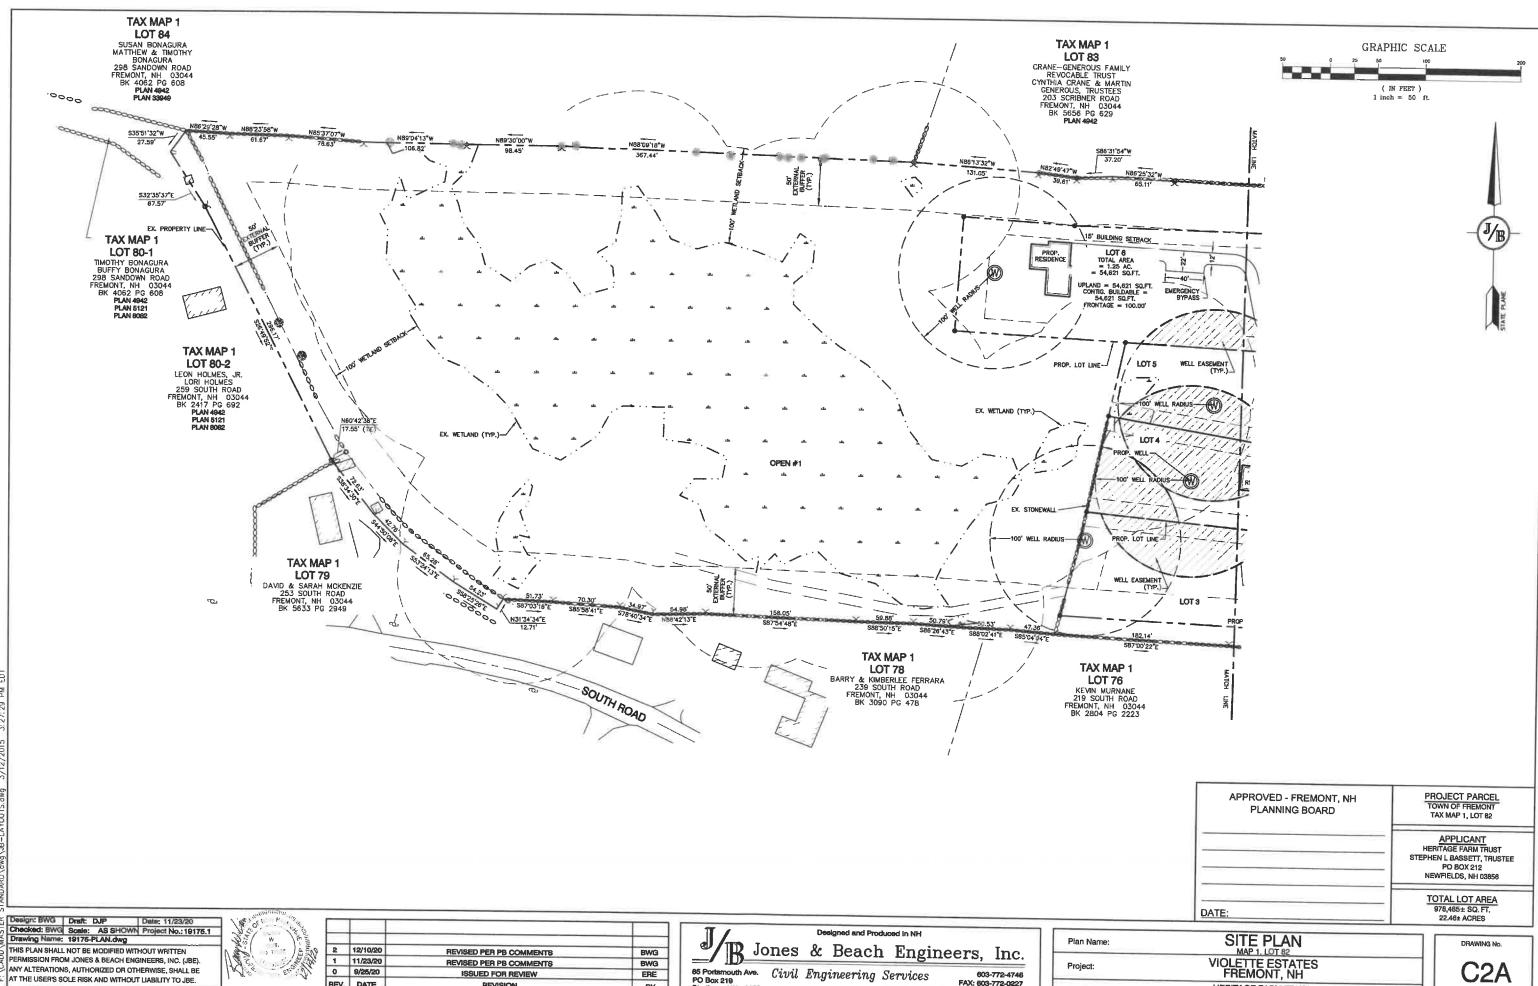




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1	11/23/20	REVISED PER PB COMMENTS	BWG
0	9/25/20	ISSUED FOR REVIEW	ERE
REV.	DATE	REVISION	BY

E-MAIL: JBE@JONESANDBEACH.COM

Plan Name:	SITE PLAN MAP 1, LOT 82	
Project:	VIOLETTE ESTATES FREMONT, NH	
Owner of Record:	HERITAGE FARM TRUST PO BOX 212, NEWFIELDS, NH 03856	

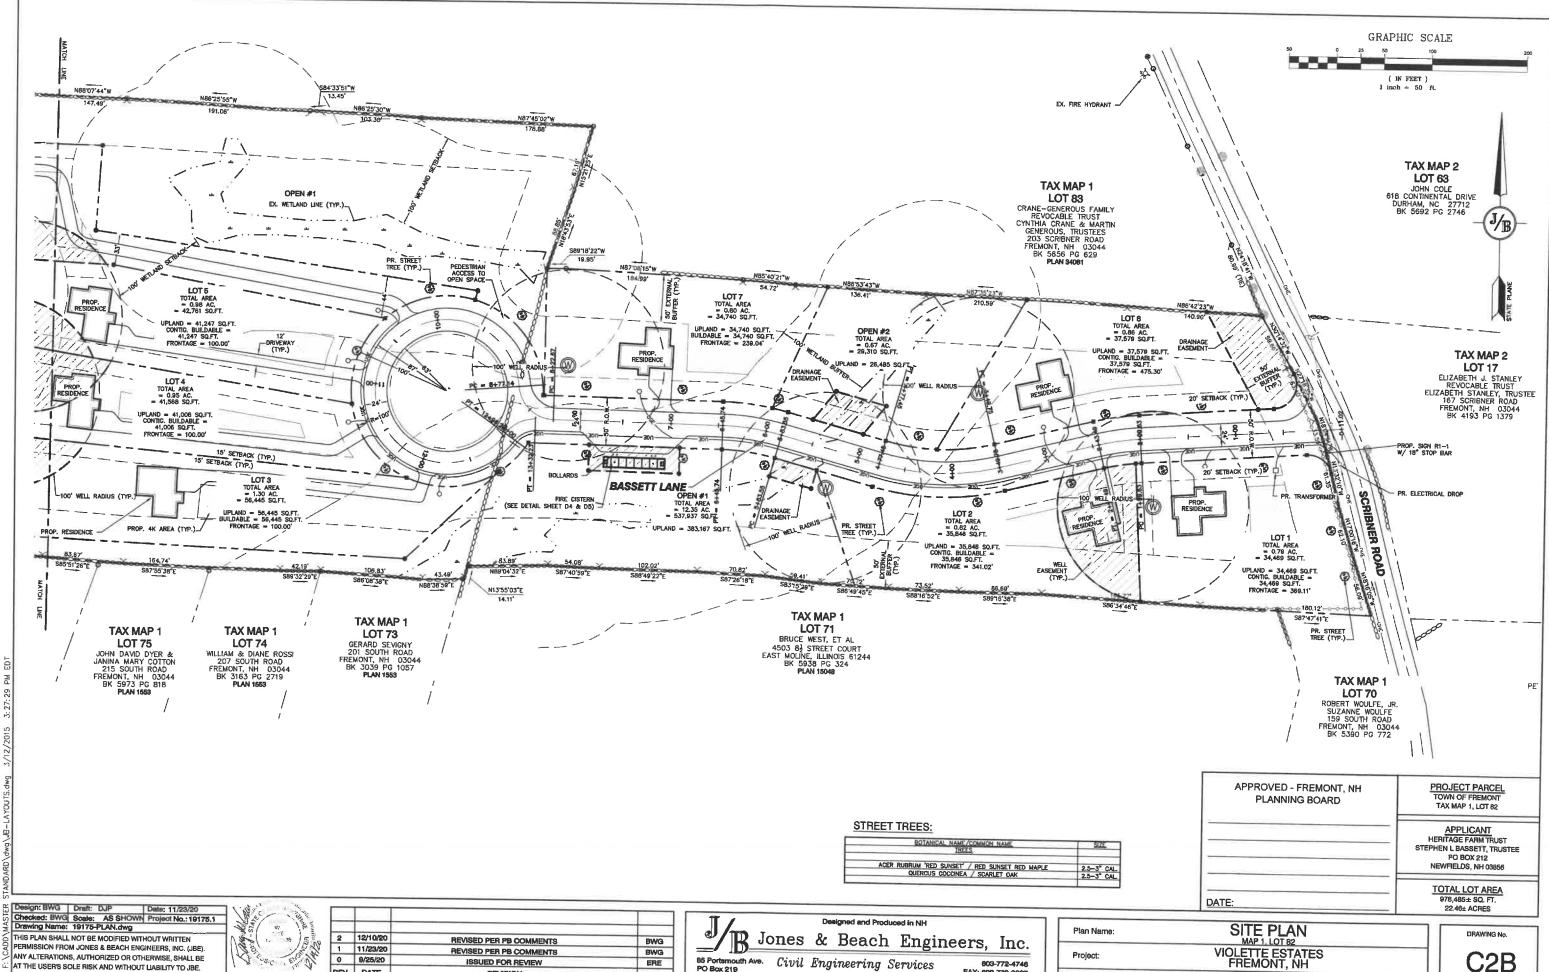

PO Box 219 Stratham, NH 03885


0 9/25/20 ISSUED FOR REVIEW ERE REV. DATE REVISION BY

Project: VIOLETTE ESTATES FREMONT, NH	Plan Name:
	Project:
Owner of Record: HERITAGE FARM TRUST PO BOX 212, NEWFIELDS, NH 03856	Owner of Record:

FAX: 603-772-0227

E-MAIL: JBE@JONESANDBEACH.COM

C<sub>2</sub>B SHEET 10 OF 24 JBE PROJECT NO. 19175.1

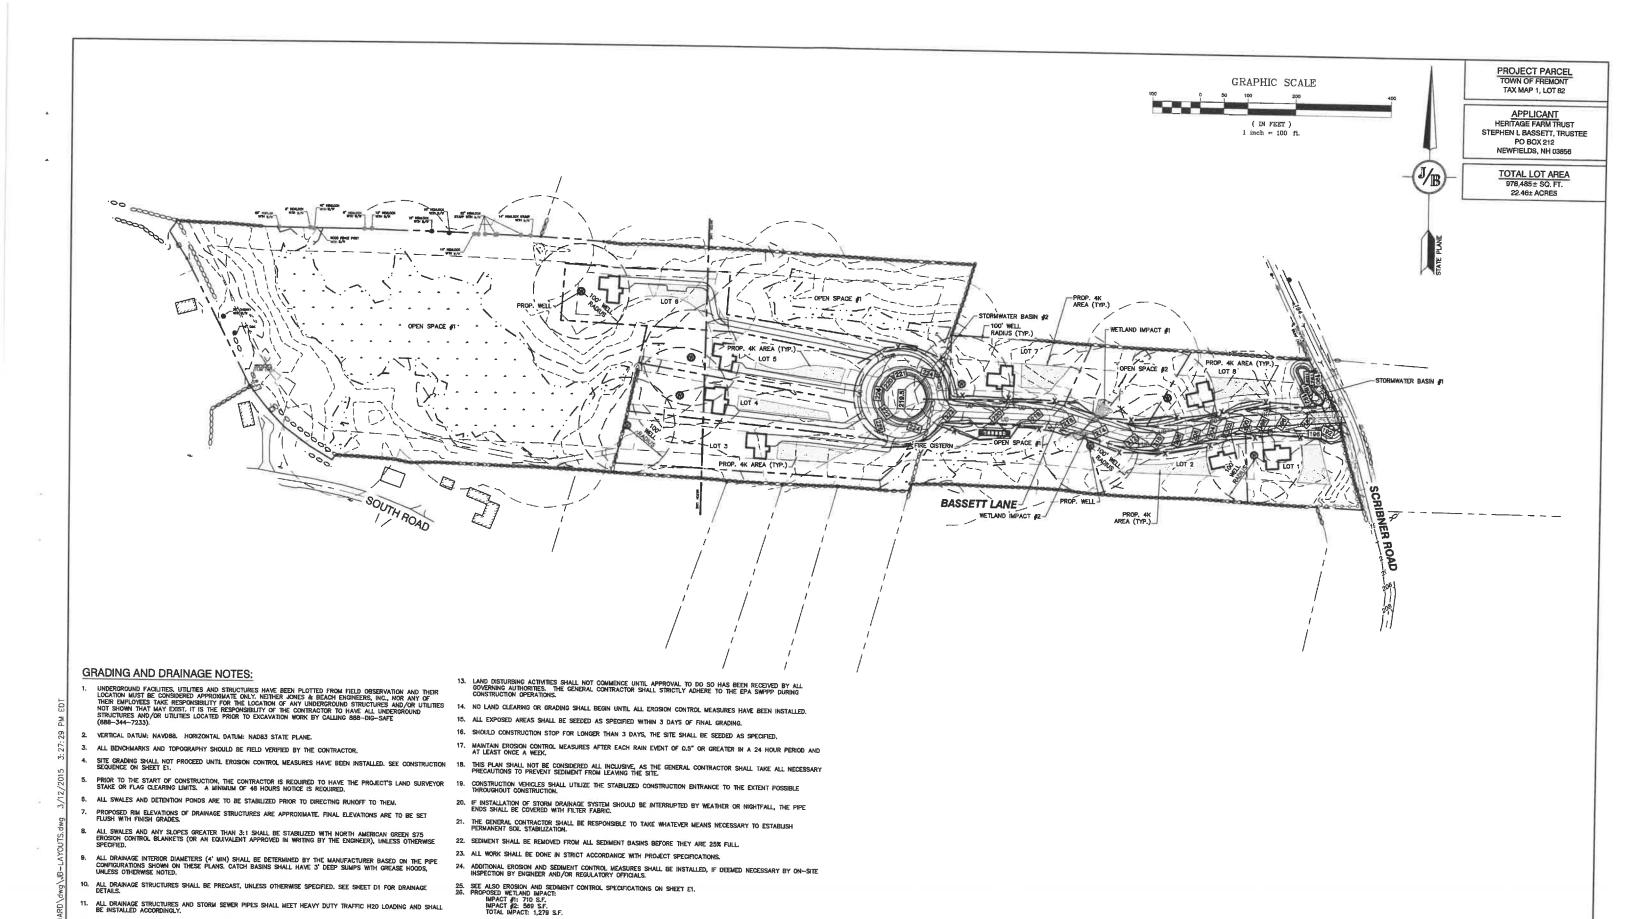

Design: BWG Draft: DJP Dete: 11/23/20
Checked: BWG Scale: AS SHOWN Project No.: 19175.1
Drawing Name: 19175-PLAN.dwg
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1	11/23/20	REVISED PER PB COMMENTS	BWG
0	9/25/20	ISSUED FOR REVIEW	ERE
REV.	DATE	REVISION	BY

27. CONTRACTOR TO REVIEW EXISTING CULVERT CONDITION WITH TOWN ENGINEER AND ROAD AGENT PRIOR TO CONSTRUCTION. EXISTING CULVERT TO BE CLEANED OR REPLACED AS REQUIRED.

Designed and Produced in NH

Jones & Beach Engineers, Inc.


85 Portsmouth Ave. Civil Engineering Services
PO Box 219
Stratham, NH 03885

Designed and Produced in NH

603-772-4746
FAX: 603-772-4726
FAX: 603-772-0227
E-MAIL: JBE@JONESANDBEACH.COM

Plan Name: OVERAL GRADING AND DRAINAGE PLAN
Project: VIOLETTE ESTATES

VIOLETTE ESTATES FREMONT, NH HERITAGE FARM TRUST PO BOX 212, NEWFIELDS, NH 03856 SHEET 11 OF 24
JBE PROJECT NO. 19175.1

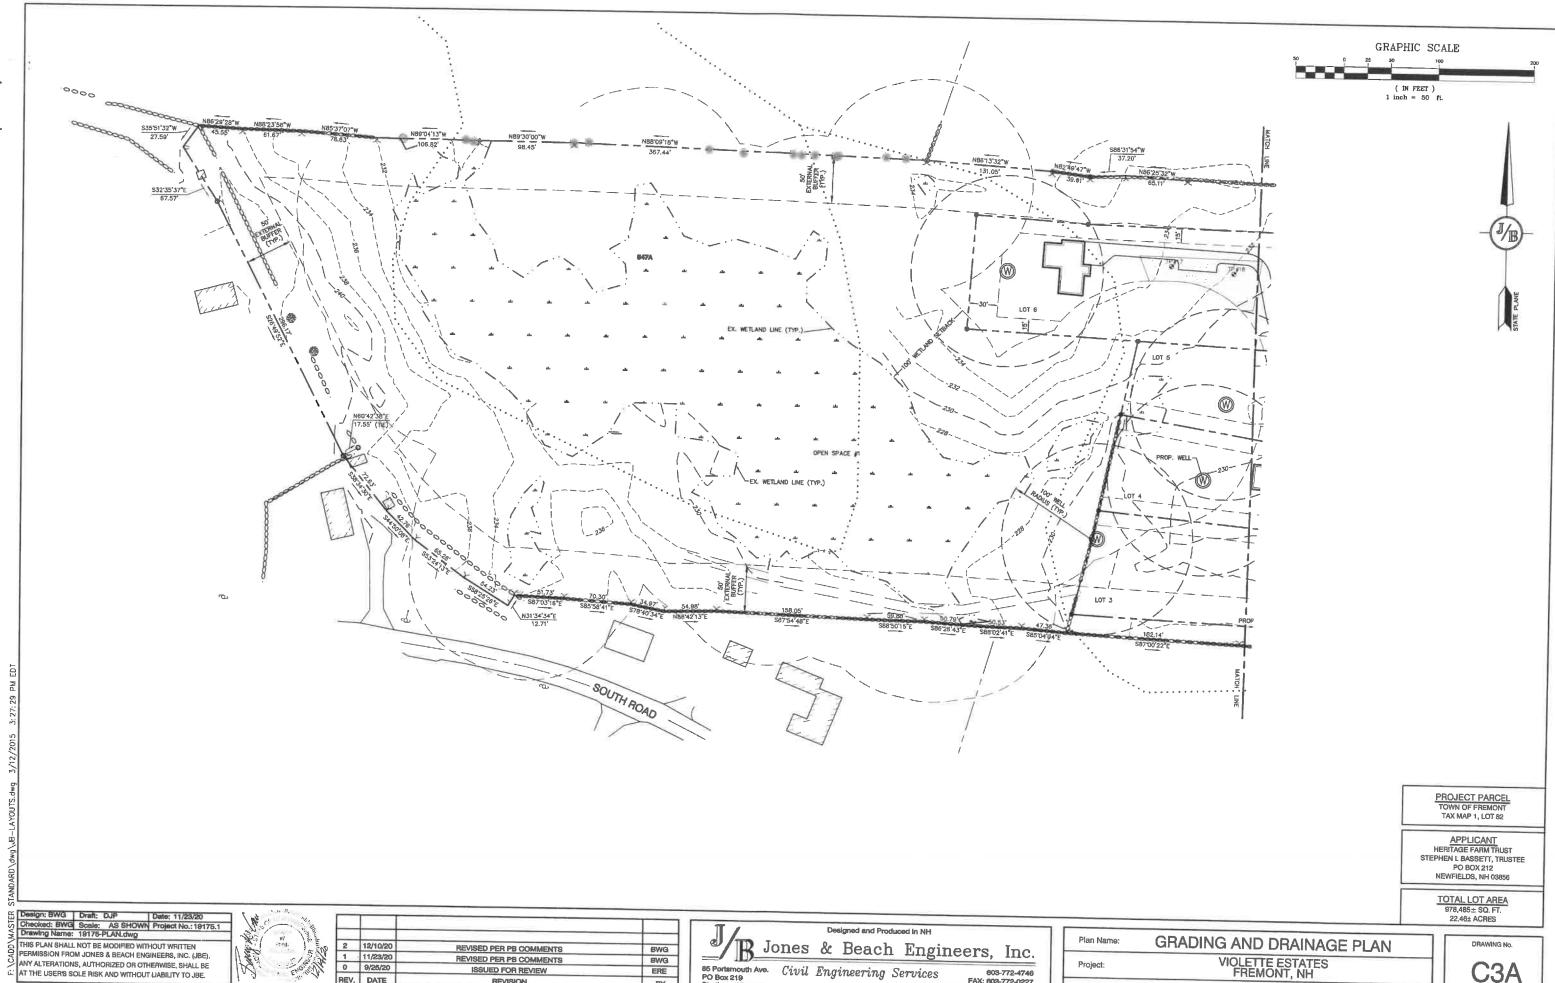

85 Portsmouth Ave. Civil Engineering Services
PO Box 219
Stretham, NH 03885

Project:

Owner of Record:

HERITAGE FARM TRUST PO BOX 212, NEWFIELDS, NH 03856

Setvices 603-772-4746 FAX: 603-772-0227 E-MAIL: JBE@JONESANDBEACH.COM

0 9/25/20 REV. DATE


ISSUED FOR REVIEW

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СЗА SHEET 12 OF 24 JBE PROJECT NO. 19175.1





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REV.	DATE	REVISION	BY

VIOLETTE ESTATES FREMONT, NH HERITAGE FARM TRUST PO BOX 212, NEWFIELDS, NH 03856 C<sub>3</sub>B

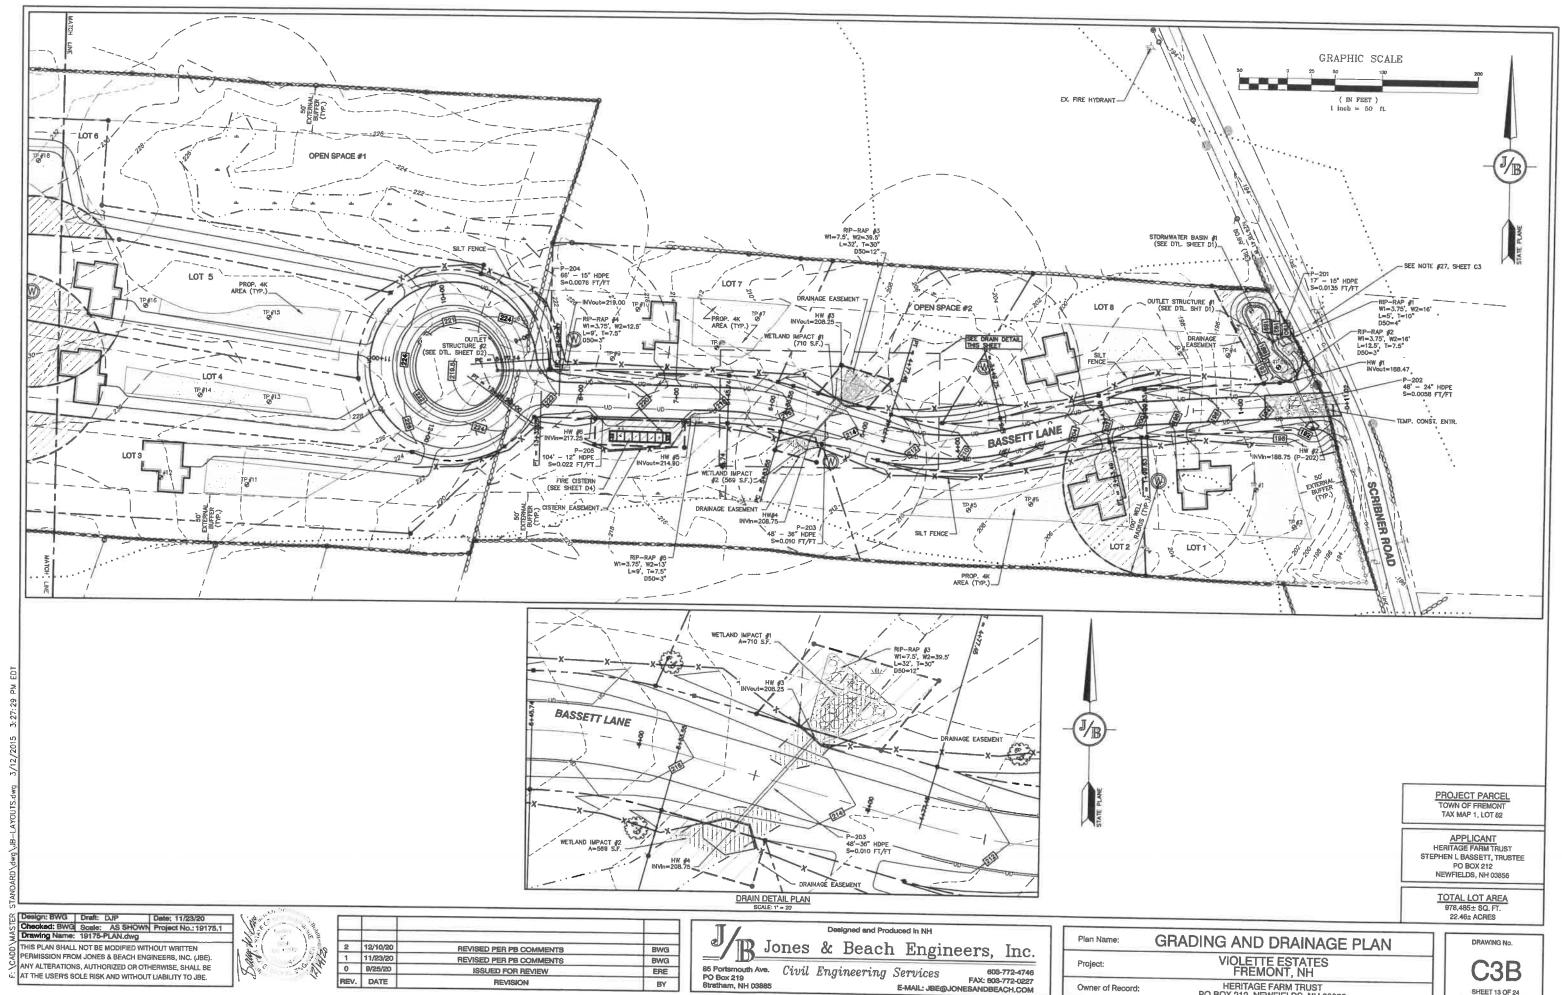

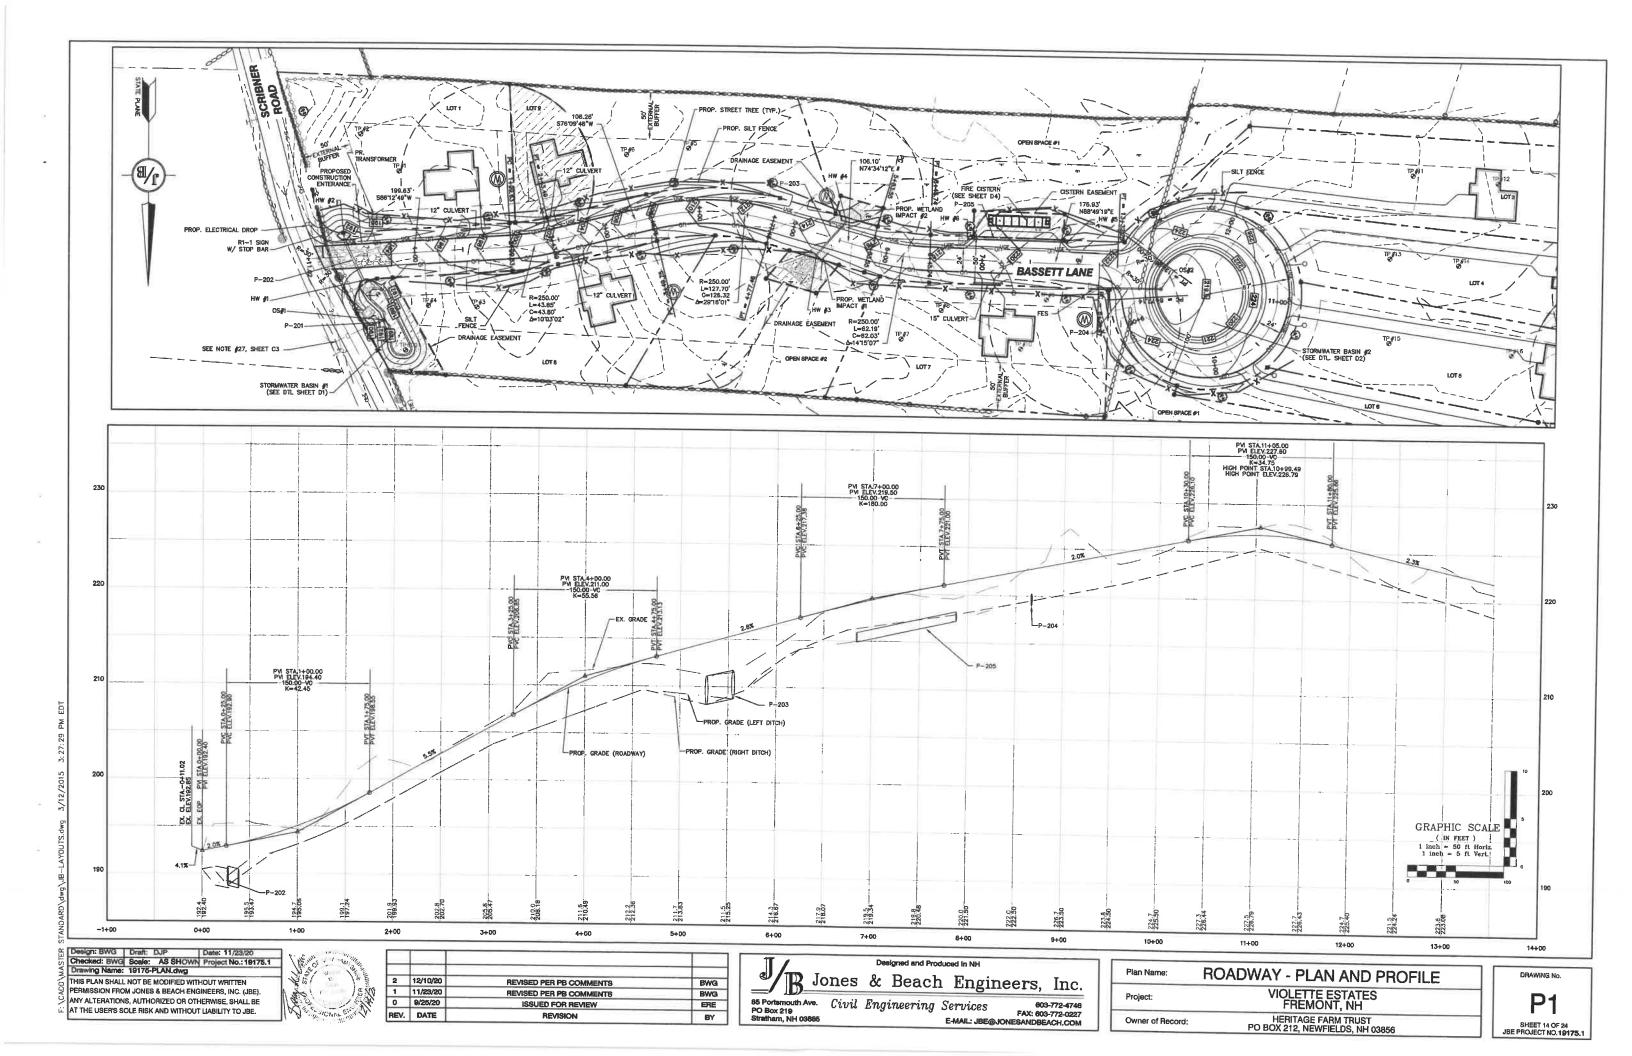


HERITAGE FARM TRUST PO BOX 212, NEWFIELDS, NH 03856

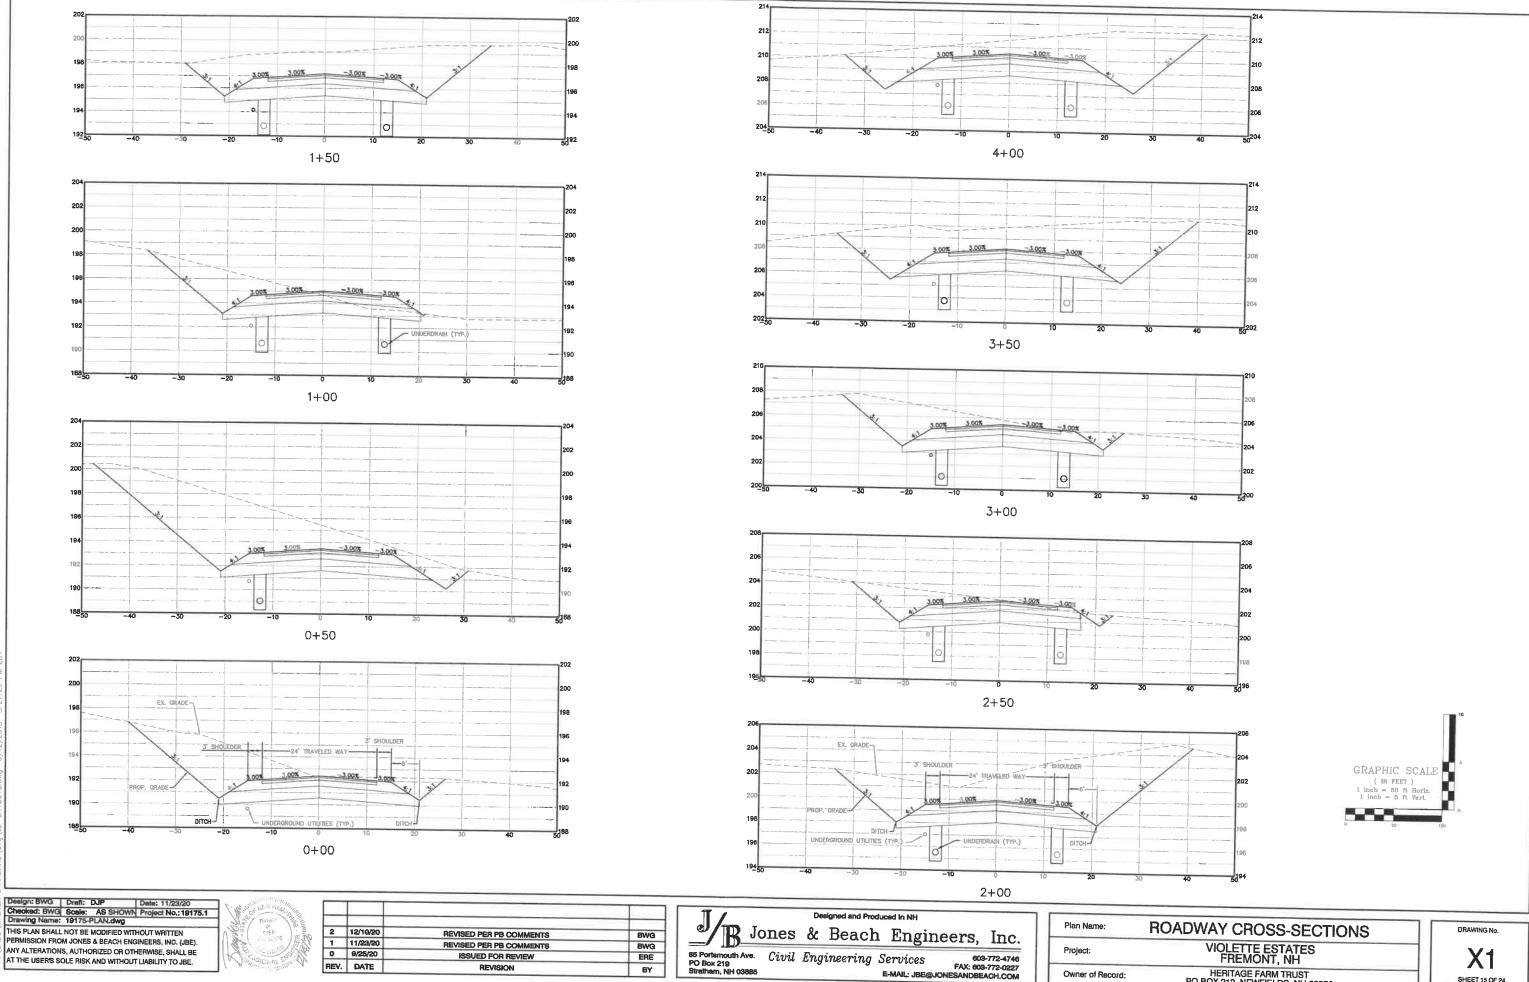
SHEET 15 OF 24 JBE PROJECT NO.19175.1

Owner of Record:

REVISION

BY

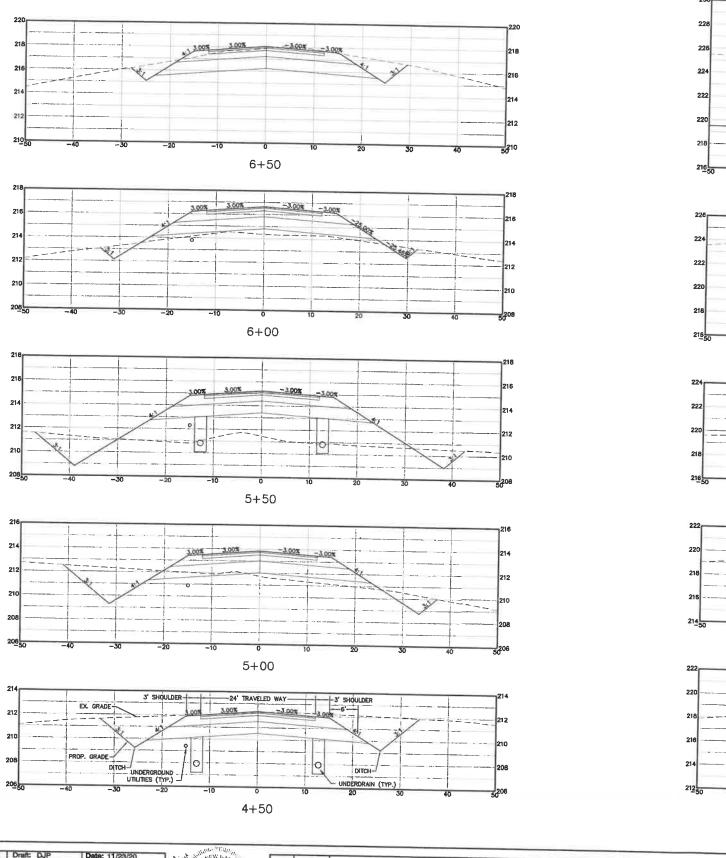

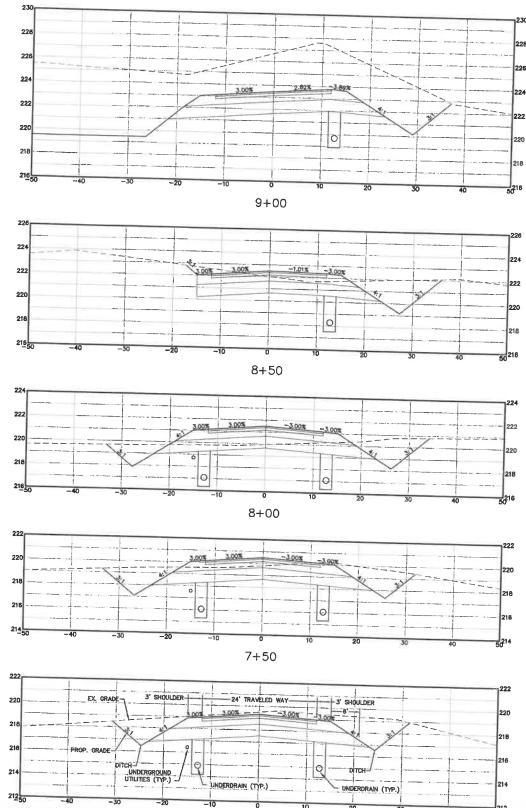

7+00

GRAPHIC SCALE ( IN FEET )

1 inch = 50 ft Horiz.

1 inch = 5 ft Vert.


Design: BWG Draft: DJP Date: 11/23/20
Checked: BWG Scale: AS SHOWN Project No.: 19176.1
Drawing Name: 19175-PLAN.dwg
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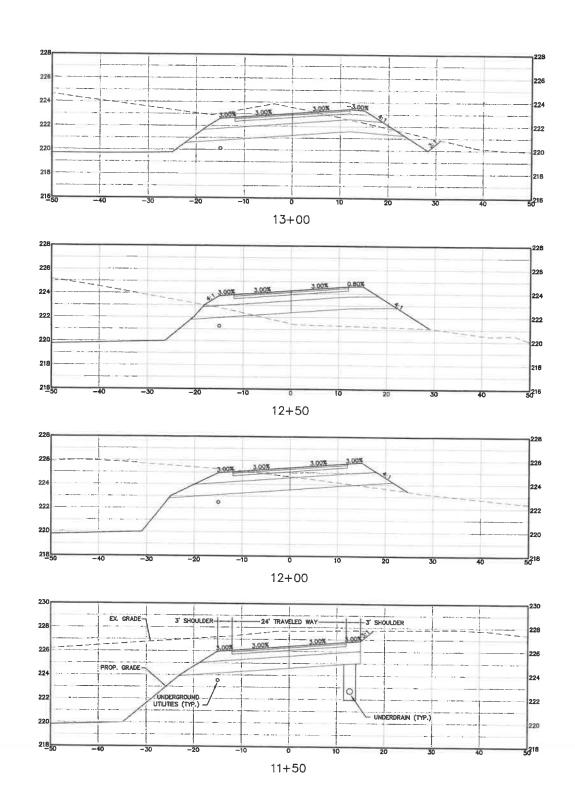



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Jones & Beach Engineers, Inc. 85 Portsmouth Ave.
PO Box 219
Strathem, NH 03885
Civil Engineering Services
E-MAIL: JBE@ Setuices 603-772-4746 FAX: 603-772-0227 E-MAIL: JBE@JONESANDBEACH.COM

Plan Name:	ROADWAY CROSS-SECTIONS
Project:	VIOLETTE ESTATES FREMONT, NH
Owner of Record:	HERITAGE FARM TRUST PO BOX 212, NEWFIELDS, NH 03856





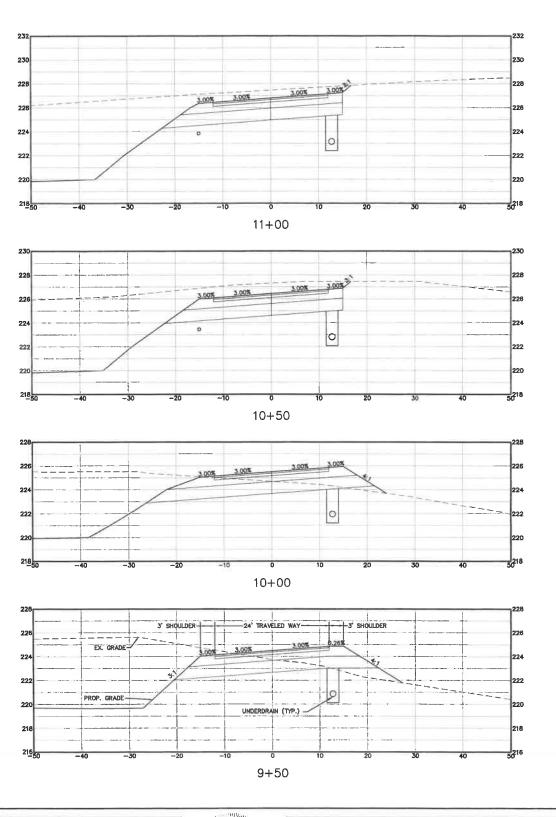

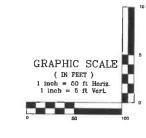Design: 8WG Draft: DJP Date: 11/23/20
Checked: 8WG Scale: AS SHOWN Project No.:19175.1
Drawing Name: 19175-PLAN.dwg

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Jones & Beach Engineers, Inc.

Strethem, NH 08885

Some & Beach Engineers, Inc.

Esponsmouth Ave. Civil Engineering Services
FAX: 603-772-0227

E-MAIL: JBE@JONESANDBEACH.COM

Plan Name:	ROADWAY CROSS-SECTIONS
Project:	VIOLETTE ESTATES FREMONT, NH
Owner of Record:	HERITAGE FARM TRUST PO BOX 212, NEWFIELDS, NH 03856

DRAWING No.

X3

SHEET 17 OF 24

JBE PROJECT NO. 19175.1


LEGEND

EXISTING ----200----


DESCRIPTION DESCRIPTION
PROPERTY LINES
MAJOR CONTOUR
MINOR CONTOUR
EDGE OF PAYEMENT
SINGLE WHITE LINE
DOUBLE YELLOW LINE
STONEWALL
TREELINE
IPON BIDE (BON BOO)


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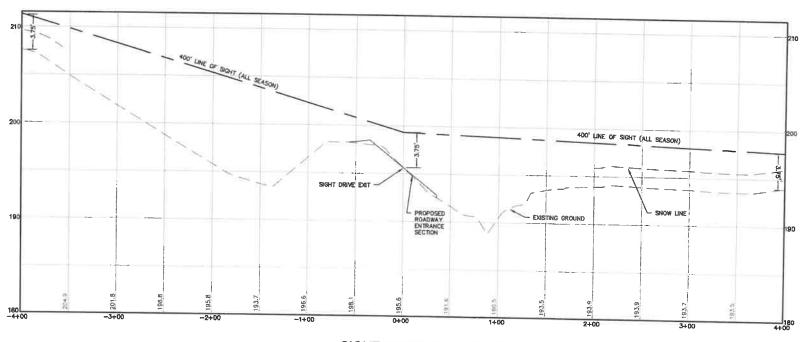
IRON PIPE/IRON ROD DRILL HOLE STONE/GRANITE BOUND FRESHWATER WETLANDS UTILITY POLE

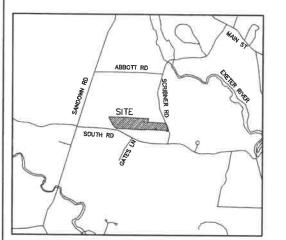


LOCUS SCALE: 1"=2000"



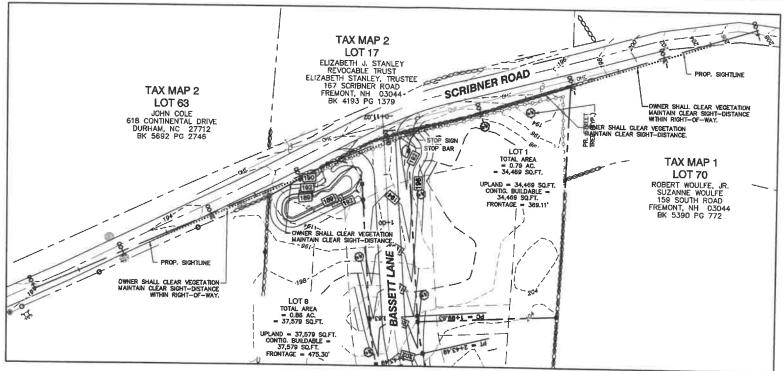

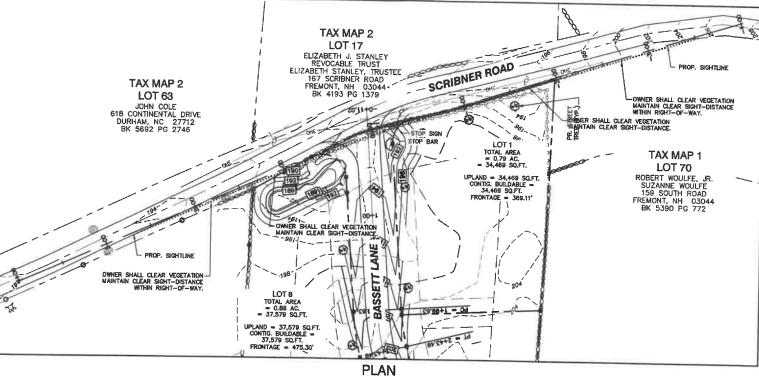

SIGHT DISTANCE PROFILE

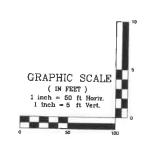

TRAFFIC CONTROL SCHEDULE

30" WHITE ON RED CHANNEL

DESCRIPTION

MOUNT TYPE

MOUNT

7'-0"

REMARKS

REFLECTORIZED SIGN

SIZE OF SIGN WIDTH HEIGHT

30°

SIGN

STOP

NUMBER

R1-1

Design: BWG		Date: 11/23/20
Checked: BWG	Scale: AS SHOWN	Project No.: 19175.1
Drawing Name:	19175-PLAN.dwg	

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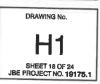



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REV.	DATE	REVISION	BY

1/		De	signed and Pro	duced i	n NH		
B Jo	nes	&	Beach	ı E	nginee	rs,	Inc.
85 Portsmouth Ave. PO Box 219 Stratham, NH 03885	Civil	Eng	ineering	Sem	ices	803 AX: 803	-772-4746 -772-0227

E-MAIL: JBE@JONESANDBEACH.COM

Plan Name:	HIGHWAY ACCESS PLAN	
Project:	VIOLETTE ESTATES FREMONT, NH	
Owner of Record:	HERITAGE FARM TRUST PO BOX 212, NEWFIELDS, NH 03856	



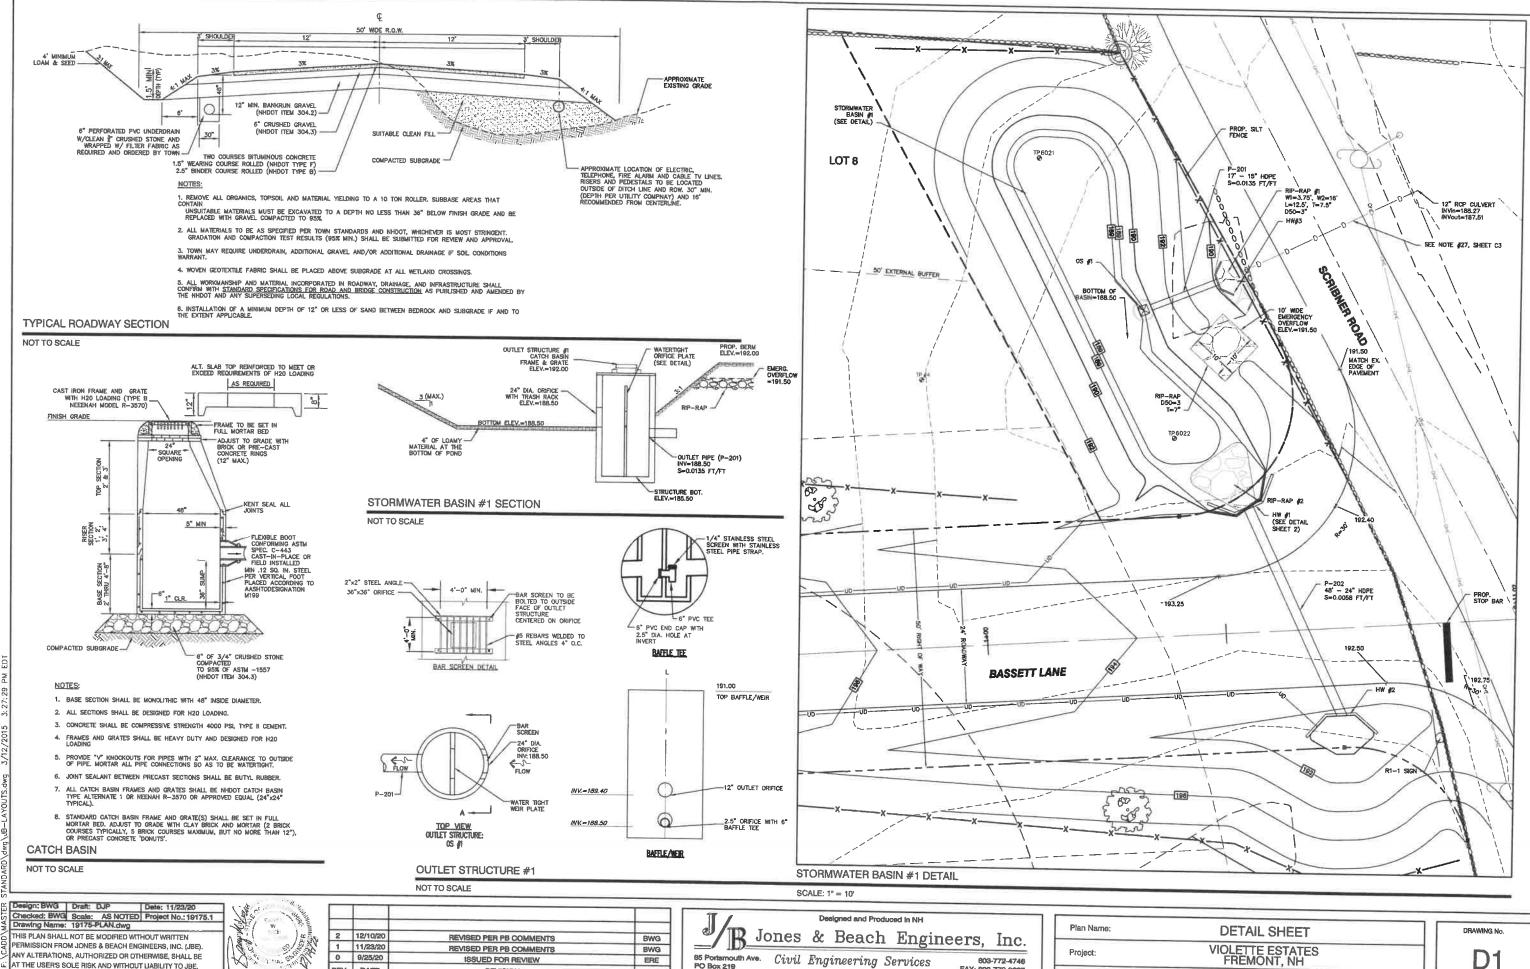

Stratham, NH 03885

E-MAIL: JBE@JONESANDBEACH.COM

AT THE USER'S SOLE RISK AND WITHOUT LIABILITY TO JBE.




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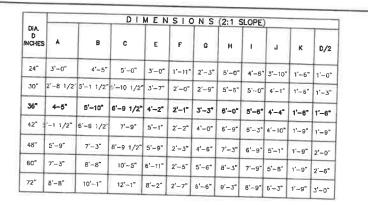
Fian Name;	DETAIL SHEET	
Project:	VIOLETTE ESTATES FREMONT, NH	
Owner of Record:	HERITAGE FARM TRUST PO BOX 212, NEWFIELDS, NH 03856	


**D1** SHEET 19 OF 24 JBE PROJECT NO. 19175.1


		TRA	FFIC	CONTROL	SCHED	ULE	
SIGN NUMBER	SIGN		F SIGN HEIGHT	DESCRIPTION	MOUNT TYPE	MOUNT HEIGHT	REMARKS
R1-1	STOP	30"	30"	WHITE ON RED	CHANNEL	7'-0"	REFLECTORIZED SIGN

\*MOUNTING HEIGHT IS MEASURED FROM BOTTOM OF SIGN



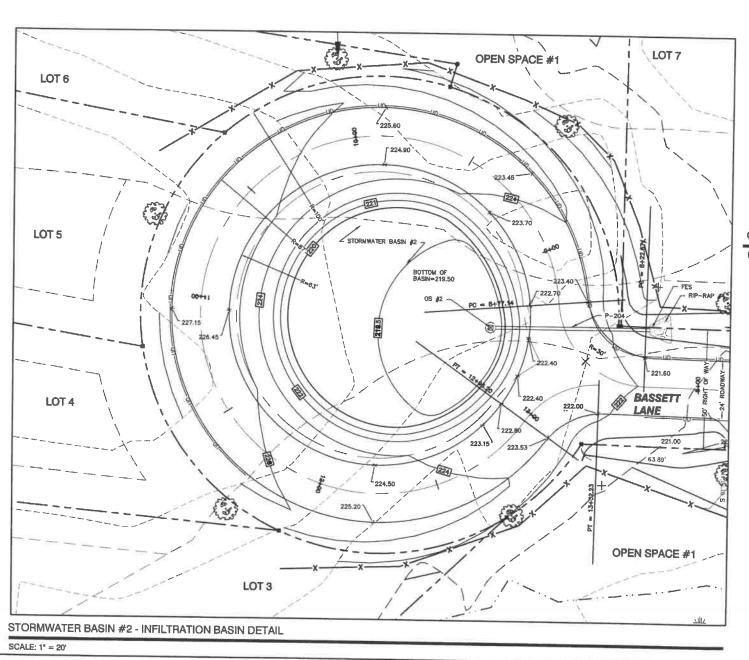


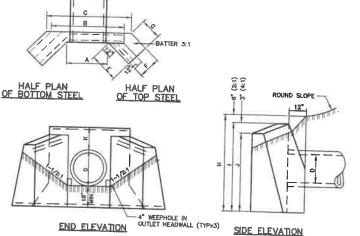


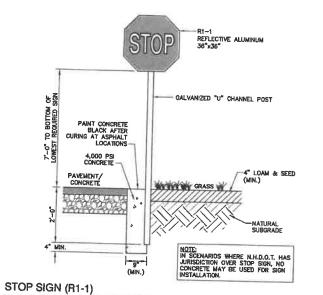

NOT TO SCALE

CONCRETE HEADWALL WITH WINGWALLS NOT TO SCALE

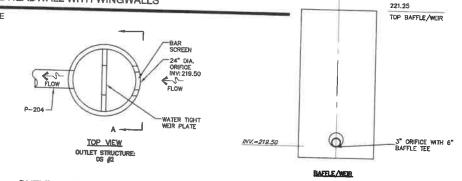

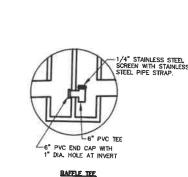

OUTLET STRUCTURE #2

NOT TO SCALE PROP. BERM ELEV.=222.25 WATERTIGHT ORIFICE PLATE (SEE DETAIL) PLANT BASIN W/ 24" DIA. ORIFICE WITH TRASH RACK ELEV.=219.50 2"x2" STEEL ANGLE -24" ORIFICE 4" OF LOAMY MATERIAL AT THE BOTTOM OF POND OUTLET PIPE (P-204) INV=219.50 S=0.0076 FT/FT STORMWATER BASIN #2 SECTION

BAR SCREEN TO BE BOLTED TO OUTSIDE FACE OF OUTLET STRUCTURE CENTERED ON ORIFICE BAR SCREEN DETAIL

NOT TO SCALE

Dealgn: BWG | Draft: DJP Checked: BWG Scale: AS NOTED Project No.:19175.1
Drawing Name: 19175-PLAN.dwg

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85 Portsmouth Ave. PO Box 219 Strathern, NH 03885			ineering	Services	603	-772-4746 -772-0227

Plan Name:	DETAIL SHEET	
Project:	VIOLETTE ESTATES FREMONT, NH	
Owner of Record:	HERITAGE FARM TRUST PO BOX 212, NEWFIELDS, NH 03856	

DRAWING No. SHEET 20 OF 24 JBE PROJECT NO. 19175.1 6" SAND FILTER TO BE PLACED BELOW THE GEOTEXTILE FOR THE

SIZE OF STONE (INCHES) FROM TO

SECTION A-A

PIPE OUTLET TO WELL-DEFINED

1.5 d50

0.5 d50

- NON-EMERGENCY DRIVEWAY AREA SHALL HAVE A BASE MINIMUM OF 6" BANK RUN GRAVEL WITH A SURFACE MINIMUM OF 2" OF BINDER COURSE ROLLED (NHDOT TYPE B) ASPHALT

DRIVEWAY SURFACE OPTIONS:

EMERGENCY DRIVEWAY AREA SHALL AT A MINIMUM HAVE A BASE OF 6" BANK RUN GRAVEL WITH A SURFACE OF 4" OF PROCESSED GRAVEL.

- ALL DRIVEWAYS SHALL BE POSITIONED NO CLOSER THAN 10' FROM PROPERTY SIDELINE.
- 7. DRIVEWAY WIDTH SHALL BE MINIMUM 10' AND MAXIMUM 14' IN WIDTH WITH 10' RADIUS AT THE EDGE OF PAVEMENT AT STREET.

# NOTES:

- DRIVEWAYS TO CONFORM TO TOWN OF FREMONT DRIVEWAY REGULATIONS UNLESS WAIVED.
- WHERE REQUIRED, CULVERTS MUST BE A MINIMUM OF 30' LONG AND/OR EXTEND AT LEAST 5' FROM EDGE OF PAYEMENT OR GRAVEL. SHOT CULVERTS SHALL HAVE AN HOPE FLARE ATTACHED OR SMILLRLY CONSTRUCTED MATERIAL APPROVED BY THE PLANNING BOARD AND/OR DESCAIPE.
- CULVERTS MAY REQUIRE HEADWALLS BUILT ON EACH END. HEADWALLS SHOULD BE CONSTRUCTED STONE UNLESS OTHERWISE APPROVED BY THE PLANNING BOARD OR ITS OESIONEE. HEADWALL CONSTRUCTION SHALL BE A MINIMUM OF 6" THICK AT TOP AND 18" THICK AT THE BASE.
- 4. A MINIMUM OF 1' COVER OVER ALL CULVERTS IS DESIRED WHERE FEASIBLE.
- 5. DRIVEWAY FLARE SHALL BE NO MORE THAN 22' AT THE ROADWAY.
- ALL DRIVEWAYS SHALL PROVIDE FOR SUFFICIENT TURN-AROUND TO PREVENT BACKING ON TO PUBLIC STREET.
- NO GRADES SHALL BE GREATER THAN 10% WITHOUT FIRE CHIEF APPROVAL.
- DRIVEWAY SHALL INTERSECT ROAD AT 90 DEGREES, UNLESS WAIVED.

# LOAM AREA | PAVED AREA SEE NOTES 1 AND 2 4" COMPACTED LOAM-- PAVEMENT SUITABLE BACKFILL MATERIAL 3/4" CRUSHED STONE BEDDING 6" BELOW PIPE IN EARTH 12" BELOW PIPE IN LEDGE 3'-0" MIN. OR D + 2' (WHICHEVER IS GREATER) NOTES:

- 1. PAVEMENT REPAIR IN EXISTING ROADWAYS SHALL CONFORM TO STREET OPENING REGULATIONS.
- 2. NEW ROADWAY CONSTRUCTION SHALL CONFORM WITH PROJECT AND TOWN SPECIFICATIONS. 3. ALL MATERIALS ARE TO BE COMPACTED TO 95% OF ASTM D-1557.
- DRAINAGE TRENCH

NOT TO SCALE

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NOT TO SCALE

LENGTH OF F.E.S.

SECTION A-A

PIPE OUTLET TO FLAT AREA WITH NO DEFINED CHANNEL

% OF WEIGHT SMALLER THAN THE GIVEN d50 SIZE

2. THE RIP RAP SHALL CONFORM TO THE SPECIFIED GRADATION.

100%

15%

TABLE 7-24-RECOMMENDED RIP RAP GRADATION RANGES THICKNESS OF RIP RAP = SEE SHEET C3 FOR THICKNESS

1. THE SUBGRADE FOR THE GEOTEXTILE FABRIC AND RIP RAP SHALL BE PREPARED TO THE LINES AND GRADES SHOWN ON THE PLANS.

3. GEOTEXTILE FABRICS SHALL BE PROTECTED FROM PUNCTURE OR TEARING DURING THE PLACEMENT OF THE ROCK RIP. DAMAGED AREAS IN THE FABRIC SHALL BE REPAIRED BY PLACING A PECE OF FABRIC OVER THE DAMAGED AREA OR BY COMPLETE REPLACEMENT OF THE FABRIC. ALL OVERLAPS REQUIRED FOR REPAIRS OR JOINING TWO PIECES OF FABRIC SHALL BE A MINIMUM OF 12 INCHES.

4. STONE FOR THE RIP RAP MAY BE PLACED BY EQUIPMENT AND SHALL BE CONSTRUCTED TO THE FULL LAYER THICKNESS IN ONE OPERATION AND IN SUCH A MANNER AS TO PREVENT SEGREGATION OF THE STONE SIZES. OUTLETS TO A DEFINED CHANNEL SHALL HAVE 2:1 OR FLATTER SIDE SLOPES AND SHOULD BEGIN AT THE TOP OF THE CULVERT AND TAPER DOWN TO THE CHANNEL BOTTOM THROUGH THE LENGTH OF THE APRON.

6. MAINTENANCE: THE OUTLET PROTECTION SHOULD BE CHECKED AT LEAST ANNUALLY AND AFTER EVERY MAJOR STORM. IF THE RIP RAP HAS BEEN DISPLACED, UNDERMINED OR DAMAGED, IT SHOULD BE REPARED IMMEDIATELY. THE CHANNEL IMMEDIATELY BELOW THE OUTLET SHOULD BE CHECKED TO SEE THAT EROSION IS NOT OCCURRING. THE DOMESTREAM CHANNEL SHOULD BE KEPT CLEAR OF COSTRUCTIONS SUCH AS FALLEN TREES, DEBNIS, AND SEDMENT THAT COULD CHANGE FLOW PATTERNS AND/ON TALINATER DEPTHS ON THE PIPES. REPAIRS MUST BE CARRIED OUT IMMEDIATELY TO AVOID ADDITIONAL DAVAGE TO OUTLET PROTECTION.

d50

0.33 d50

d50 SIZE= SEE SHEET C3 FOR d50 SIZING



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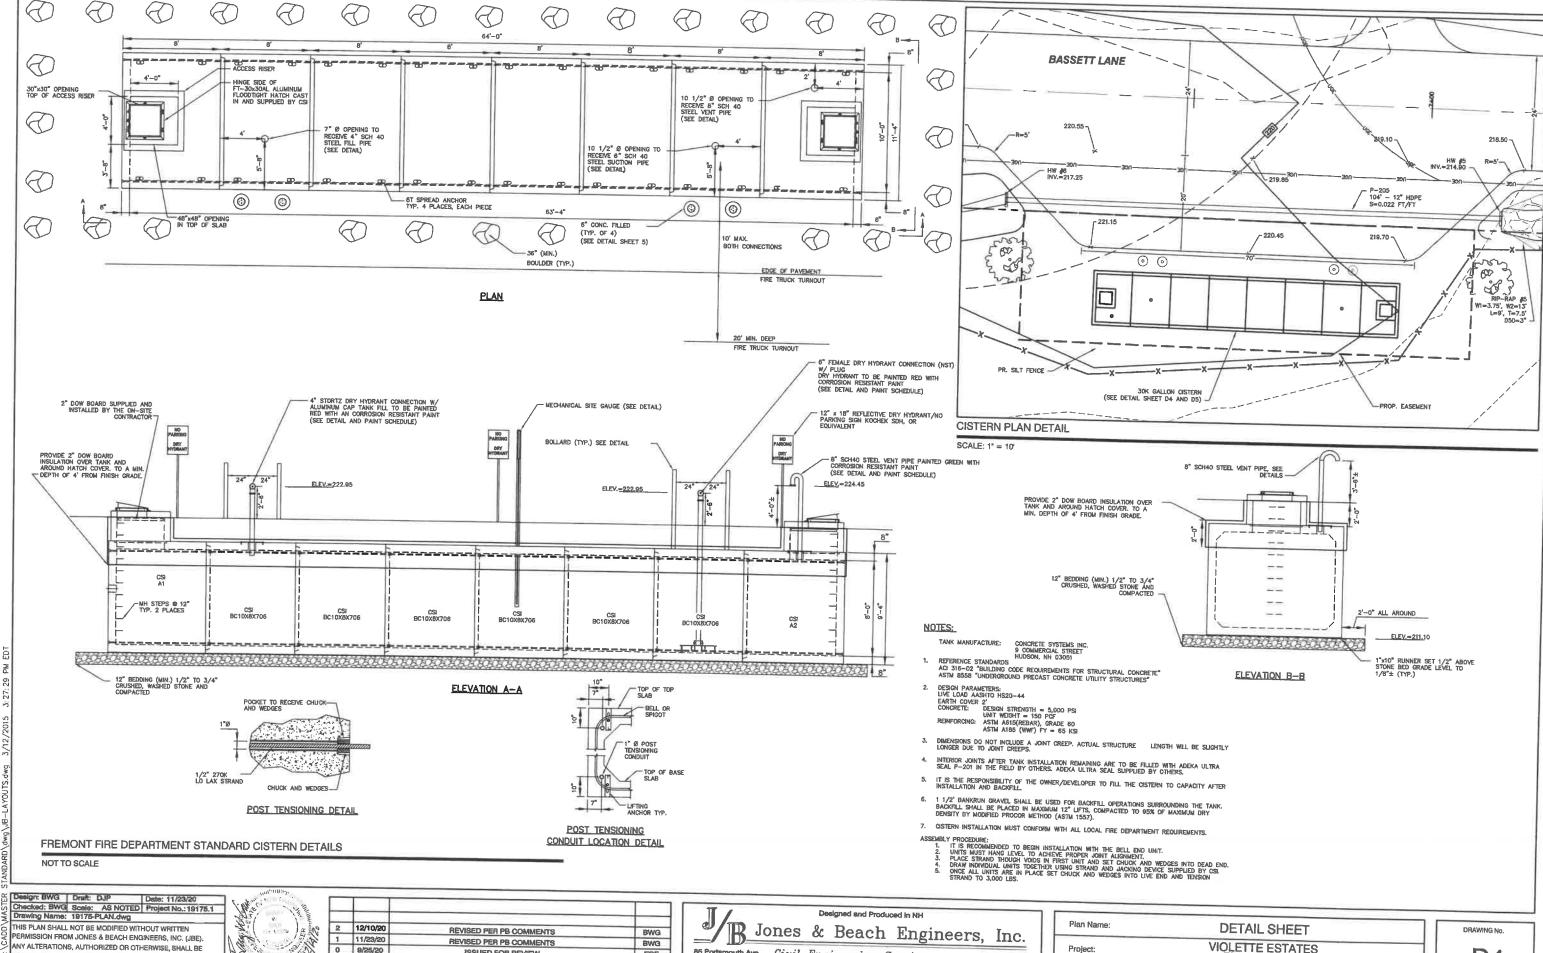
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h Engineers, Inc.	Plan Name:	DETAIL SHEET		
Services 603-772-4748	Project:	VIOLETTE ESTATES FREMONT, NH		
FAX: 603-772-0227 E-MAIL: JBE@JONESANDBEACH.COM	Owner of Record:	HERITAGE FARM TRUST		

DRAWING No. SHEET 21 OF 24 JBE PROJECT NO. 19175.1

7. SEE RIP RAP TABLE SHEET C3 FOR OUTLET PROTECTION SIZING.

RIP RAP OUTLET PROTECTION APRON



AT THE USER'S SOLE RISK AND WITHOUT LIABILITY TO JBE.

0 9/25/20 ISSUED FOR REVIEW ERE REV. DATE BY

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Stratham, NH 03885

VIOLETTE ESTATES FREMONT, NH Project: HERITAGE FARM TRUST PO BOX 212, NEWFIELDS, NH 03856 Owner of Record:

**D4** SHEET 22 OF 24 JBE PROJECT NO. 19175.1

# CISTERN SPECIFICATIONS:

- 1. THE CISTERN SHALL BE DESIGNED TO BE TROUBLE FREE, AND IT SHALL BE DESIGNED TO LAST 50 YEARS.
- THE MINIMUM CAPACITY SHALL BE 30,000 GALLONS. DEPENDING ON THE DEVELOPMENT LAYOUT/CONFIGURATION. ADDITIONAL GALLON REQUIREMENTS MAY BE IMPOSED AT THE DISCRETION OF THE FIRE CHIEF. ALL EXCEPTIONS, ADDITIONS, OR DELETIONS WILL BE IN WRITING.
- THE SUCTION CAPACITY SHALL BE CAPABLE OF DELIVERING 1,000 GALLONS PER MINUTE (GPM) FOR THREE-QUATERS OF THE CISTERN CAPACITY.
- 4. THE ENTIRE CISTERN AND APPURTENANCES SHALL BE RATED FOR HS-20 HIGHWAY LOADING.
- 5. DRAWINGS OF THE DESIGN ARE FOR ESTIMATING GENERAL REQUIREMENT AND DESIGN PURPOSES ONLY AND ARE NOT INTENDED FOR USE AS DESIGN, FINAL MANUFACTURER CUT SHEETS WILL BE REQUIRED TO BE APPROVED BY THE FIRE CHIEF PRIOR TO CISTERN CONSTRUCTION. NO OCCUPANCY PERMITS WILL BE ISSUED UNTIL THE FIRE CISTERN IS INSTALLED, INSPECTED AND APPROVED BY THE FREMONT FIRE DEPT.
- 6. EACH CISTERN SHALL BE DESIGNED, SIGHTED TO THE PARTICULAR LOCATION, STAMPED BY A REGISTERED ENGINEER, AND APPROVED BY THE FIRE CHIEF, OR HIS DESIGNEE.
- ALL PIPING SHALL BE ASTM SCHEDULE 40 STEEL PIPING/STEEL LOCATED BELOW GRADE AND IN THE TANK SHALL BE COATED WITH CIM 1000.
- 8. THE FINAL SUCTION CONNECTION SHALL BE SIX INCH FEMALE CONNECTION WITH NST THREADS AND CAP, THE SUCTION PIPE SHALL BE BRACED TO ENSURE DURABULTY DURING PUMPING OPERATIONS. THE FIRE CHIEF SHALL APPROVE BRACE CONNEGURATION AND INSTALLATION. THE SUCTION PIPE CONNECTION SHALL BE 30" ABOVE THE LEVEL OF THE VEHICLE PAD TO THE CENTER OF THE CONNECTION WHERE VEHICLE WHEELS WILL BE LOCATED WHEN THE CISTERN IS IN
- 9. THE FILLER CONNECTION SHALL BE INSTALLED AS SPECIFIED ON THE DETAIL. THIS FITTING SHALL BE 30° ABOVE FINISH GRADE AND FACE. THE ROAD. A MANIHOLES WITH COVER MILL BE LOCATED ON TOP OF THE CISTENN AS SPECIFED IN THE DETAIL. THE CONTINUATION OF THIS MANIHOLE SHALL ALLOW THE UNIT TO BE SECURED WITH TWO PADLOCKS AND SHALL BE APPROVED BY THE FIRE CHIEF. THE PADLOCKS WILL BE SUPPLIED BY THE FIRE
- 10. THE DISTANCE FROM THE BOTTOM OF THE SUCTION PIPE TO THE PUMPER CONNECTION SHALL NOT EXCEED EIGHTEEN FEET VERTICAL.
- 11. ALL HORIZONTAL SUCTION PIPING SHALL SLOPE SLIGHTLY UPHILL TOWARD THE PUMPER CONNECTION.
- 12. BEDDING FOR THE CISTERN SHALL CONSIST OF A MINIMUM OF TWELVE INCHES OF 3/4" TO 1 1/2" WASHED STONE, COMPACTED. NO FILL SHALL BE USED UNDER THE STONE, OVER EXCAVATION SHALL BE FILLED WITH THE SAME STONE BEDDING MATERIAL.
- 13. ALL BACK FILL MATERIALS SHALL BE SCREENED GRAVEL WITH NO STONES LARGER THAN SIX INCHES AND SHALL BE COMPACTED TO 95 PERCENT OF 1TS ORIGINAL VOLUME IN ACCORDANCE WITH ASTM D 1557. 16. THE TOP OF CISTERN SHALL BE INSULATED WITH VERMIN RESISTANT FOAM INSULATION AND TWO FEET OF BACK FILM HA MINIMULY WEIGHT OF 120 PCF, COMPACTED. FOAM USED FOR THIS INSTALLATION SHALL BE CLOSED CELL POLYMETHANE FOAM WITH AN INSULATION FACTOR OF R=5 PER INCH. ALL BACK FILL SHALL EXTEND THE FEET BEYOND THE EDGE OF THE VEHICLE PAD AND THEN HAVE A MAXIMUM OF 3:1 SLOPE, LOAM AND SEEDED.
- 14. BEFORE ANY BACK FILLING IS DONE THE ENTIRE CISTERN SHALL BE COMPLETED AND INSPECTED BY THE FIRE CHIEF, OR HIS DESIGNEE.
- 15. AFTER BACK FILLING, BOLLARDS OR LARGE STONES SHALL BE PLACED TO PROTECT. THE TANK AND APPURTENANCES.
- 16. THE PITCH OF THE SHOULDER AND VEHICLE PAD FROM THE EDGE OF THE PAVEMENT TO THE PUMPER SUCTION CONNECTION SHALL BE ONE PERCENT TO THREE PERCENT DOWNGRADE.
- 17. THE SHOULDER AND VEHICLE PAD SHALL BE OF A SUFFICIENT LENGTH TO ALLOW CONVENIENT ACCESS TO THE SUCTION CONNECTION WHEN THE PUMPER IS SET AT 45 DEGREES TO THE ROAD. THE SHOULDER AND VEHICLE PAD SECTION SHALL CONSIST OF 3° BITUMINOUS PAYING, REPER TO SITE PLAN FOR REQUIREMENTS.
- 18. TWO CONCRETE FILLED STEEL BOLLARDS SHALL BE PLACED IN A MANNER TO PROTECT THE HYDRANT. THE BASE OF THESE BOLLARDS SHALL EXTEND BELOW THE FROST LINE. THE UPPER PORTION OF THE SOLLARDS SHALL EXTEND FORTY EIGHT INCHES ABOVE THE LEVEL OF THE VEHICLE PAD WHERE VEHICLE WHEELS WILL BE LOCATED WHEN THE CISTERN IS IN USE.
- 19. ALL CONSTRUCTION, BACK FILL, AND GRADING MATERIALS SHALL BE IN ACCORDANCE WITH PROPER CONSTRUCTION PRACTICES AND SHALL BE ACCEPTABLE TO THE FIRE CHIEF.
- 20. THE FIRE CHIEF, OR HIS DESIGNEE (OR REPRESENTATIVE) AND THE ENGINEER'S INSPECTOR WILL BE NOTIFIED BY THE CONTRACTOR TO DESERVE THE FOLLOWING POINTS OF INSTALLATION:

  A. EXCAVATION COMPLETE PRIOR COMPLETED.

  B. CRUSHED STONE INSTALLED AND COMPACTED.

  C. LEAK TEST TO BE COMPLETED PRIOR TO BACK FILLING.

  D. BACK FILLING COMPLETE PRIOR TO PLACEMENT OF INSULATION.

  E. PLACEMENT OF INSULATION.

  F. START AND FINISH OF LEAKAGE TEST.

  G. PIPING MANIWAYS AND BOCLARDS IN PLACE AND PAINTED.

  H. ALL BACKFILLING LOAM, SEED, ETC. COMPLETE WITH TURNOUT GRAVEL IN PLACE AND GRADED.

  F. PAVEMENT COMPLETE, AND BOLLARDS IN PLACE COMPLETE.

- 21. THE FIRE CHIEF, OR HIS DESIGNEE SHALL BE NOTIFIED OF THE DATE THAT SITE WORK IS TO BEGIN.
- 22. ANY EXCEPTION, ADDITIONS, OR DELETIONS ARE DATED AND NOTED BELOW.

  A. CONCRETE MUST HAVE A MINIMUM OF 150 PCF & COMPRESSIVE STRENGTH OF 5,000 PSI,


  B. STONE AND GRAVEL BACK FILL MUST HAVE A MINIMUM OF 120 PCF.

  C. INSTALLATION OF A WISJAL SIGHT GAGE IS TO BE INSTALLED.


  D. AFTER INSTALLATION A 2-WEEK, ZERO LOSS LEAK TEST IS TO BE PERFORMED BY THE TOWN OR ITS DESIGNEE.


# HATCH SUPPLIED AND INSTALLED BY CSI 1/2"Øx6 EXPANSION BOLT (STAINLESS) (TOWN MUST BE ABLE BLUE BOARD TO USE TOWN STANDARD LOCK ON COVER) - BUTYL GASKET EXPANSION ANCHOR

HATCH ATTACHMENT DETAIL SCALE: NONE

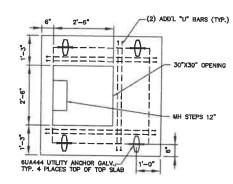

PLAN SCALE: NONE

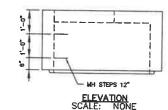

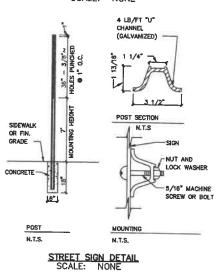

# PAINTING SCHEDULE


EXTERIOR FERROUS METALS AND PVC:


SURFACE PREP-SS PC SP6-COMMERCIAL BLAST CLEANING MANUFACTURER TO BE SHERWIN WILLIAMS OR APPROVED EQUAL.


1st STAGE ~ 1 COAT (6-9 MILS THICK) RECOATABLE EPOXY PRIMER SHERWIN WILLIAMS PART G B87R5 RED OXIDE SHERWIN WILLIAMS PART H B67V5 HARDENER


2nd Stage - 2 Coats (7-13.5 Mils Thick) Macropoxy 646 Sherwin Williams Part a 858-600 Series Sherwin Williams Part B 858/600 Hardener

3rd stage - 1 coat (4.5-8 mils thick) hi solids polyurethane Sherwin Williams part 5 865-350 Semi-Gloss Series Sherwin Williams part t 860/30 hardener

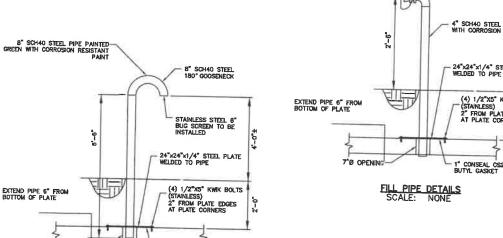


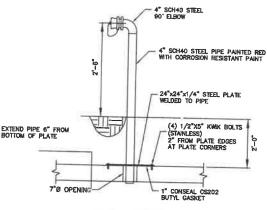


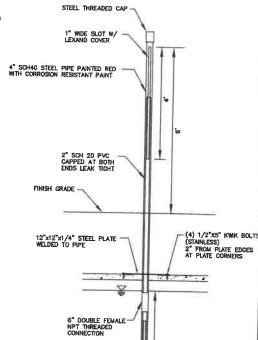

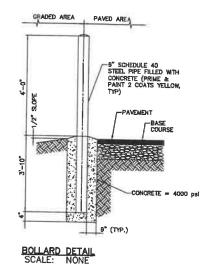

VENT PIPE DETAILS SCALE: NONE

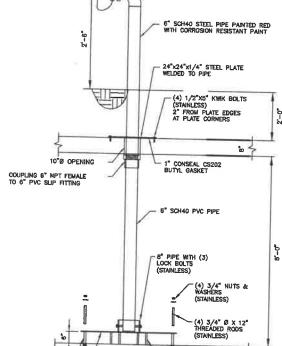

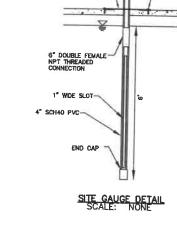

EBR PREMIUM GASKET

SCALE: NONE

(4) 1"X6"X6" LONG STEEL SPACERS (STAINLESS)

(4) 1" ØX6" PIPE SLEEVES

E-MAIL: JBE@JONESANDBEACH.COM

# FREMONT FIRE DEPARTMENT STANDARD CISTERN DETAILS

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JOINT DETAIL SCALE: NONE

B Jones & Beach Engineers, Inc. 85 Postsmouth Ave. Civil Engineering Services PO Box 219 Strathern, NH 03885


Plan Name;	DETAIL SHEET				
Project:	VIOLETTE ESTATES FREMONT, NH				
Owner of Record:	HERITAGE FARM TRUST PO BOX 212, NEWFIELDS, NH 03856				

DRAWING No. **D5** SHEET 23 OF 24 JBE PROJECT NO. 19175.1

Design: BWG | Draft: DJP Checked: BWG Scale: AS NOTED Project No.: 19175.1
Drawing Name: 19175-PLAN.dwg

- TEMPORARY EROSION CONTROL NOTES

  1. THE SMALLEST PRACTICAL AREA OF LAND SHALL BE EXPOSED AT ANY ONE TIME. AT NO TIME SHALL AN AREA IN EXCESS OF 5 ACRES BE EXPOSED AT ANY ONE TIME BEFORE DISTURBED AREAS ARE STABILIZED.
- EROSION, SEDIMENT AND DETENTION MEASURES SHALL BE INSTALLED AS SHOWN ON THE PLANS AND AT LOCATIONS AS REQUIRED, DIRECTED BY THE ENGINEER.
- ALL DISTURBED AREAS (INCLUDING POND AREAS BELOW THE PROPOSED WATERLINE) SHALL BE RETURNED TO PROPOSED GRADES AND ELEVATIONS, DISTURBED AREAS SHALL BE LOAMED WITH A MINIMUM OF 6" OF SCREENED ORGANIC LOAM AND SEEDED WITH SEED MIXTURE" C" AT A RATE NOT LESS THAN 1.10 POUNDS OF SEED PER 1,000 S.F. OF AREA (SH EDS. / AGRE).
- SILT FENCES AND OTHER BARRIERS SHALL BE INSPECTED EVERY SEVEN CALENDAR DAYS AND WITHIN 24 HOURS OF A RAINFALL OF 0.5" OR GREATER. ALL DAMAGED AREAS SHALL BE REPAIRED, AND SEDIMENT DEPOSITS SHALL PERIODICALLY BE REMOVED AND DISPOSED OF.
- AFTER ALL DISTURBED AREAS HAVE BEEN STABILIZED, THE TEMPORARY EROSION CONTROL MEASURES SHALL BE REMOVED AND THE AREA DISTURBED BY THE REMOVAL SMOOTHED AND RE-VEGETATED,
- AREAS MUST BE SEEDED AND MULCHED OR OTHERWISE PERMANENTLY STABILIZED WITHIN 3 DAYS OF FINAL GRADING, OR TEMPORARILY STABILIZED WITHIN 14 DAYS OF THE INITIAL DISTURBANCE OF SOIL ALL AREAS SHALL BE STABILIZED WITHIN 45 DAYS OF INITIAL DISTURBANCE.
- ALL PROPOSED VEGETATED AREAS THAT DO NOT EXHIBIT A MINIMUM OF 85 PERCENT VEGETATIVE GROWTH BY OCTOBER 15, OR WHICH ARE DISTURBED AFTER OCTOBER 15, SHALL BE STABILIZED BY SEZDING AND INSTALLING NORTH AMERICAN GREEN 575 EROSION CONTROL BLANKETS (OR AN EQUIVALENT APPROVED IN WRITING BY THE ENGINEER) EXOPES GREATER THAN 3:1, AND SEZDING AND PLACING 3 TO 4 TONS OF MULCH PER ACRE, SECURED WITH ANCHORED NETTING, ELSEWHERE. THE INSTALLATION OF EROSION CONTROL BLANKETS OR MULCH AND NETTING SHALL NOT OCCUR OVER ACCUMULATED SNOW OR ON FROZEN GROUND AND SHALL BE COMPLETED IN ADVANCE OF THAW OR SPRING MELT EVENTS.
- ALL DITCHES OR SWALES WHICH DO NOT EXHIBIT A MINIMUM OF 85 PERCENT VEGETATIVE GROWTH BY OCTOBER 15, OR WHICH ARE DISTURBED AFTER OCTOBER 15, SHALL BE STABILIZED TEMPORARILY WITH STONE OR EROSION CONTROL BLANKETS APPROPRIATE FOR THE DESIGN FLOW CONDITIONS.
- AFTER OCTOBER 15th, INCOMPLETE ROAD OR PARKING SURFACES, WHERE WORK HAS STOPPED FOR THE WINTER SEASON, SHALL BE PROTECTED WITH A MINIMUM OF 3" OF CRUSHED GRAVEL PER NHDOT ITEM 304.3.
- - a. BASE COURSE GRAVELS HAVE BEEN INSTALLED IN AREAS TO BE PAVED
  - b. A MINIMUM OF 85% VEGETATED GROWTH HAS BEEN ESTABLISHED
  - c. A MINIMUM OF 3" OF NON-EROSIVE MATERIAL SUCH STONE OR RIPRAP HAS BEEN INSTALLED; OR
  - d. EROSION CONTROL BLANKETS HAVE BEEN PROPERLY INSTALLED.
- FUGITIVE DUST CONTROL IS REQUIRED TO BE CONTROLLED IN ACCORDANCE WITH ENV-A 1000, AND THE PROJECT IS TO MEET
  THE REQUIREMENTS AND INTENT OF RSA 430:53 AND AGR 3800 RELATIVE TO INVASIVE SPECIES.
- PRIOR TO BEGINNING CONSTRUCTION, THE CONTRACTOR'S NAME, ADDRESS, AND PHONE NUMBER SHALL BE SUBMITTED TO DES VIA EMAIL (SEE BELOW).
- 13. PRIOR TO CONSTRUCTION, A PHASING PLAN THAT DELINEATES EACH PHASE OF THE PROJECT SHALL BE SUBMITTED. ALL TEMPORARY SEDIMENT BASINS THAT WILL BE NEEDED FOR DEWATERING WORK AREAS SHALL BE LOCATED AND IDENTIFIED ON THIS PLAN.
- 14. IN ORDER TO ENSURE THE STABILITY OF THE SITE AND EFFECTIVE IMPLEMENTATION OF THE SEDIMENT AND EROSION CONTROL MEASURES SPECIFED IN THE PLANS FOR THE DURANDION OF CONSTRUCTION, THE CONTRACTOR SHALL BE IN STRICT COMPULANCE WITH THE FOLLOWING INSPECTION AND MAINTENANCE REQUIREMENTS IN ADDITION TO THOSE CALLED FOR IN THE SWIPPS.
  - A CERTIFIED PROFESSIONAL IN EROSION AND SEDIMENT CONTROL <u>OR</u> A PROFESSIONAL ENGINEER LICENSED IN THE STATE
    OF NEW HAMPSHIRE ("MONITOR") SHALL BE EMPLOYED TO INSPECT THE SITE FROM THE START OF EARTH MOVING
    ACTIVITIES UNTIL THE SITE IS STABLE.
  - b. During this period, the monitor shall inspect the subject site at least once a week, and if possible, during any % inch or greater rain event (i.e. % inch of precipitation or more within a 24 hour period). If unable to be present during such a storm, the monitor shall inspect the site within 24 hours of this event.
  - c. THE MONITOR SHALL PROVIDE TECHNICAL ASSISTANCE AND RECOMMENDATIONS TO THE CONTRACTOR ON THE APPROPRIATE BEST MANAGEMENT PRACTICES FOR EROSION AND SEDMENT CONTROLS REQUIRED TO MEET THE REQUIREMENTS OF RSA 485 A:17 AND ALL APPLICABLE DES PERMIT CONDITIONS.

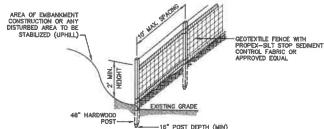

- WOVEN FABRIC FENCE TO BE FASTENED SECURELY TO FENCE POSTS WITH WIRE TIES OR STAPLES.
  FILTER CLOTH SHALL BE FASTENED TO WOVEN WIRE EVERY 24" AT TOP, MID AND BOTTOM AND
  EMBEDDED IN THE GROUND A MINIMUM OF 8" AND THEN COVERED WITH SOIL.
- THE FENCE POSTS SHALL BE A MINIMUM OF 48" LONG, SPACED A MAXIMUM 10' APART, AND DRIVEN A MINIMUM OF 18" INTO THE GROUND.
- WHEN TWO SECTIONS OF FILTER CLOTH ADJOIN EACH OTHER, THE ENDS OF THE FABRIC SHALL BE OVERLAPPED 6", FOLDED AND STAPLED TO PREVENT SEDIMENT FROM BY—PASSING.
- . MAINTENANCE SHALL BE PERFORMED AS NEEDED AND SEDIMENT REMOVED AND PROPERLY DISPOSED OF WHEN IT IS 6° DEEP OR WISIBLE 'BULGES' DEVELOP IN THE SILT FENCE.
- 5. PLACE THE ENDS OF THE SILT FENCE UP CONTOUR TO PROVIDE FOR SEDIMENT STORAGE.
- 6. SILT FENCE SHALL REMAIN IN PLACE FOR 24 MONTHS.

Checked: BWG Scale: AS NOTED Project No.: 19175.1
Drawing Name: 19175-PLAN.dwg

PERMISSION FROM JONES & BEACH ENGINEERS, INC. (JBE).

ANY ALTERATIONS, AUTHORIZED OR OTHERWISE, SHALL BE

AT THE USER'S SOLE RISK AND WITHOUT LIABILITY TO JBE

# SILT FENCE

# NOT TO SCALE

Design: BWG | Draft: DJI



2	12/10/20	REVISED PER PB COMMENTS	BWG
1	11/23/20	REVISED PER PB COMMENTS	BWG
0	9/25/20	ISSUED FOR REVIEW	ERE
REV.	DATE	REVISION	BY

DISTURBED AREA

(UPHILL) -

600 RECO

FLARE ENDS UPHILL TO PROVIDE TRAPPING CAPABILITY AND SEDIMENT STORAGE AREA

7. SILT FENCES SHALL BE REMOVED WHEN NO LONGER NEEDED AND THE SEDIMENT COLLECTED SHALL BE DISPOSED AS DIRECTED BY THE ENGINEER. THE AREA DISTURBED BY THE REMOVAL SHALL BE SMOOTHED AND REVISETATED.

SILT FENCES SHALL BE INSPECTED IMMEDIATELY AFTER EACH RAINFALL AND AT LEAST DAILY DURING PROLONGED RAINFALL ANY REPAIRS THAT ARE REQUIRED SHALL BE DONE IMMEDIATELY.

IF THE FABRIC ON A SILT FENCE SHOULD DECOMPOSE OR BECOME INEFFECTIVE DURING THE EXPECTED LIFE OF THE FENCE, THE FABRIC SHALL BE REPLACED PROMPTLY.

SEDIMENT DEPOSITS SHOULD BE INSPECTED AFTER EVERY STORM EVENT. THE DEPOSITS SHOULD BE REMOVED WHEN THEY REACH APPROXIMATELY ONE HALF THE HEIGHT OF THE BARRIER.

SEDIMENT DEPOSITS THAT ARE REMOVED, OR LEFT IN PLACE AFTER THE FABRIC HAS BEEN REMOVED, SHALL BE GRADED TO CONFORM WITH THE EXISTING TOPOGRAPHY AND VEGETATED.

-MAXIMUM RECOMMENDED UNCONTROLLED SLOPE LENGTH

SEEDING SPECIFICATIONS

- 1. GRADING AND SHAPING
  A. SLOPES SHALL NOT BE STEEPER THAN 2:1 WITHOUT APPROPRIATE EROSION CONTROL MEASURES AS SPECIFIED ON THE PLANS (3:1 SLOPES OR FLATTER ARE PREFERRED).
  B. WHERE MOWING WILL BE DONE, 3:1 SLOPES OR FLATTER ARE RECOMMENDED.

- SEEDBED PREPARATION
   A. SURFACE AND SEEPAGE WATER SHOULD BE DRAINED OR DIVERTED FROM THE SITE TO PREVENT DROWNING
- A SURFACE AND SELFAGE WATER SMULLD BE DIVARIED ON DIVERTED FROM THE SILE TO FREYEN. DIVORTING OR WINTER KILLING OF THE PLANTS.

  B. STONES LARGER THAN 4 INCHES AND TRASH SHOULD BE REMOVED BECAUSE THEY INTERFERE WITH SEEDING AND FUTURE MAINTENANCE OF THE AREA. WHERE FEASIBLE, THE SOIL SHOULD BE TILLED TO A DEPTH OF ABOUT 4 INCHES TO PREPARE A SEEDIBED AND FUTURE WIND INTENSITY OF SOIL. THE SEEDISED SHOULD BE LEFT IN A REASONABLY FIRM AND SMOOTH CONDITION. THE LAST TILLAGE OPERATION SHOULD BE PERFORMED ACROSS THE SLOPE WHEREVER PRACTICAL

3. ESTABLISHING A STAND.

A. LIME AND FERTILIZER SHOULD BE APPLIED PRIOR TO OR AT THE TIME OF SEEDING AND INCORPORATED INTO THE SOIL. TYPES AND AMOUNTS OF LIME AND FERTILIZER SHOULD BE BASED ON AN EVALUATION OF SOIL TESTS. WHEN A SOIL TEST IS NOT AVAILABLE, THE FOLLOWING MINIMUM AMOUNTS SHOULD BE APPLIED:

AGRICULTURAL LIMESTONE, 2 TONS PER ACRE OR 100 LBS. PER 1,000 SQ.FT.

NITROGEN(N), 50 LBS. PER ACRE OR 1.1 LBS. PER 1,000 SQ.FT.

PHOSPHATE(P205), 100 LBS. PER ACRE OR 2.2 LBS. PER 1,000 SQ.FT.

PHOSPHATE(P205), 100 LBS. PER ACRE OR 2.2 LBS. PER 1,000 SQ.FT.

POTASH(K20), 100 LBS. PER ACRE OR 2.2 LBS. PER 1,000 SQ.FT.

(NOTE: THIS IS THE EQUIVALENT OF 500 LBS. PER ACRE OF 10–20–20 FERTILIZER OR 1,000 LBS. PER

ACRE OF 5-10-10.)

ACRE OF 5-10-10.)

SEED SHOULD BE SPREAD UNIFORMLY BY THE METHOD MOST APPROPRIATE FOR THE STE. METHODS INCLUDE BROADCASTING, DRILLING AND HYDROSEDING, WHERE BROADCASTING IS USED, COVER SEED WITH .25 INCH OF SOIL OR LESS, BY CULTIPACKING OR RAKING.

C. REFER TO THE "SEEDING GUIDE" AND "SEEDING RATES" TABLES ON THIS SHEET FOR APPROPRIATE SEED MIXTURES AND RATES OF SEEDING. ALL LEGUMES (CROWNVETCH, BIRDSFOOT, TREFOIL AND FLATPEA) MUST BE INCOLUDED WITH THEIR SPECIFIC INDULANT PRIOR TO THEIR INTRODUCTION TO HE SITE.

D. WHEN SEEDED AREAS ARE MULCHED, PLANTINGS MAY BE MADE FROM EARLY SPRING TO EARLY OCTOBER. WHEN SEEDED AREAS ARE NOT MULCHED, PLANTINGS SHOULD BE MADE FROM EARLY SPRING TO MAY 20th OR FROM AUGUST 10th TO SEPTEMBER 1st.

MOLICAL
A. HAY, STRAW, OR OTHER MULCH, WHEN NEEDED, SHOULD BE APPLIED IMMEDIATELY AFTER SEEDING.
B. MULCH WILL BE HELD IN PLACE USING APPROPRIATE TECHNIQUES FROM THE BEST MANAGEMENT PRACTICE
FOR MULCHING. HAY OR STRAW MULCH SHALL BE PLACED AT A RATE OF 90 LBS PER 1000 S.F.

- 5. <u>MAINTENANCE TO ESTABLISH A STAND</u>

  A. PLANTED AREAS SHOULD BE PROTECTED FROM DAMAGE BY FIRE, GRAZING, TRAFFIC, AND DENSE WEED
- GROWTH.

  B. FERTILIZATION NEEDS SHOULD BE DETERMINED BY ONSITE INSPECTIONS. SUPPLEMENTAL FERTILIZER IS
  USUALLY THE KEY TO FULLY COMPLETE THE ESTABLISHMENT OF THE STAND BEGAUSE MOST PERENNIALS
  TAKE 2 TO 3 YEARS TO BECOME FULLY ESTABLISHED.
- C. IN WATERWAYS, CHANNELS, OR SWALES WHERE UNIFORM FLOW CONDITIONS ARE ANTICIPATED, ANNUAL MOWING MAY BE NECESSARY TO CONTROL GROWTH OF WOODY VEGETATION.

USE	SEEDING MIXTURE 1/	DROUGHTY	WELL DRAINED	MODERATELY WELL DRAINED	POORLY DRAINED
STEEP CUTS AND FILLS, BORROW AND DISPOSAL AREAS	A 8 C	FAIR POOR POOR FAIR	GOOD GOOD GOOD EXCELLENT	GOOD FAIR EXCELLENT EXCELLENT	FAIR FAIR GOOD POOR
WATERWAYS, EMERGENCY SPILLWAYS, AND OTHER CHANNELS WITH FLOWING WATER.		G000 G000	GOOD EXCELLENT	GOOD EXCELLENT	FAIR FAIR
LIGHTLY USED PARKING LOTS, ODD AREAS, UNUSED LANDS, AND LOW INTENSITY USE RECREATION SITES.	A B C	G000 G000 G000	GOOD GOOD EXCELLENT	GOOD FAIR EXCELLENT	FAIR POOR FAIR
PLAY AREAS AND ATHLETIC FIELDS. (TOPSOIL IS ESSENTIAL FOR GOOD TURF.)	E F	FAIR FAIR	EXCELLENT	EXCELLENT	2/ 2/

GRAVEL PIT, SEE NH-PM-24 IN APPENDIX FOR RECOMMENDATION REGARDING RECLAMATION OF SAND AND GRAVEL PITS.

1/ REFER TO SEEDING MIXTURES AND RATES IN TABLE BELOW.
27 POORLY DRAINED SOILS ARE NOT DESIRABLE FOR USE AS PLAYING AREA AND ATHLETIC FIELDS.

NOTE: TEMPORARY SEED MIX FOR STABILIZATION OF TURF SHALL BE WINTER RYE OR OATS AT A RATE OF 2.5 LBS. PER 1000 S.F. AND SHALL BE PLACED PRIOR TO OCTOBER 15th, IF PERMANENT SEEDING NOT YET COMPLETE.

# SEEDING GUIDE

	MIXTURE_	POUNDS PER ACRE	POUNDS PER 1,000 Sq. Ft	
	A. TALL FESCUE	20	0.45	
	CREEPING RED FESCUE	20	0.45	
	RED TOP	2	0.05	
	TOTAL	42	0.95	
	B. TALL FESCUE CREEPING RED FESCUE CROWN VETCH OR	15 10 15	0.35 0.25 0.35	
	FLAT PEA	30	0.75	
	TOTAL	40 OR 55	0.95 OR 1.35	
*	C. TALL FESCUE	20	0.45	
	CREEPING RED FESCUE	20	0.45	
	BIRDS FOOT TREFOIL	8	0.20	
	TOTAL	48	1.10	
	D. TALL FESCUE	20	0.45	
	FLAT PEA	30	0.75	
	TOTAL	50	1.20	
	E. CREEPING RED FESCUE 1/	50	1.15	
	KENTUCKY BLUEGRASS 1/	50	1.15	
	TOTAL	100	2.30	
	F. TALL FESCUE 1	150	3,60	
	1/ FOR HEAVY USE ATMLETIC FIELDS CONSULT THE UNIVERSITY OF NEW HAMPSHIRE COOPERATIVE EXTENSION TURF SPECIALIST FOR CURRENT VARIETIES AND SEEDING RATES.			


# **SEEDING RATES**

Designed and Produced in NH

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Stratham, NH 03885



- 1. STONE FOR STABILIZED CONSTRUCTION ENTRANCE SHALL BE 3 INCH STONE, RECLAIMED STONE, OR RECYCLED CONCRETE EQUIVALENT.
  2. THE LENGTH OF THE STABILIZED ENTRANCE SHALL NOT BE LESS THAN SO FEET, 75' WITHOUT A

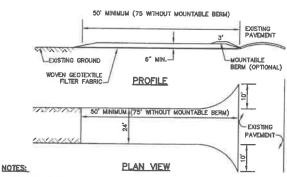- MOULD APPLY.

  3. THICKNESS OF THE STONE FOR THE STABILIZED ENTRANCE SHALL NOT BE LESS THAN 6 INCHES.

  4. THE WOTH OF THE ENTRANCE SHALL NOT BE LESS THAN THE FULL WOTH OF THE ENTRANCE WHERE INGRESS OR BERESS OCCURS, OR 10 FEET, WHICHEVER IS GREATER.

  5. GEOTEXTILE FILTER FABRIC SHALL BE PLACED OVER THE ENTREME AREA PRIOR TO PLACING THE STONE. FILTER FABRIC IS NOT REQUIRED FOR A SHIGLE FAMILY RESIDENTIAL LOT.

  6. ALL SURFACE WATER THAT IS FLOWING TO OR DIVERTED TOWARD THE CONSTRUCTION ENTRANCE SHALL BE PIPED BENEATH THE ENTRANCE. IF PIPING IS IMPRACTICAL, A STONE BERM WITH 5:1 SLOPES THAT CAN BE CROSSED BY VEHICLES MAY BE SUBSTITUTED FOR THE PIPE.

  7. THE ENTRANCE SHALL BE MANTANED IN A CONDITION THAT WILL PREVENT TRACKING OR FLOWING OF SEDIMENT ONTO THE PUBLIC RICHT-OF-WAY. THIS MAY REQUIRE PERIODIC TOP DRESSING WITH ADDITIONAL STONE AS CONDITIONS DEMAND AND REPAIR AND/OR CLEAN OUT OF ANY MEASURES USED TO TRAP SEDIMENT, ALL SEDIMENTS SPILLED, WASHED, OR TRACKED DNTO THE PUBLIC RICHT-OF-WAY. THIS MAY REQUIRE PERIODIC TOP DRESSING WITH ADDITIONAL STONE AS CONDITIONS DEMAND AND REPAIR AND/OR CLEAN OUT OF ANY MEASURES USED TO TRAP SEDIMENT, ALL SEDIMENTS SPILLED, WASHED, OR TRACKED DNTO THE PUBLIC RICHT-OF-WAY. THIS MAY REQUIRE PERIODIC TOP DRESSING WITH ADDITIONAL STONE AS CONDITIONS DEMAND AND REPAIR AND/OR CLEAN OUT OF ANY MEASURES USED TO TRAP SEDIMENT, ALL SEDIMENTS SPILLED, WASHED, OR TRACKED DNTO THE PUBLIC RICHT-OF-WAY MUST BE

# STABILIZED CONSTRUCTION ENTRANCE

NOT TO SCALE

# CONSTRUCTION SEQUENCE

- PRIOR TO THE START OF ANY ACTIVITY, IT IS THE RESPONSIBILITY OF THE SITE'S SITE DEVELOPER (OR OWNER) TO FILE A NOTICE OF INTENT (NO!) FORM WITH THE ENVIRONMENTAL PROTECTION AGENCY (EPA) IN ORDER TO GAIN COVERAGE UNDER THE NODES GENERAL PERMIT FOR STORM WATER DISCHARGES FROM CONSTRUCTION ACTIVITIES. A PRE CONSTRUCTION MEETING IS TO BE HELD WITH ALL DEPARTMENT HEADS PRIOR TO THE START OF CONSTRUCTION, IF REQUIRED BY THE TOWN.
- WETLAND BOUNDARIES ARE TO BE CLEARLY MARKED PRIOR TO THE START OF CONSTRUCTION. AT LEAST A TEMPORARY CULVERT OR ROADBED TO BE IN PLACE PRIOR TO THE START OF CONSTRUCTION.
- 3. CUT AND REMOVE TREES IN CONSTRUCTION AREA AS REQUIRED OR DIRECTED.
- INSTALL SILT FENCING, HAY BALES AND CONSTRUCTION ENTRANCES PRIOR TO THE START OF CONSTRUCTION. THESE ARE TO BE MAINTAINED UNTIL THE FINAL PAYEMENT SURFACING AND LANDSCAPING AREAS ARE ESTABLISHED.
- CLEAR, CUT, GRUB AND DISPOSE OF DEBRIS IN APPROVED FACILITIES. THIS INCLUDES ANY REQUIRED DEMOLITION OF EXISTING STRUCTURES. UTILITIES. ETC.
- CONSTRUCT AND/OR INSTALL TEMPORARY OR PERMANENT SEDIMENT AND/OR DETENTION BASIN(S) AS REQUIRED. THESE FACILITIES SHALL BE INSTALLED AND STABILIZED PRIOR TO DIRECTING RUN-OFF TO THEM.
- STRIP LOAM AND PAVEMENT, OR RECLAIM EXISTING PAVEMENT WITHIN LIMITS OF WORK PER THE RECOMMENDATIONS OF THE PROJECT ENGINEER AND STOCKPILE EXCESS MATERIAL STABILIZE STOCKPILE AS NECESSARY.
- PERFORM PRELIMINARY SITE GRADING IN ACCORDANCE WITH THE PLANS.
- INSTALL THE DRAINAGE SYSTEM FIRST, THEN ANY OTHER UTILITIES IN ACCORDANCE WITH THE PLAN AND DETAILS. ANY CONFLICTS BETWEEN UTILITIES ARE TO BE RESOLVED WITH THE INVOLVEMENT AND APPROVAL OF THE ENGINEER.
- 10. ALL SWALES AND DRAINAGE STRUCTURES ARE TO BE CONSTRUCTED AND STABILIZED PRIOR TO HAVING RUN-OFF DIRECTED TO THEM
- 11. DAILY, OR AS REQUIRED, CONSTRUCT TEMPORARY BERMS, DRAINAGE DITCHES, CHECK DAMS, SEDIMENT TRAPS, ETC., TO PREVENT EROSION ON THE SITE AND PREVENT ANY SILTATION OF ABUTTING WATERS AND/OR PROPERTY.
- 12. PERFORM FINAL FINE GRADING, INCLUDING PLACEMENT OF 'SELECT' SUBGRADE MATERIALS.

- 15. LOAM AND SEED ALL DISTURBED AREAS AND INSTALL ANY REQUIRED SEDIMENT AND EROSION CONTROL FACILITIES (I.e. RIP RAP, EROSION CONTROL BLANKETS, ETC.).
- 16. FINISH PAVING ALL ROADWAYS WITH 'FINISH' COURSE.
- 17. ALL ROADWAYS SHALL BE STABILIZED WITHIN 72 HOURS OF ACHIEVING FINISHED GRADE.
- 18. ALL CUT AND FILL SLOPES SHALL BE SEEDED/LOAMED WITHIN 72 HOURS OF ACHIEVING FINISHED GRADE.
- REMOVE TEMPORARY EROSION CONTROL MEASURES AFTER SEEDING AREAS HAVE BEEN 75%-85% ESTABLISHED AND SITE IMPROVEMENTS ARE COMPLETE. SMOOTH AND RE-VEGETATE ALL DISTURBED AREAS.
- 21. CLEAN SITE AND ALL DRAINAGE STRUCTURES, PIPES AND SUMPS OF ALL SILT AND DEBRI
- 22. INSTALL ALL PAINTED PAVEMENT MARKINGS AND SIGNAGE PER THE PLANS AND DETAILS.
- 23. ALL EROSION CONTROLS SHALL BE INSPECTED WEEKLY AND AFTER EVERY HALF-INCH OF RAINFALL.
- 24. UPON COMPLETION OF CONSTRUCTION, IT IS THE RESPONSIBILITY OF THE CONTRACTOR TO NOTIFY ANY RELEVANT PERMITTING AGENCIES THAT THE CONSTRUCTION HAS BEEN FINISHED IN A SATISFACTORY MANNER.

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Plan Name: EROSION AND SEDIMENT CONTROL DETAILS B Jones & Beach Engineers, Inc. VIOLETTE ESTATES FREMONT, NH Project: HERITAGE FARM TRUST Owner of Record: PO BOX 212, NEWFIELDS, NH 03856

DRAWING No

JBE PROJECT NO. 19175.1