SITE PLAN LIBERTY LANTERN ESTATES

TAX MAP 2 LOT 70 MAIN STREET, FREMONT, NH

SHEET INDEX

CS COVER SHEET

C1 OVERALL EXISTING CONDITIONS PLAN

C1A EXISTING CONDITIONS PLAN

A1 CONDO SITE PLAN

C2 OVERALL SITE PLAN

C2A SITE PLAN

C3 OVERALL GRADING AND DRAINAGE PLAN

C3A-C3B GRADING AND DRAINAGE PLAN

C4 UTILITY PLAN

P1 PLAN AND PROFILE


LANDSCAPING PLAN

H1 HIGHWAY ACCESS PLAN

S1-S4 SEPTIC DETAIL SHEETS

D1-D3 DETAIL SHEETS

F1 FROSION AND SEDIMENT CONTROL DETAILS

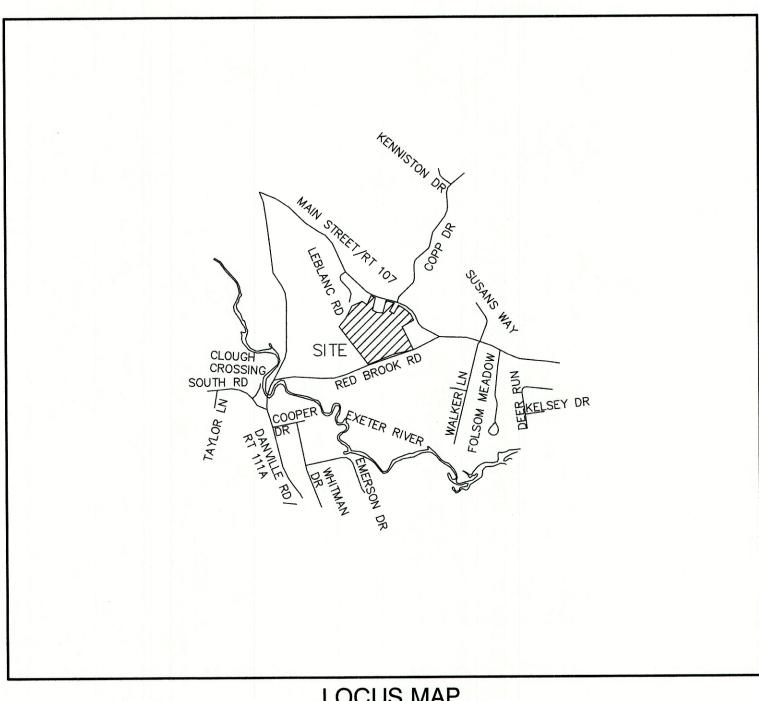

LOCUS MAP SCALE 1" = 2000'

Stratham, NH 03885

PERMITS

(603) 271-3503

TYPE OF PERMIT

NHDES SUBDIVISION PERMIT:

ENVIRONMENTAL SERVICES -

29 HAZEN DRIVE, P.O. BOX 95

SUBSURFACE SYSTEMS BUREAU

NEW HAMPSHIRE DEPARTMENT OF

CONCORD, NEW HAMPSHIRE 03302-0095

SUBMITTED:

EXPIRATION:

STATUS

PERMIT NO.

DATED:

EXPIRATION:

RESPONSIBLE CONSULTANT: EX JONES & BEACH ENGINEERS, INC.

NHDOT DRIVEWAY PERMIT:

NEW HAMPSHIRE DEPARTMENT OF

TRANSPORTATION, DISTRICT SIX

P.O. BOX 740

DURHAM, NEW HAMPSHIRE 03824

SUBMITTED:

(603) 868-1133
RESPONSIBLE CONSULTANTJONES & BEACH ENGINEERS, INC.

USEPA NPDES PHASE II CONSTRUCTION GENERAL PERMIT,
NOTICE OF INTENT (NOI), AND NOTICE OF TERMINATION
(NOT) TO BE FILED IN ACCORDANCE WITH FEDERAL AND
LOCAL REGULATIONS PRIOR TO AND FOLLOWING CONSTRUCTION:
EPA STORMWATER NOTICE PROCESSING CENTER
MAIL CODE 4203M,

US EPA
1200 PENNSYLVANIA AVENUE, NW
WASHINGTON, DC 20460
RESPONSIBLE CONSULTANT:
JONES & BEACH ENGINEERS, INC.

TYPE OF PERMIT STATUS

TOWN OF FREMONT SITE PLAN APPROVAL: SUBMITTED:

TOWN OF FREMONT PLANNING BOARD
295 MAIN STREET
FREMONT, NEW HAMPSHIRE 03044

(603) 895-2226 DATED: RESPONSIBLE CONSULTANT:

JONES & BEACH ENGINEERS, INC. EXPIRATION:

NHDES ALTERATION OF TERRAIN PERMIT:

NEW HAMPSHIRE DEPARTMENT OF

SUBMITTED:

ENVIRONMENTAL SERVICES - WATER DIVISION PERMIT NO. 29 HAZEN DRIVE, P.O. BOX 95 CONCORD, NEW HAMPSHIRE 03302-0095 DATED:

(603) 271-3503
RESPONSIBLE CONSULTANT: EXPIRATION:
JONES & BEACH ENGINEERS, INC.

NHDES INDIVIDUAL SEPTIC PERMIT:
NEW HAMPSHIRE DEPARTMENT OF
ENVIRONMENTAL SERVICES SUBSURFACE SYSTEMS BUREAU
29 HAZEN DRIVE P.O. BOX 95

29 HAZEN DRIVE, P.O. BOX 95
CONCORD, NEW HAMPSHIRE 03302-0095
(603) 271-3503
RESPONSIBLE CONSULTANT:

JONES & BEACH ENGINEERS, INC.

DATED:

EXPIRATION:

PERMIT NO.

PROJECT PARCEL TOWN OF FREMONT TAX MAP 2, LOT 70

OWNER
TIMOTHY AND GERALDINE PALMER
706 MAIN STREET
FREMONT, NH 03044
BK 5673, PG 0101

APPLICANT

HAUS EMILY, LLC

56 WESTVILLE ROAD, UNIT 4

PLAISTOW, NH 03865

TOTAL LOT AREA 1,322,917 SQ. FT. 30.37 ACRES

APPROVED — FREMONT, NH PLANNING BOARD

DATE:

APPLICANT / DEVELOPER

HAUS EMILY, LLC 56 WESTVILLE ROAD, UNIT 4 PLAISTOW, NH 03865 (603) 382-1715

CONTACT: GARY DENSEN

CIVIL ENGINEER / SURVEYOR
JONES & BEACH ENGINEERS, INC.
85 PORTSMOUTH AVENUE
PO BOX 219
STRATHAM, NH 03885
(603) 772-4746
CONTACT: BARRY GIER

EMAIL: BGIER@JONESANDBEACH.COM

OWNER OF RECORD

TIMOTHY AND GERALDINE PALMER
706 MAIN STREET
FREMONT, NH 03044
CONTACT: TIMOTHY GERALDINE

WETLAND CONSULTANT

GZA GEOENVIRONMENTAL, INC. 5 COMMERCE PARK NORTH, SUITE 201 BEDFORD, NH 03110 (603) 430-9282 CONTACT: JAMES LONG

ELECTRIC

EVERSOURCE 740 N COMMERCIAL ST PO BOX 330 MANCHESTER, NH 03105-0330 (800) 662-7764

TELEPHONE

CONSOLIDATED COMMUNICATIONS 1575 GREENLAND ROAD GREENLAND, NH 03840 (603) 427-5525

CABLE TV

COMCAST COMMUNICATION CORPORATION 334-B CALEF HIGHWAY EPPING, NH 03042-2325 (603) 679-5695

Design: BWG Draft: DFP Date: 12/17/21
Checked: BWG Scale: AS NOTED Project No.: 20724
Drawing Name: 20724-PLAN.dwg
THIS PLAN SHALL NOT BE MODIFIED WITHOUT WRITTEN
PERMISSION FROM JONES & BEACH ENGINEERS, INC. (JBE).

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2	12/6/21	REVISED PER PB COMMENTS	BWG
1	11/22/21	REVISED PER TECHNICAL REVIEW	BWG
0	10/6/21	ISSUED FOR REVIEW	BWG
REV.	DATE	REVISION	BY

Designed and Produced in NH

Jones & Beach Engineers, Inc.

85 Portsmouth Ave. Civil Engineering Services

603-772-4746
FAX: 603-772-0227

E-MAIL: JBE@JONESANDBEACH.COM


Plan Name:	COVER SHEET	
Project:	LIBERTY LANTERN ESTATES MAIN STREET, FREMONT, NH	
Owner of Record:	TIMOTHY & GERALDINE PALMER 706 MAIN STREET, FREMONT, NH 03044	

DRAWING No.

CS

SHEET 1 OF 21

JBE PROJECT NO. 20724

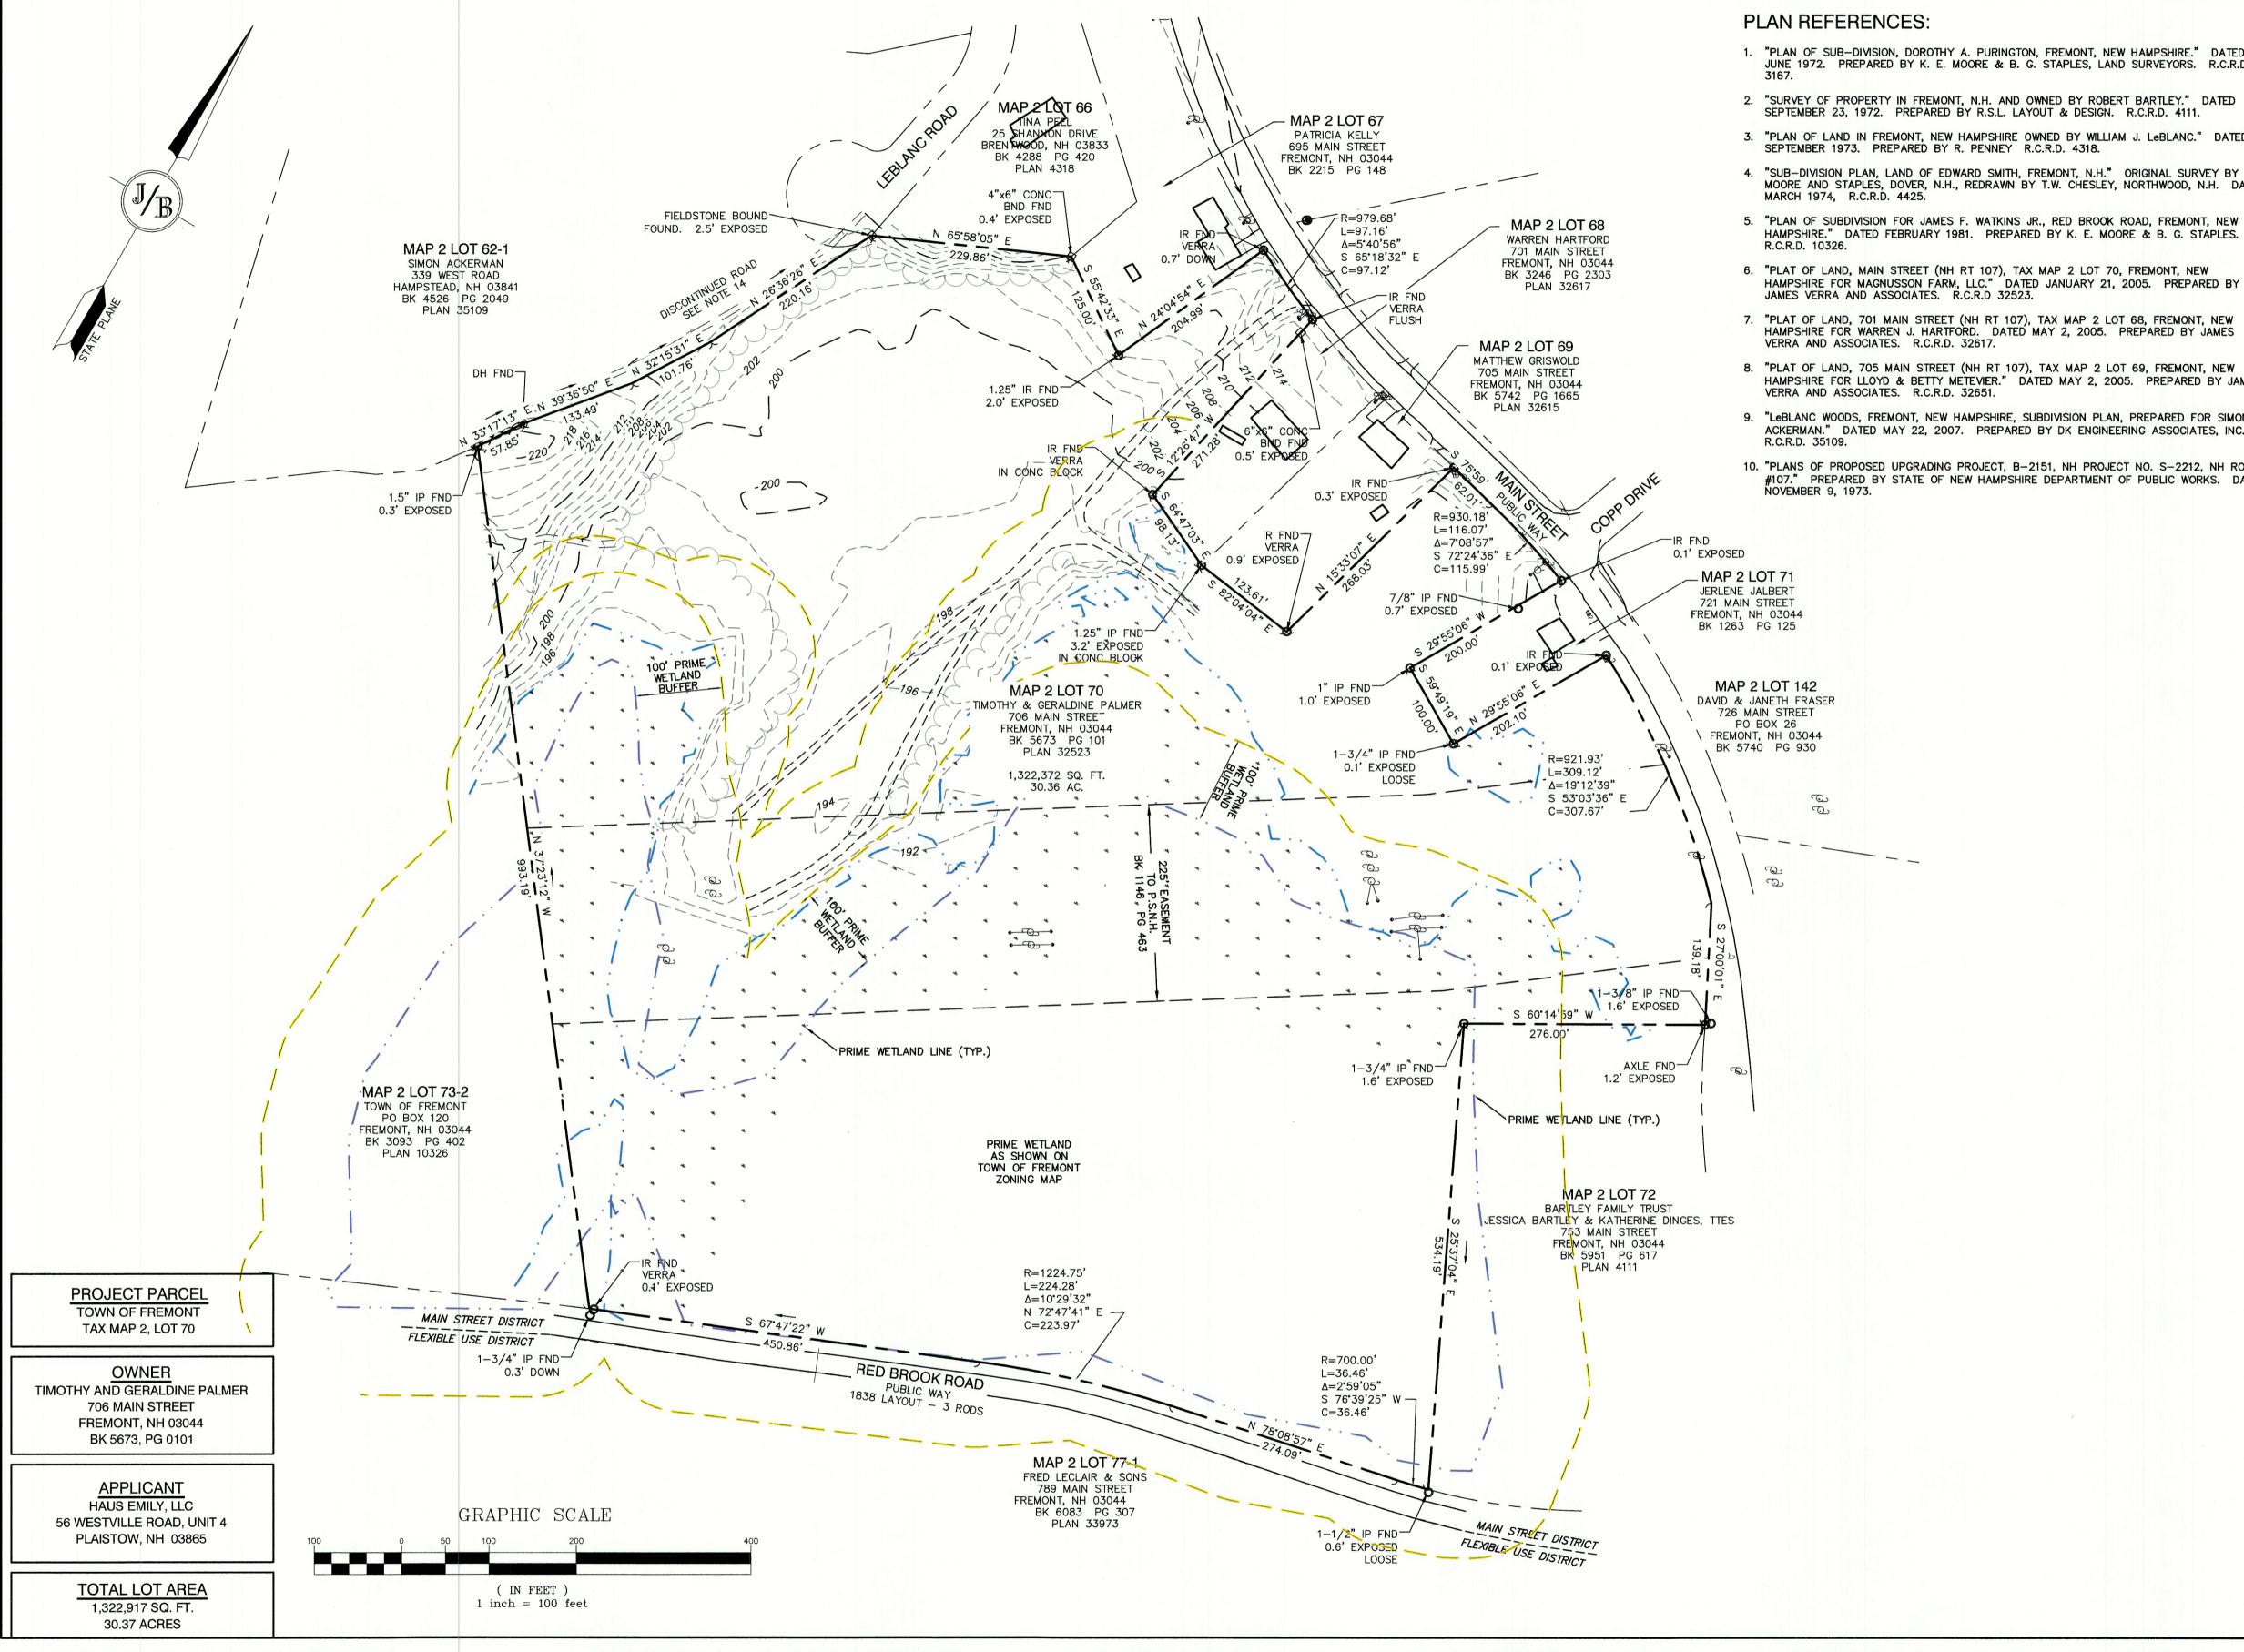

- 1. "PLAN OF SUB-DIVISION, DOROTHY A. PURINGTON, FREMONT, NEW HAMPSHIRE." DATED JUNE 1972. PREPARED BY K. E. MOORE & B. G. STAPLES, LAND SURVEYORS. R.C.R.D.
- 2. "SURVEY OF PROPERTY IN FREMONT, N.H. AND OWNED BY ROBERT BARTLEY." DATED SEPTEMBER 23, 1972. PREPARED BY R.S.L. LAYOUT & DESIGN. R.C.R.D. 4111.
- 3. "PLAN OF LAND IN FREMONT, NEW HAMPSHIRE OWNED BY WILLIAM J. LeBLANC." DATED
- 4. "SUB-DIVISION PLAN, LAND OF EDWARD SMITH, FREMONT, N.H." ORIGINAL SURVEY BY MOORE AND STAPLES, DOVER, N.H., REDRAWN BY T.W. CHESLEY, NORTHWOOD, N.H. DATED
- HAMPSHIRE." DATED FEBRUARY 1981. PREPARED BY K. E. MOORE & B. G. STAPLES.
- 8. "PLAT OF LAND, 705 MAIN STREET (NH RT 107), TAX MAP 2 LOT 69, FREMONT, NEW HAMPSHIRE FOR LLOYD & BETTY METEVIER." DATED MAY 2, 2005. PREPARED BY JAMES
- 9. "LeBLANC WOODS, FREMONT, NEW HAMPSHIRE, SUBDIVISION PLAN, PREPARED FOR SIMON ACKERMAN." DATED MAY 22, 2007. PREPARED BY DK ENGINEERING ASSOCIATES, INC.
- 10. "PLANS OF PROPOSED UPGRADING PROJECT, B-2151, NH PROJECT NO. S-2212, NH ROUTE #107." PREPARED BY STATE OF NEW HAMPSHIRE DEPARTMENT OF PUBLIC WORKS. DATED

CROSSING SOUTH RD

LOCUS SCALE: 1"=2000'

- 1. THE INTENT OF THIS PLAN IS TO SHOW THE EXISTING CONDITIONS OF FREMONT NH TAX MAP 2, LOT 70.
- 2. ZONING DISTRICT: MAIN STREET DISTRICT (AQUIFER PROTECTION DISTRICT) LOT AREA MINIMUM = 87,120 SFLOT FRONTAGE MINIMUM = 200'

BUILDING SETBACKS (MINIMUM): FRONT SETBACK = 50SIDE & REAR SETBACK = 30' WETLAND BUFFER = 100' MAX. BUILDING HEIGHT = 35' MAX. LOT COVERAGE = 15%


AT 1-888-DIG-SAFE.

- 3. THE UTILITY LOCATIONS SHOWN HEREON WERE DETERMINED BY OBSERVED ABOVE GROUND EVIDENCE AND SHOULD BE CONSIDERED APPROXIMATE IN LOCATION ONLY. LOCATION, DEPTH, SIZE, TYPE, EXISTENCE OR NONEXISTENCE OF UNDERGROUND UTILITIES AND/OR UNDERGROUND STORAGE TANKS WAS NOT VERIFIED BY THIS SURVEY. ALL CONTRACTORS SHOULD NOTIFY IN WRITING ALL UTILITY COMPANIES AND GOVERNMENT AGENCIES PRIOR TO ANY EXCAVATION WORK OR CALL DIG-SAFE
- 4. THE SUBJECT PARCEL IS NOT LOCATED WITHIN AN AREA HAVING A SPECIAL FLOOD HAZARD ZONE DESIGNATION BY THE FEDERAL EMERGENCY MANAGEMENT AGENCY, ON FLOOD INSURANCE RATE MAP NOs. 33015C0378E AND 33015C0380E, BOTH WITH EFFECTIVE DATE OF MAY 17, 2005.
- 5. BASIS OF BEARING HORIZONTAL NH STATE PLANE PER PLAN REF 6. VERTICAL - ASSUMED.
- 6. CERTAIN DATA HEREON MAY VARY FROM RECORDED DATA DUE TO DIFFERENCES IN DECLINATION, ORIENTATION, AND METHODS OF MEASUREMENT.
- 7. ALL BOOK AND PAGE NUMBERS REFER TO THE ROCKINGHAM COUNTY REGISTRY OF
- 8. THE TAX MAP AND LOT NUMBERS ARE BASED ON THE TOWN OF FREMONT TAX RECORDS AND ARE SUBJECT TO CHANGE.
- 9. RESEARCH WAS PERFORMED AT THE TOWN OF FREMONT ASSESSOR'S OFFICE. THE ROCKINGHAM COUNTY REGISTRY OF DEEDS, THE NEW HAMPSHIRE DEPARTMENT OF TRANSPORTATION, AND THE NEW HAMPSHIRE STATE ARCHIVES.
- 10. THIS SURVEY IS NOT A CERTIFICATION TO OWNERSHIP OR TITLE OF LANDS SHOWN. OWNERSHIP AND ENCUMBRANCES ARE MATTERS OF TITLE EXAMINATION NOT OF A BOUNDARY SURVEY. THE INTENT OF THIS PLAN IS TO RETRACE THE BOUNDARY LINES OF DEEDS REFERENCED HEREON. OWNERSHIP OF ADJOINING PROPERTIES IS ACCORDING TO ASSESSOR'S RECORDS. THIS PLAN MAY OR MAY NOT INDICATE ALL ENCUMBRANCES EXPRESSED, IMPLIED OR PRESCRIPTIVE.
- 11. ANY USE OF THIS PLAN AND OR ACCOMPANYING DESCRIPTIONS SHOULD BE DONE WITH LEGAL COUNSEL, TO BE CERTAIN THAT TITLES ARE CLEAR, THAT INFORMATION IS CURRENT, AND THAT ANY NECESSARY CERTIFICATES ARE IN PLACE FOR A PARTICULAR CONVEYANCE, OR OTHER USES.
- 12. THE LIMITS OF JURISDICTIONAL WETLANDS WERE DELINEATED BY MR. PETER PERTKAUSKOS UNDER THE SUPERVISION OF MR. JAMES LONG OF GZA GEOENVIRONMENTAL, INC. IN NOVEMBER 2020, AND JANUARY 2021 IN ACCORDANCE WITH THE FOLLOWING GUIDANCE DOCUMENTS: THE CORPS OF ENGINEERS FEDERAL MANUAL FOR IDENTIFYING AND
- DELINEATING JURISDICTIONAL WETLANDS. THE NORTH CENTRAL & NORTHEAST REGIONAL SUPPLEMENT TO THE FEDERAL MANUAL.
- THE CURRENT VERSION OF THE FIELD INDICATORS FOR IDENTIFYING HYDRIC SOILS IN NEW ENGLAND, AS PUBLISHED BY THE NEW ENGLAND INTERSTATE WATER POLLUTION CONTROL COMMISSION AND/OR THE CURRENT VERSION OF THE FIELD INDICATORS OF HYDRIC SOILS IN THE
- UNITED STATES, AS PUBLISHED BY THE USDA, NRCS, AS APPROPRIATE. THE CURRENT NATIONAL LIST OF PLANT SPECIES THAT OCCUR IN WETLANDS, AS PUBLISHED BY THE US FISH AND WILDLIFE SERVICE.
- 13. SURVEY TIE LINES SHOWN HEREON ARE NOT BOUNDARY LINES. THEY SHOULD ONLY BE USED TO LOCATE THE PARCEL SURVEYED FROM THE FOUND MONUMENTS SHOWN AND LOCATED BY THIS SURVEY.
- 14. "OLD ROAD LEADING FROM COUGH BRIDGE TO THE ROCKS ROAD" DISCONTINUED BY TOWN VOTE MARCH 14, 1876. NO LAYOUT FOUND BY THIS OFFICE AT THIS TIME. BOUNDARY ALONG OLD ROAD HELD AS NEAR EDGE, PER RECORD PLANS 3,
- 15. SEE BOUNDARY LINE FINE AGREEMENT BETWEEN MAGNUSSON FARM LLC, WARREN HARTFORD, AND LLOYD & BETTY METEVIER, R.C.R.D BOOK 4459, PAGE 2345, AND PLAN REFERENCES 7 & 8.

Design: BWG | Draft: DFP Date: 12/17/21 Checked: BWG Scale: AS NOTED | Project No.: 20724

Drawing Name: 20724-PLAN.dwg THIS PLAN SHALL NOT BE MODIFIED WITHOUT WRITTEN PERMISSION FROM JONES & BEACH ENGINEERS, INC. (JBE). ANY ALTERATIONS, AUTHORIZED OR OTHERWISE, SHALL BE AT THE USER'S SOLE RISK AND WITHOUT LIABILITY TO JBE.


2	12/6/21	REVISED PER PB COMMENTS	BWG
1	11/22/21	REVISED PER TECHNICAL REVIEW	BWG
0	10/6/21	ISSUED FOR REVIEW	BWG
REV.	DATE	REVISION	BY

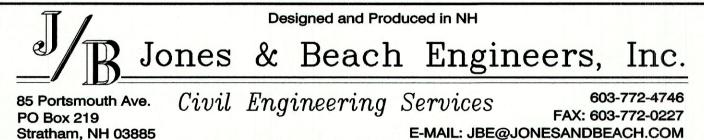

Plan Name:	EXISTING CONDITIONS PLAN
Project:	LIBERTY LANTERN ESTATES MAIN STREET, FREMONT, NH
Owner of Record:	TIMOTHY & GERALDINE PALMER 706 MAIN STREET, FREMONT, NH 03044

SHEET 2 OF 21 JBE PROJECT NO. 20724

DRAWING No.

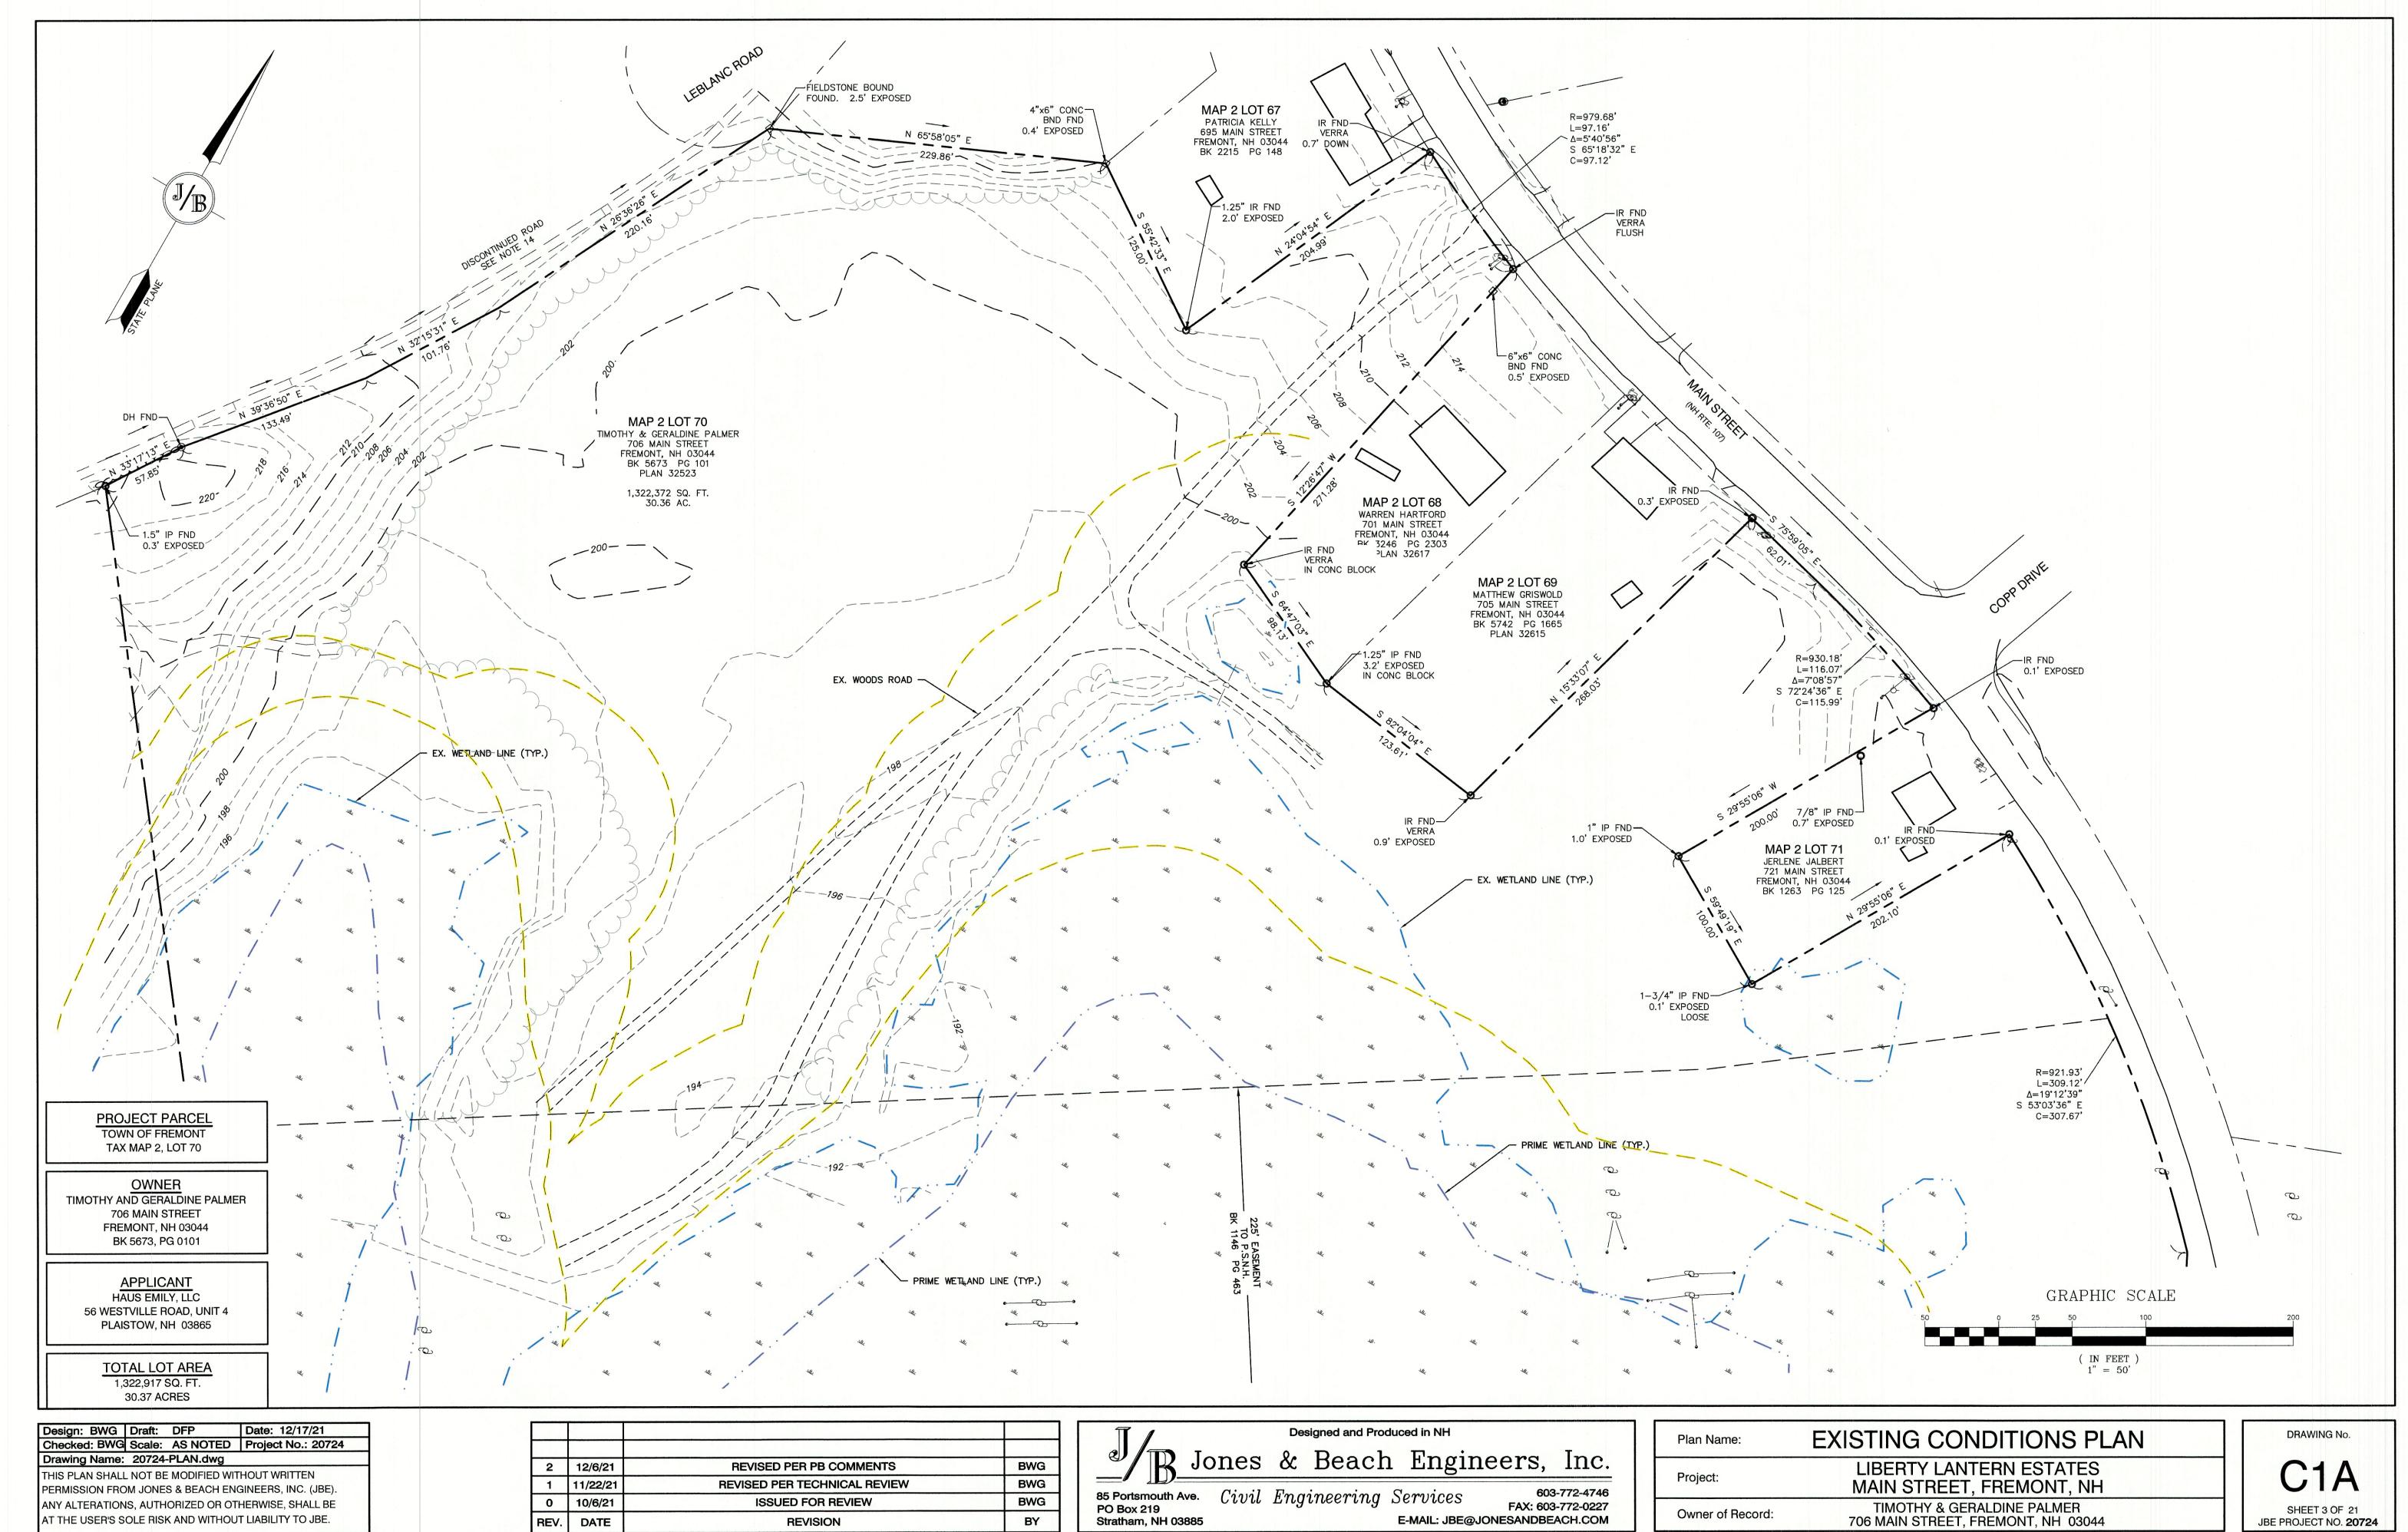

BY

REVISION


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REV. DATE

SHEET 3 OF 21 JBE PROJECT NO. **20724**

Owner of Record:

E-MAIL: JBE@JONESANDBEACH.COM

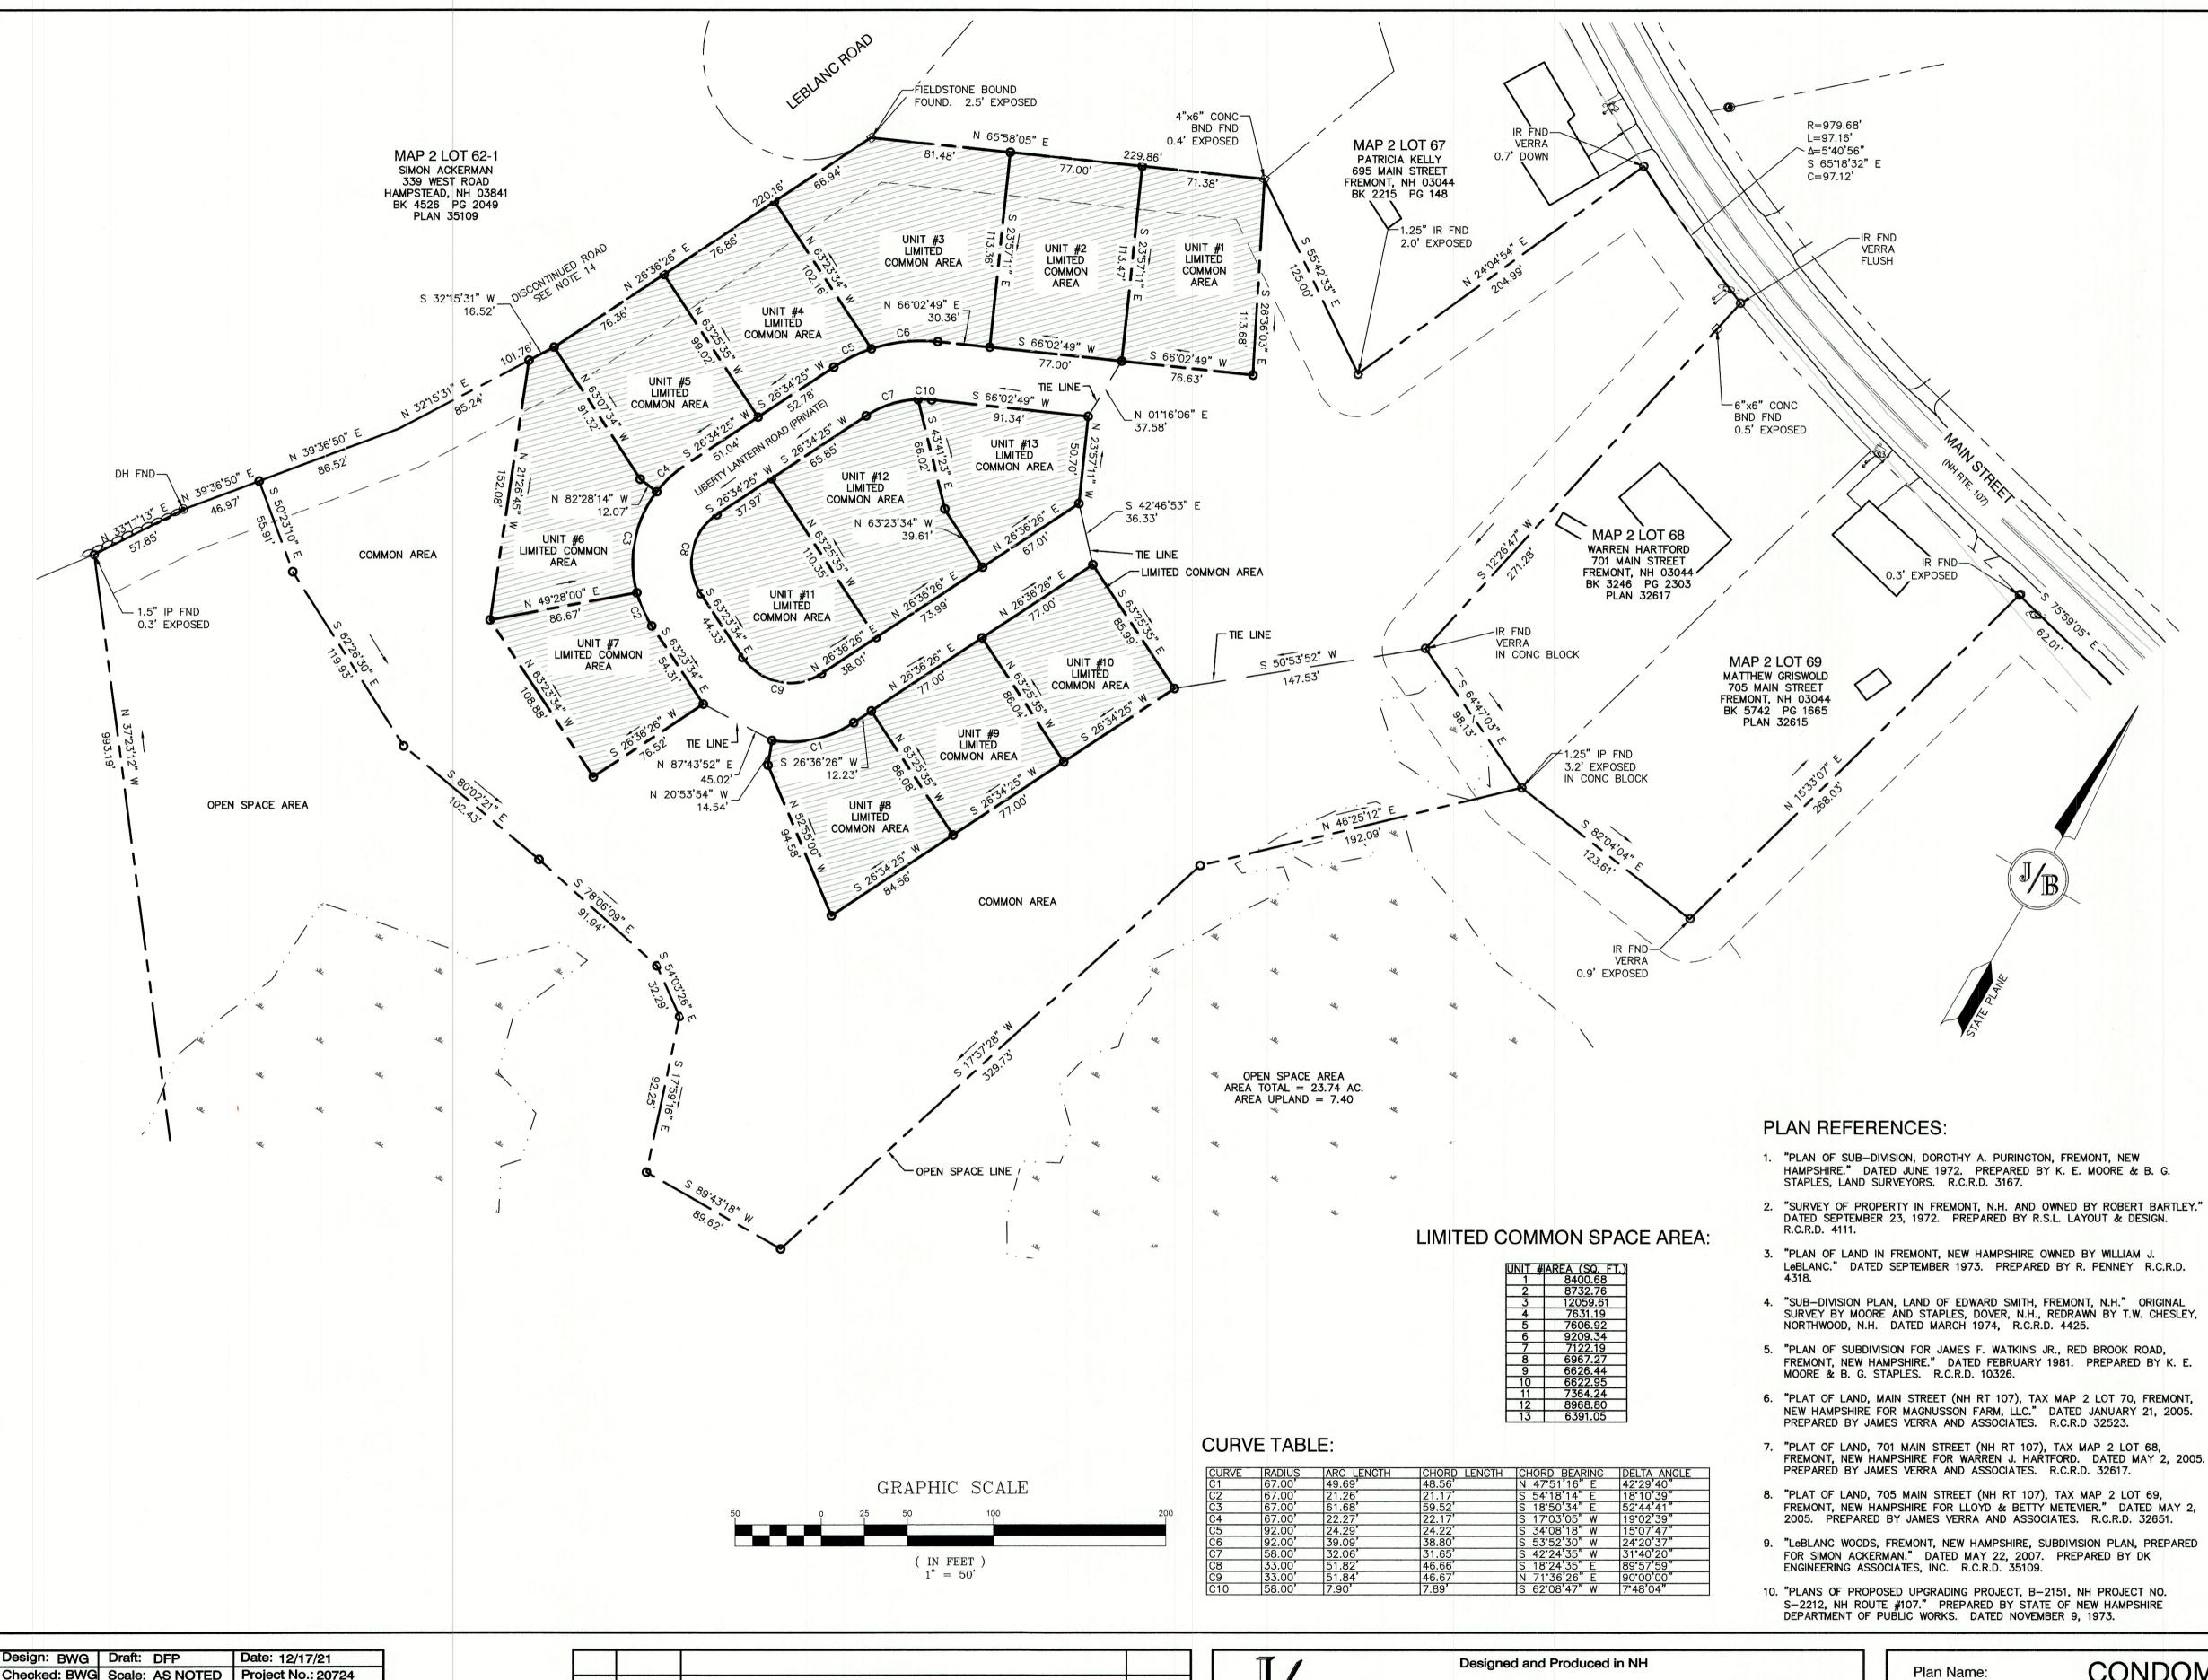

NOTES:

- 1. THE INTENT OF THIS PLAN IS TO SHOW THE PROPOSED CONDOMINIUM SITE PLAN OF FREMONT NH TAX MAP 2, LOT 70 WITH 13 ELDERLY OPEN SPACE UNITS PER ARTICLE 13, SECTION 1031 OF THE TOWN OF FREMONT ZONING ORDINANCE, CONTAINING A MAXIMUM OF 25 BEDROOMS.
- 2. ZONING DISTRICT: MAIN STREET DISTRICT ELDERLY OPEN SPACE (AQUIFER PROTECTION LOT AREA MINIMUM = 87,120 SF (SEE NOTE #4 FOR DENSITY CALCULATIONS)
 - LOT FRONTAGE MINIMUM = 200' BUILDING SETBACKS (MINIMUM): FRONT SETBACK = 50SIDE & REAR SETBACK = 30' WETLAND BUFFER = 100' MAX. BUILDING HEIGHT = 35' MAX. LOT COVERAGE = 15%
- 3. ELDERLY OPEN SPACE REQUIREMENTS: AREA REQUIRED = 20 ACRES PARCEL AREA = 30.37 ACRES FRONTAGE REQUIRED = 50' PARCEL FRONTAGE = 1,709.23'
- 4. ELDERLY OPEN SPACE DENSITY CALCULATION: =(DEVELOPABLE AREA X 0.9) X (2 BEDROOMS / ACRE) $=(606,867 \text{ SF. } \times 0.9) = 546,180 \text{ S.F.} = 12.54 \text{ AC.}$ $=(12.54 \text{ AC } \times 2 \text{ BEDROOMS } / \text{ ACRE}) = 25 \text{ BEDROOMS}$
- 5. ALL UNITS, WITH THE EXCEPTION OF UNIT #1, SHALL BE A MAXIMUM OF 2-BEDROOMS. UNIT 1 SHALL BE 1-BEDROOM.
- 6. BASIS OF BEARING HORIZONTAL NH STATE PLANE PER PLAN REF 6. VERTICAL - ASSUMED.
- 7. CERTAIN DATA HEREON MAY VARY FROM RECORDED DATA DUE TO DIFFERENCES IN DECLINATION, ORIENTATION, AND METHODS OF MEASUREMENT.
- 8. ALL BOOK AND PAGE NUMBERS REFER TO THE ROCKINGHAM COUNTY REGISTRY OF
- 9. THE TAX MAP AND LOT NUMBERS ARE BASED ON THE TOWN OF FREMONT TAX RECORDS AND ARE SUBJECT TO CHANGE.
- 10. RESEARCH WAS PERFORMED AT THE TOWN OF FREMONT ASSESSOR'S OFFICE, THE ROCKINGHAM COUNTY REGISTRY OF DEEDS, THE NEW HAMPSHIRE DEPARTMENT OF

TRANSPORTATION, AND THE NEW HAMPSHIRE STATE ARCHIVES.

- 11. THIS SURVEY IS NOT A CERTIFICATION TO OWNERSHIP OR TITLE OF LANDS SHOWN. OWNERSHIP AND ENCUMBRANCES ARE MATTERS OF TITLE EXAMINATION NOT OF A BOUNDARY SURVEY. THE INTENT OF THIS PLAN IS TO RETRACE THE BOUNDARY LINES OF DEEDS REFERENCED HEREON. OWNERSHIP OF ADJOINING PROPERTIES IS ACCORDING TO ASSESSOR'S RECORDS. THIS PLAN MAY OR MAY NOT INDICATE ALL ENCUMBRANCES EXPRESSED, IMPLIED OR PRESCRIPTIVE.
- 12. ANY USE OF THIS PLAN AND OR ACCOMPANYING DESCRIPTIONS SHOULD BE DONE WITH LEGAL COUNSEL, TO BE CERTAIN THAT TITLES ARE CLEAR, THAT INFORMATION IS CURRENT, AND THAT ANY NECESSARY CERTIFICATES ARE IN PLACE FOR A PARTICULAR CONVEYANCE, OR OTHER USES.
- 13. THE LIMITS OF JURISDICTIONAL WETLANDS WERE DELINEATED BY MR. PETER PERTKAUSKOS UNDER THE SUPERVISION OF MR. JAMES LONG OF GZA GEOENVIRONMENTAL, INC. IN NOVEMBER 2020, AND JANUARY 2021 IN ACCORDANCE WITH THE FOLLOWING GUIDANCE DOCUMENTS:
- THE CORPS OF ENGINEERS FEDERAL MANUAL FOR IDENTIFYING AND DELINEATING JURISDICTIONAL WETLANDS. THE NORTH CENTRAL & NORTHEAST REGIONAL SUPPLEMENT TO THE FEDERAL
- THE CURRENT VERSION OF THE FIELD INDICATORS FOR IDENTIFYING HYDRIC SOILS IN NEW ENGLAND, AS PUBLISHED BY THE NEW ENGLAND INTERSTATE WATER POLLUTION CONTROL COMMISSION AND/OR THE CURRENT VERSION OF

THE FIELD INDICATORS OF HYDRIC SOILS IN THE UNITED STATES, AS PUBLISHED

- BY THE USDA, NRCS, AS APPROPRIATE. THE CURRENT NATIONAL LIST OF PLANT SPECIES THAT OCCUR IN WETLANDS, AS PUBLISHED BY THE US FISH AND WILDLIFE SERVICE.
- 14. "OLD ROAD LEADING FROM COUGH BRIDGE TO THE ROCKS ROAD" DISCONTINUED BY TOWN VOTE MARCH 14, 1876. NO LAYOUT FOUND BY THIS OFFICE AT THIS TIME. BOUNDARY ALONG OLD ROAD HELD AS NEAR EDGE, PER RECORD PLANS 3, 6, AND
- 15. SEE BOUNDARY LINE FINE AGREEMENT BETWEEN MAGNUSSON FARM LLC, WARREN HARTFORD, AND LLOYD & BETTY METEVIER, R.C.R.D BOOK 4459, PAGE 2345, AND
- PLAN REFERENCES 7 & 8. 16. THE DECK, PORCH, AND PORTIONS OF THE DRIVEWAY AS SHOWN ARE LIMITED COMMON

AREA. SEE DECLARATION OF CONDOMINIUM.

- 17. THE HORIZONTAL BOUNDARIES OF THE BUILDING SHALL BE: "THE OUTSIDE FINISHED EXERIOR SURFACE OF THE WALLS, FOUNDATIONS, AND ROOFS AND THE LOWER SURFACE OF THE BASEMENT SLAB, INCLUDING ALL SUPPORTS, VENTS, CHIMNEYS, STAIRWAYS, PORCHES, AND DECKS APPURTENANT THERETO."
- 18. SHEET A1 & C2 SHALL BE RECORDED AT ROCKINGHAM COUNTY REGISTRY OF DEEDS. FULL PLAN SET ON FILE IN THE TOWN OF FREMONT, NH PLANNING BOARD OFFICE.
- 19. SURVEY TIE LINES SHOWN HEREON ARE NOT BOUNDARY LINES. THEY SHOULD ONLY BE USED TO LOCATE THE PARCEL SURVEYED FROM THE FOUND MONUMENTS SHOWN AND LOCATED BY THIS SURVEY.

PROJECT PARCEL TOWN OF FREMONT TAX MAP 2, LOT 70

OWNER TIMOTHY AND GERALDINE PALMER 706 MAIN STREET FREMONT, NH 03044

APPLICANT HAUS EMILY, LLC

56 WESTVILLE ROAD, UNIT 4 PLAISTOW, NH 03865

BK 5673, PG 0101

TOTAL LOT AREA 1,322,917 SQ. FT.

30.37 ACRES

Checked: BWG | Scale: AS NOTED | Project No.: 20724 Drawing Name: 20724-PLAN.dwg THIS PLAN SHALL NOT BE MODIFIED WITHOUT WRITTEN

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REVISED PER PB COMMENTS BWG 2 12/6/21 **REVISED PER TECHNICAL REVIEW** 1 11/22/21 **BWG** 0 10/6/21 **ISSUED FOR REVIEW BWG** REVISION BY REV. DATE

85 Portsmouth Ave. Civil Engineering Services PO Box 219

Stratham, NH 03885

Jones & Beach Engineers, Inc. 603-772-4746 FAX: 603-772-0227

E-MAIL: JBE@JONESANDBEACH.COM

Project:

Owner of Record:


CONDOMINIUM SITE PLAN


LIBERTY LANTERN ESTATES MAIN STREET, FREMONT, NH **TIMOTHY & GERALDINE PALMER**


706 MAIN STREET, FREMONT, NH 03044

DRAWING No.

SHEET 4 OF 21 JBE PROJECT NO. 20724

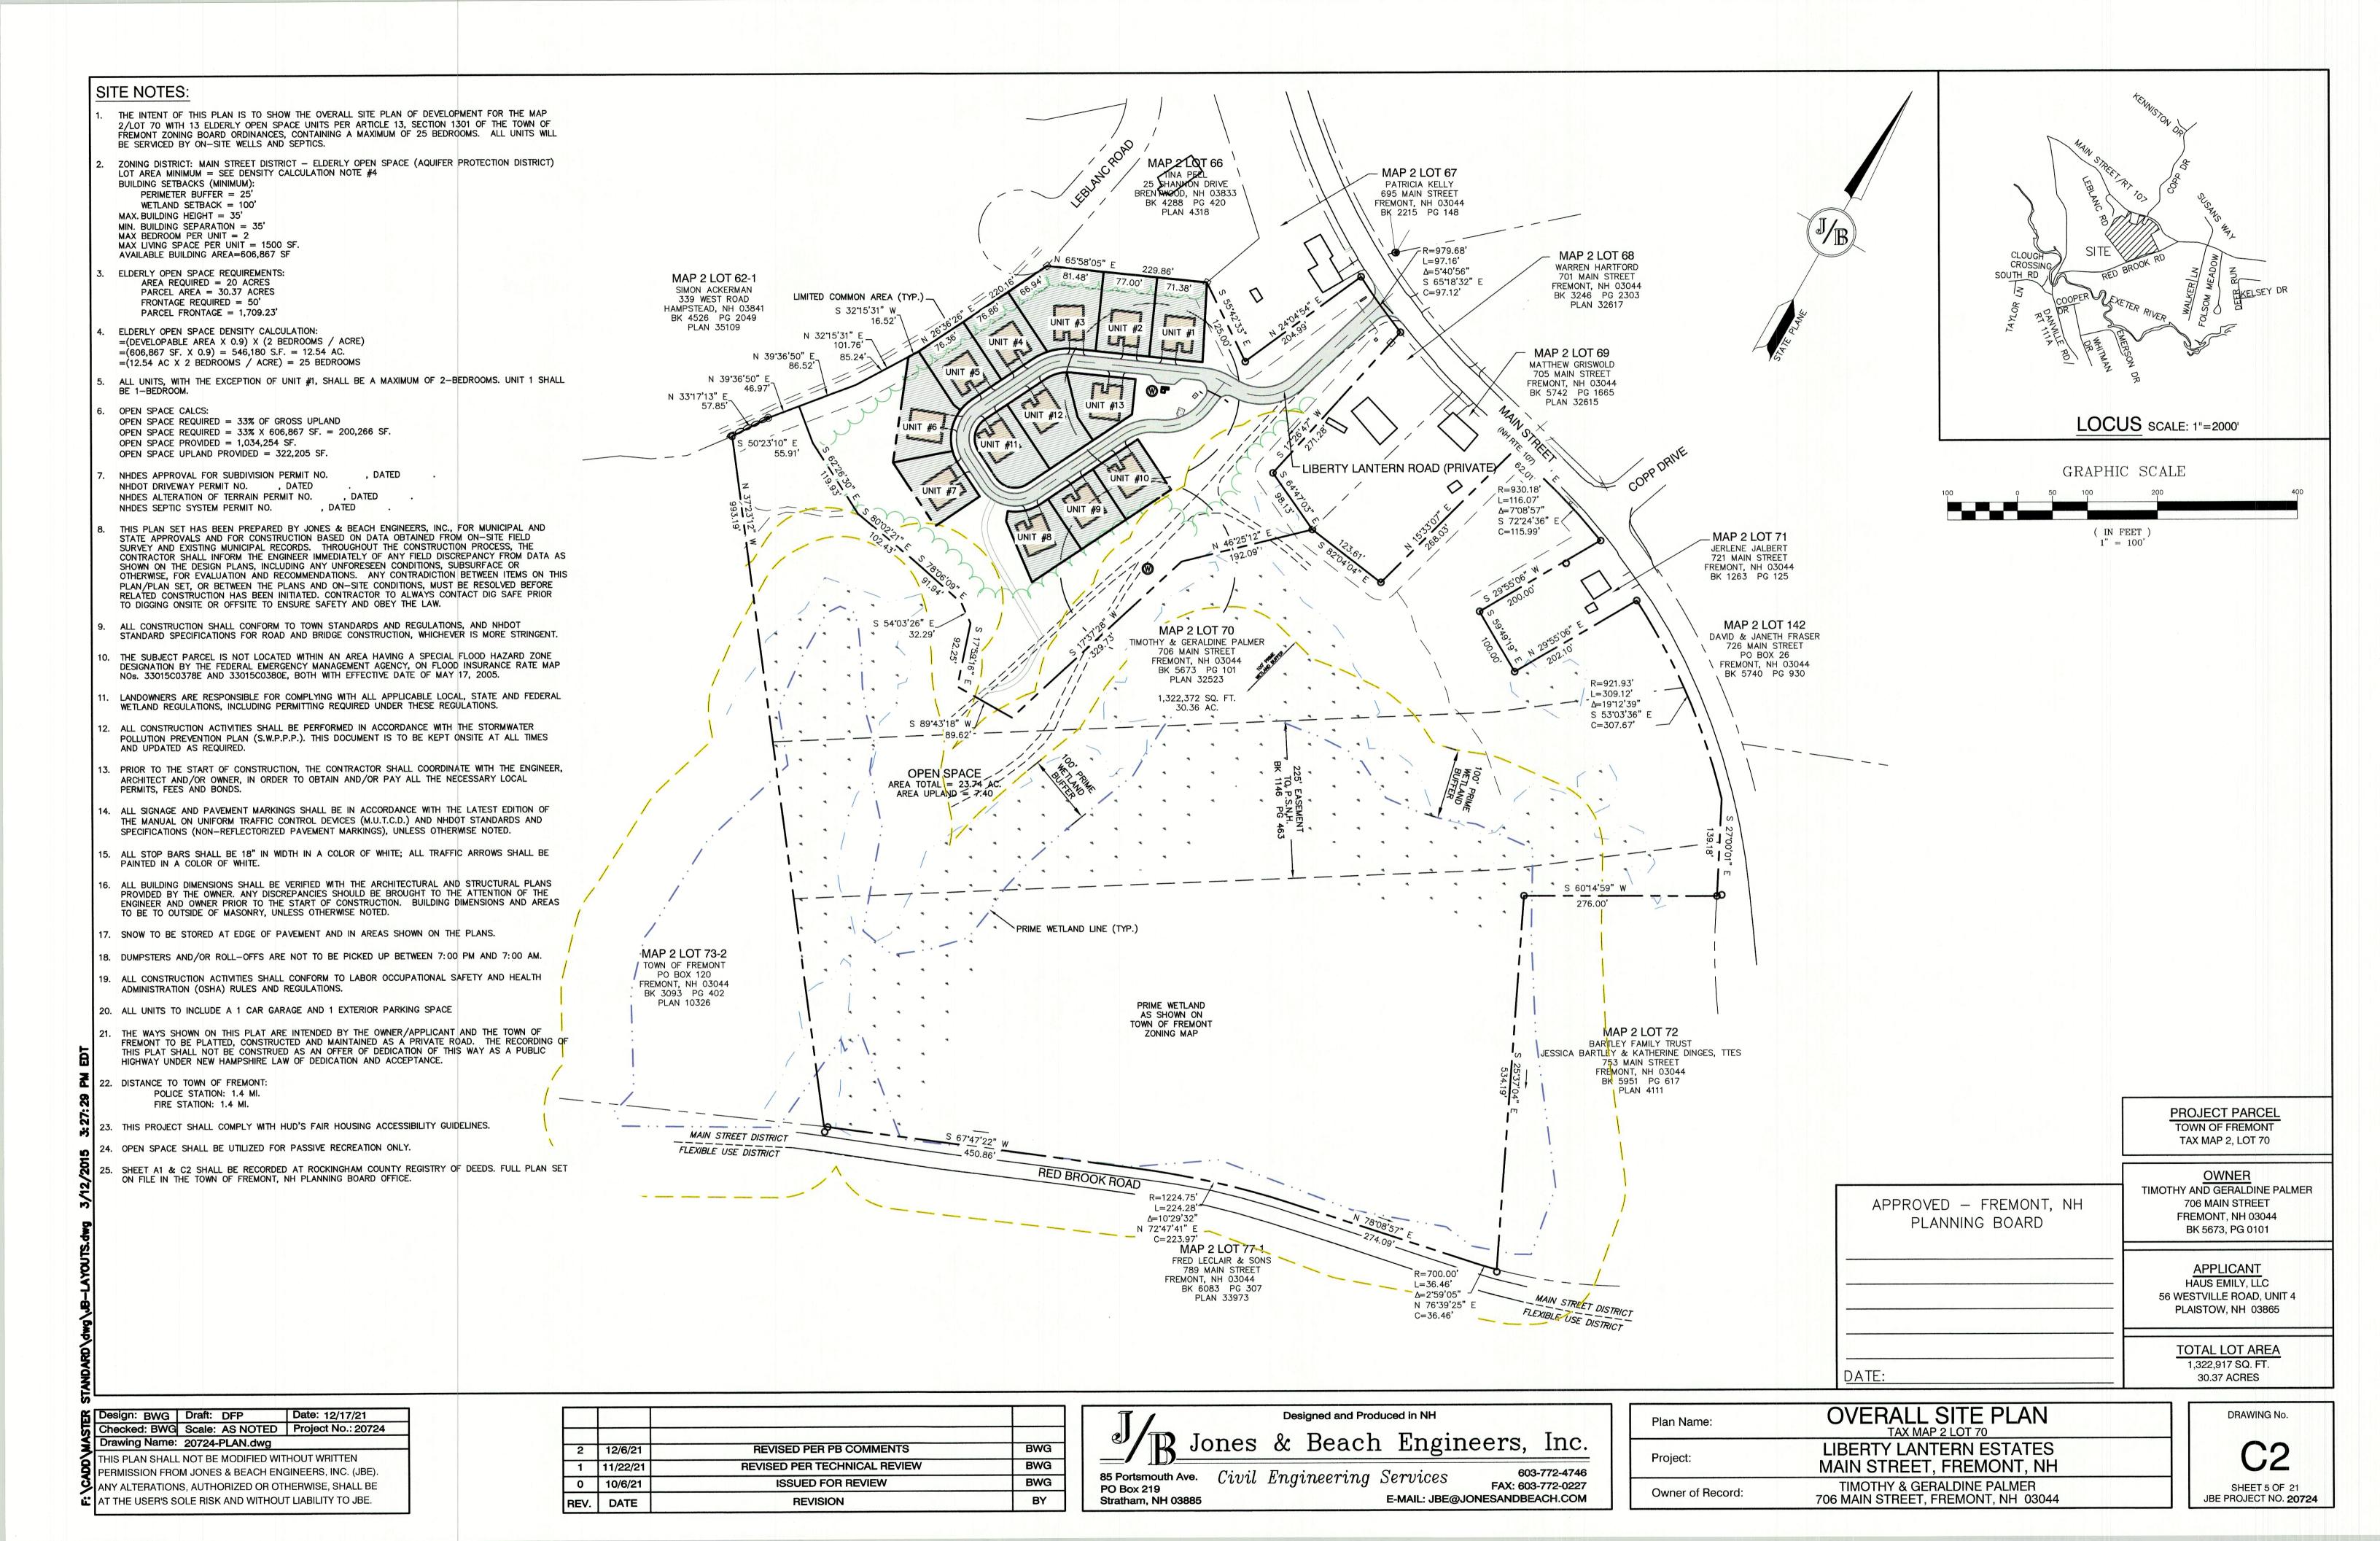

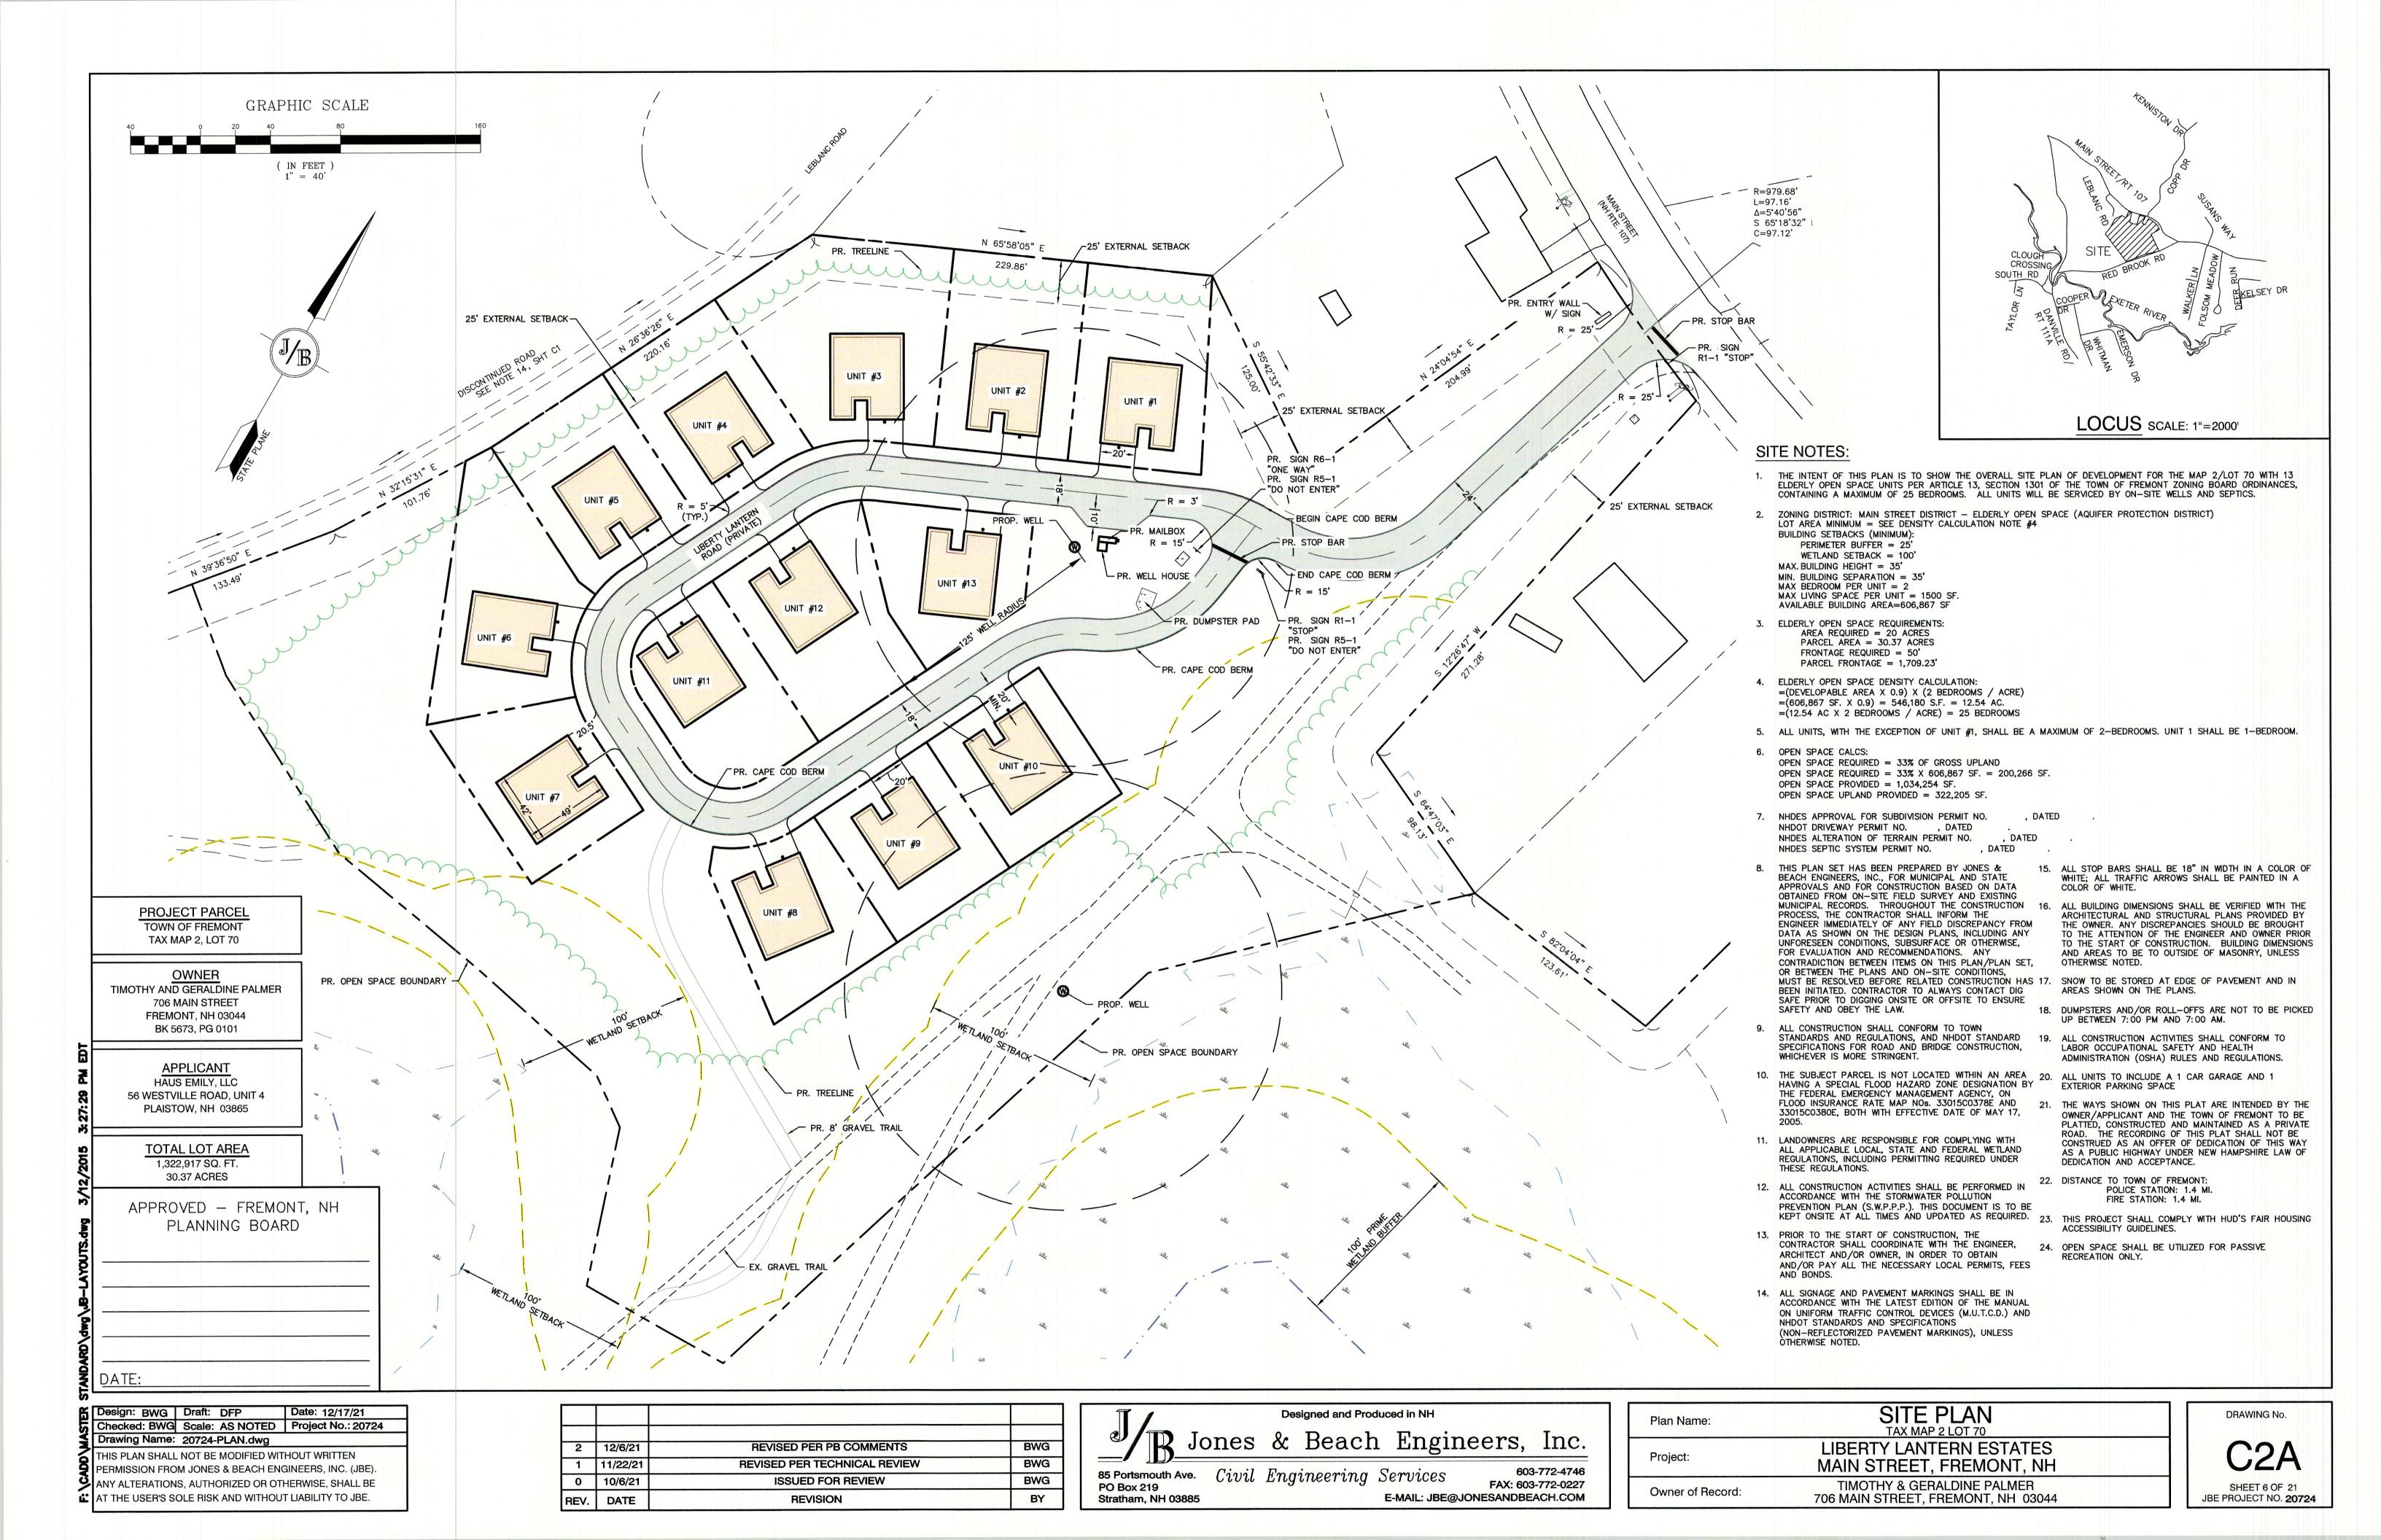

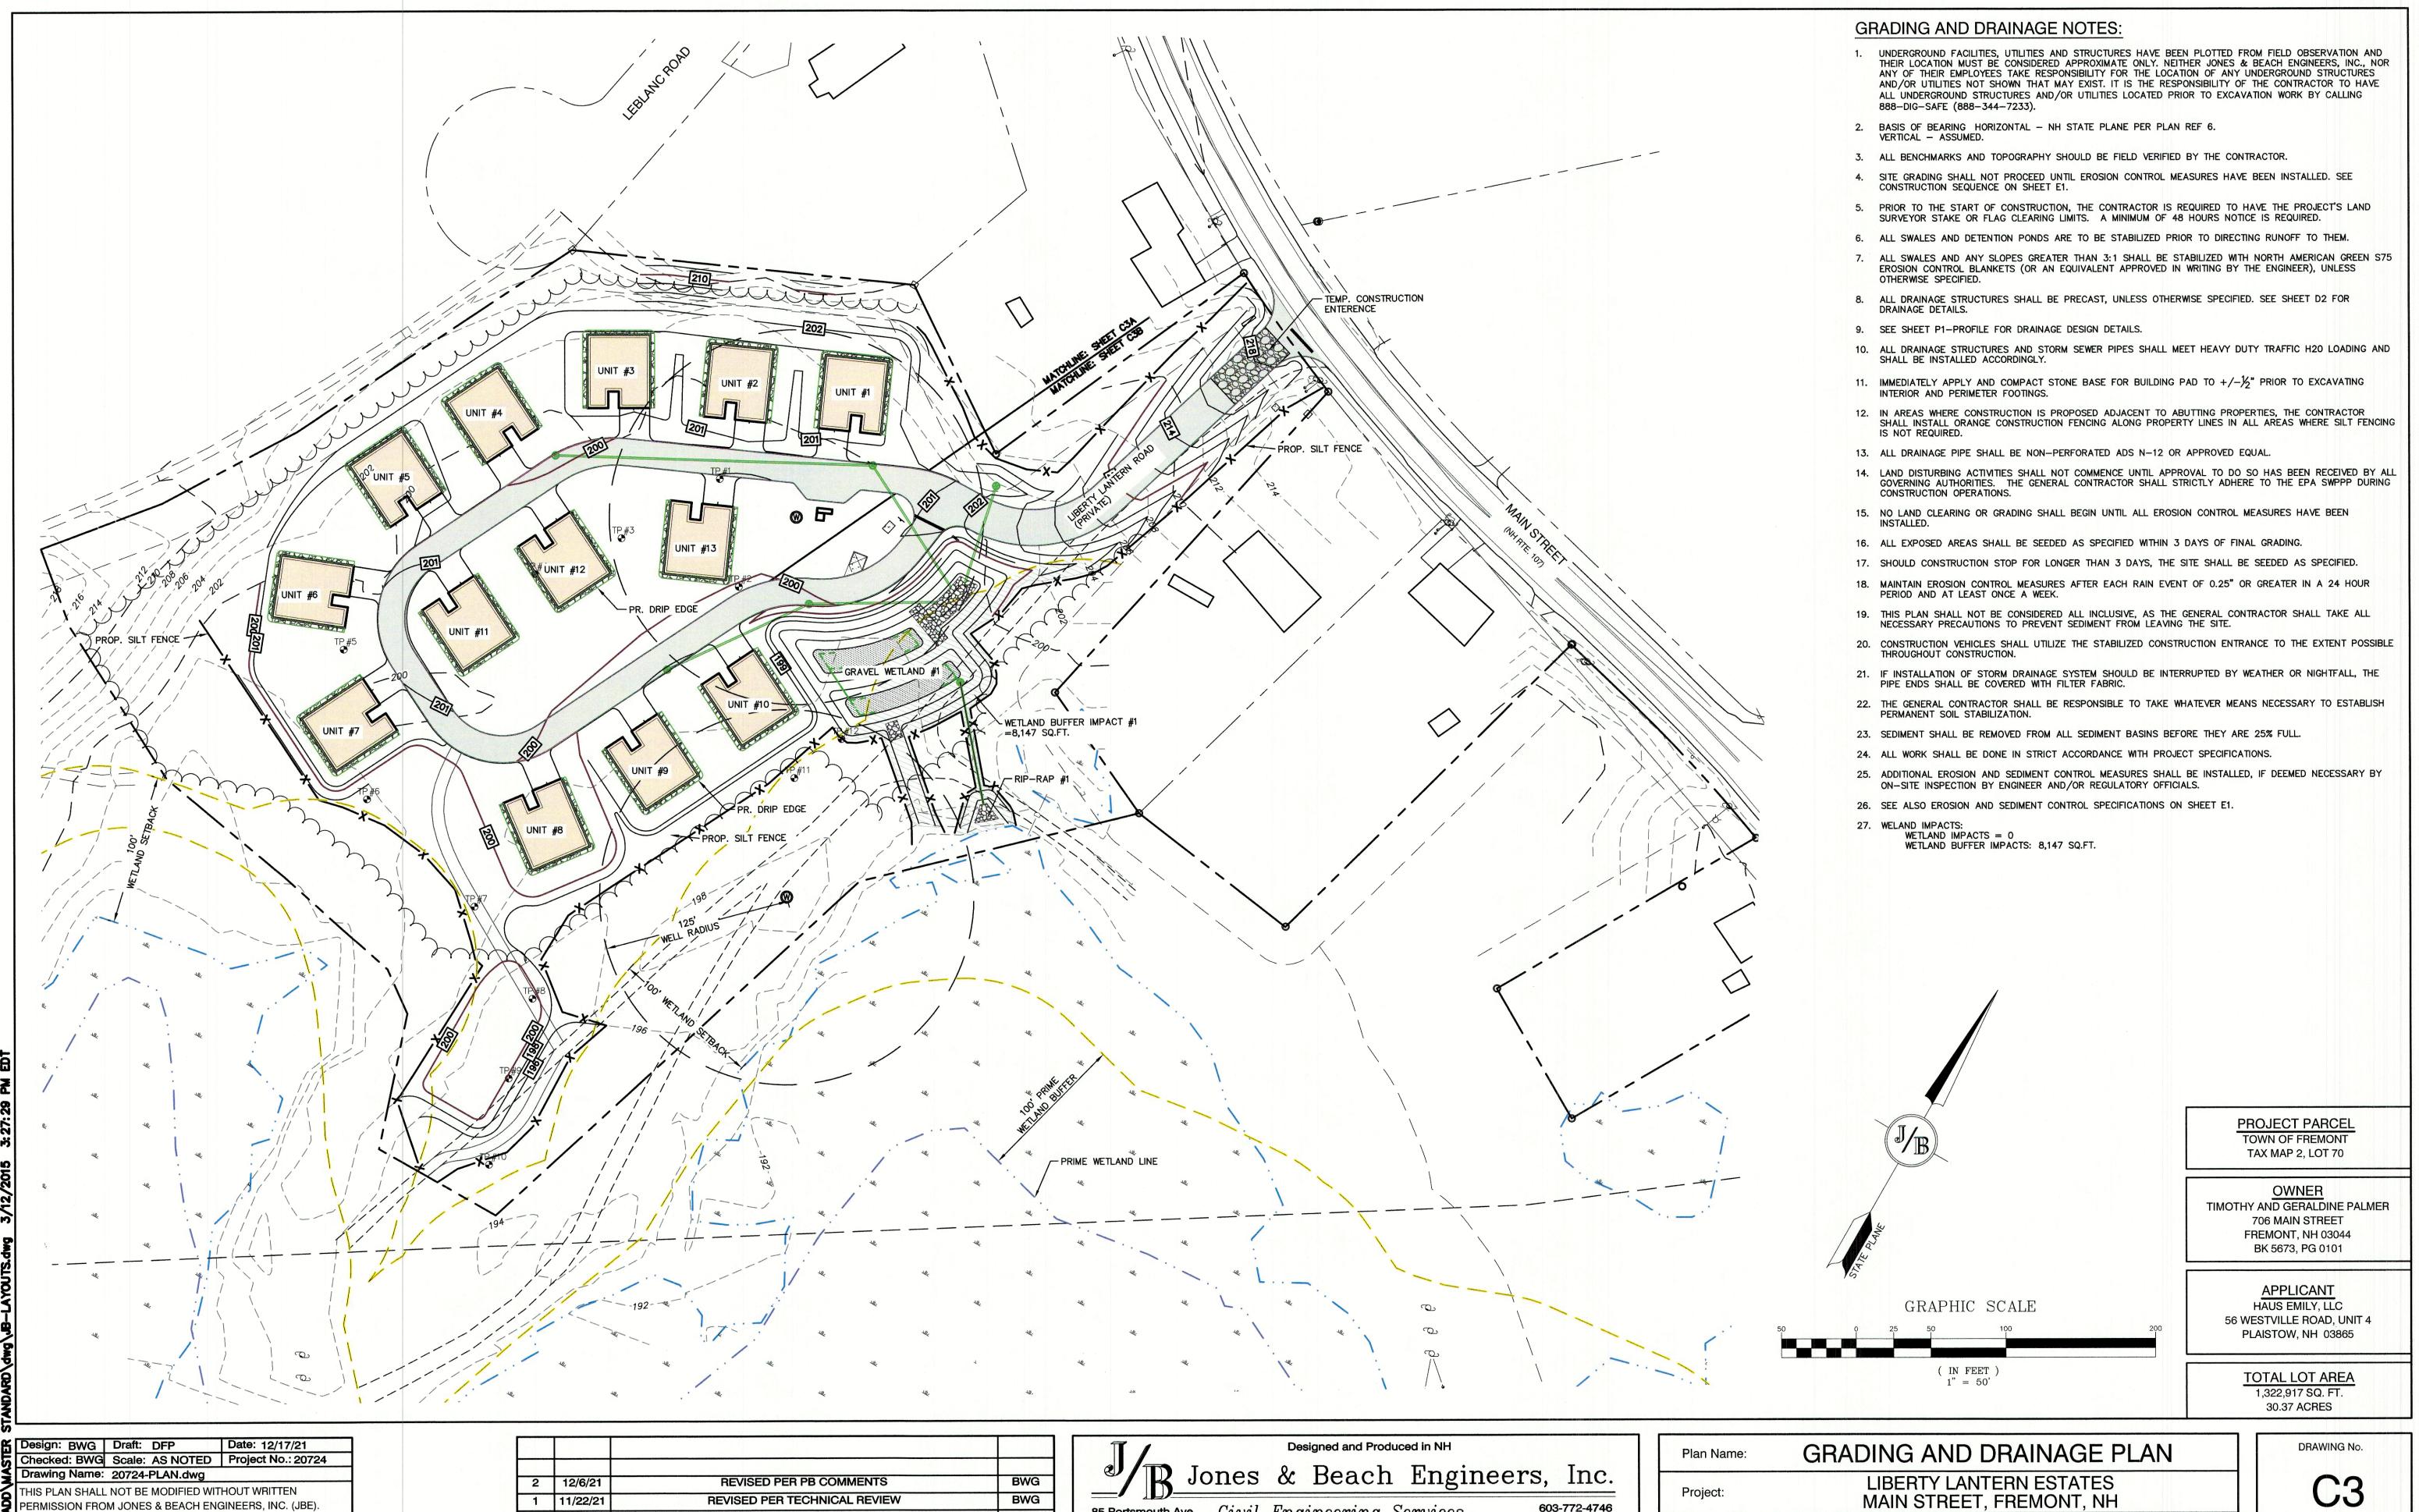

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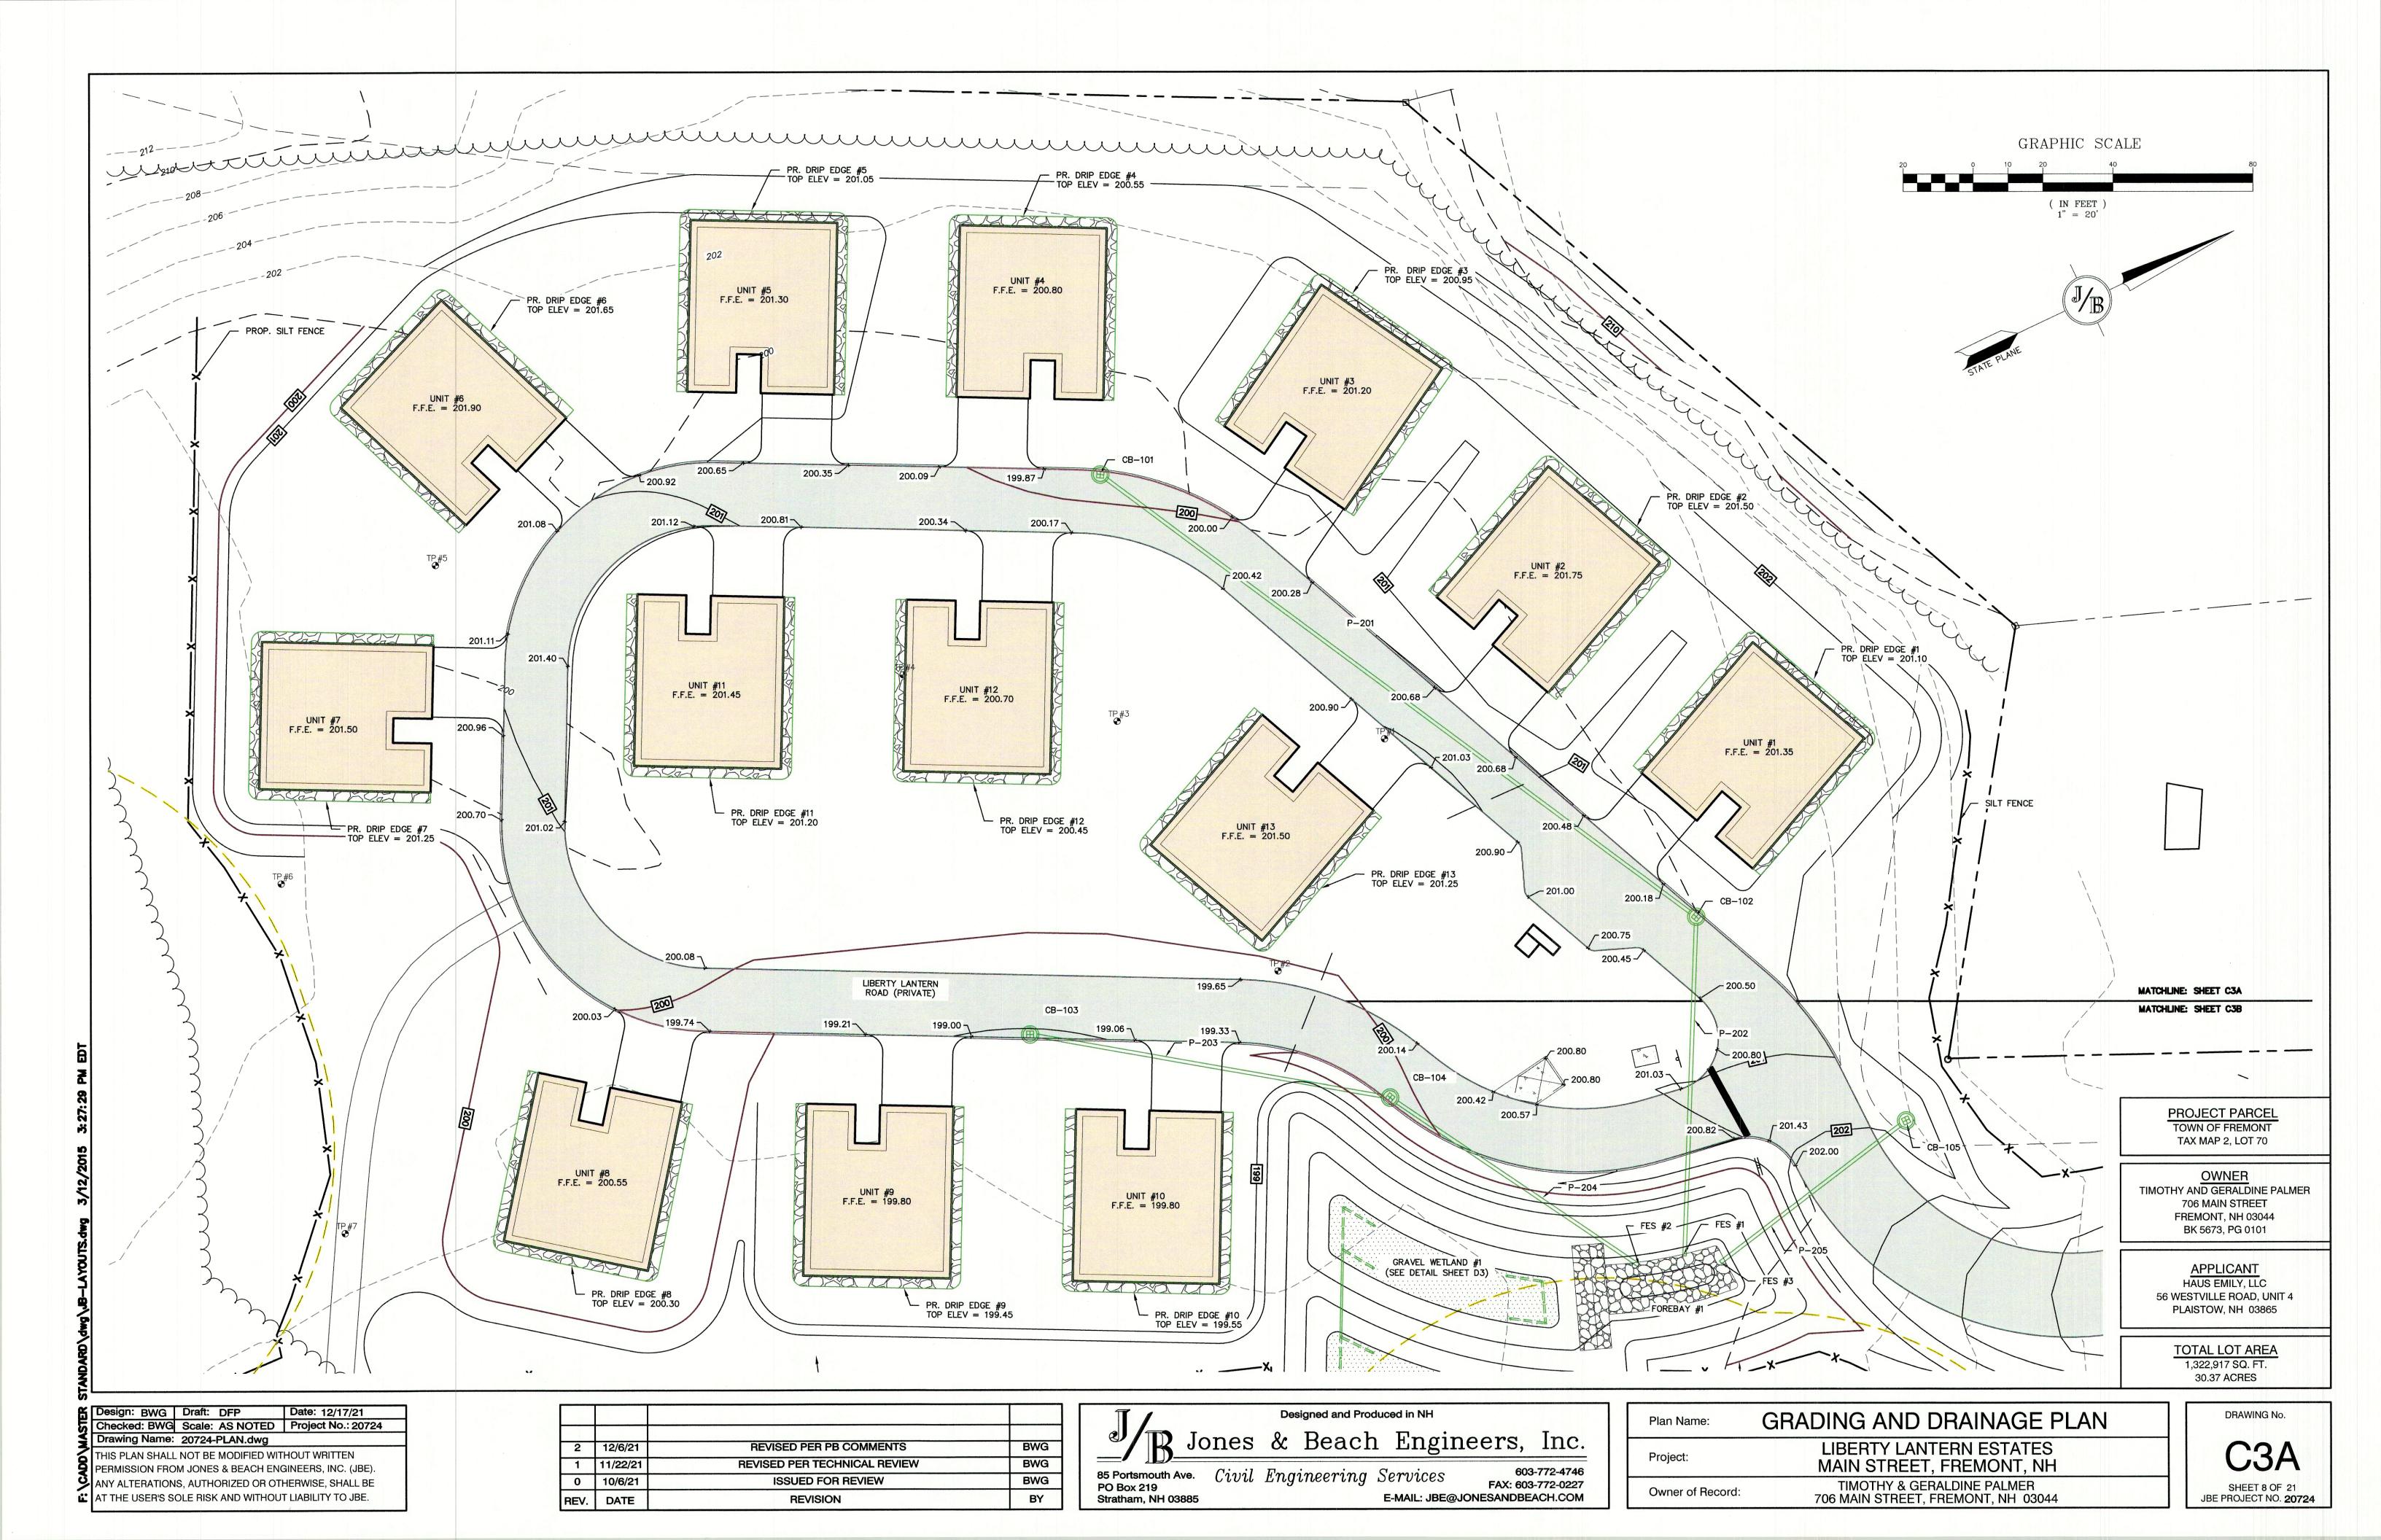
85 Portsmouth Ave. Civil Engineering Services PO Box 219 E-MAIL: JBE@JONESANDBEACH.COM Stratham, NH 03885


FAX: 603-772-0227


Owner of Record:

LIBERTY LANTERN ESTATES MAIN STREET, FREMONT, NH TIMOTHY & GERALDINE PALMER 706 MAIN STREET, FREMONT, NH 03044

SHEET 7 OF 21 JBE PROJECT NO. **20724**



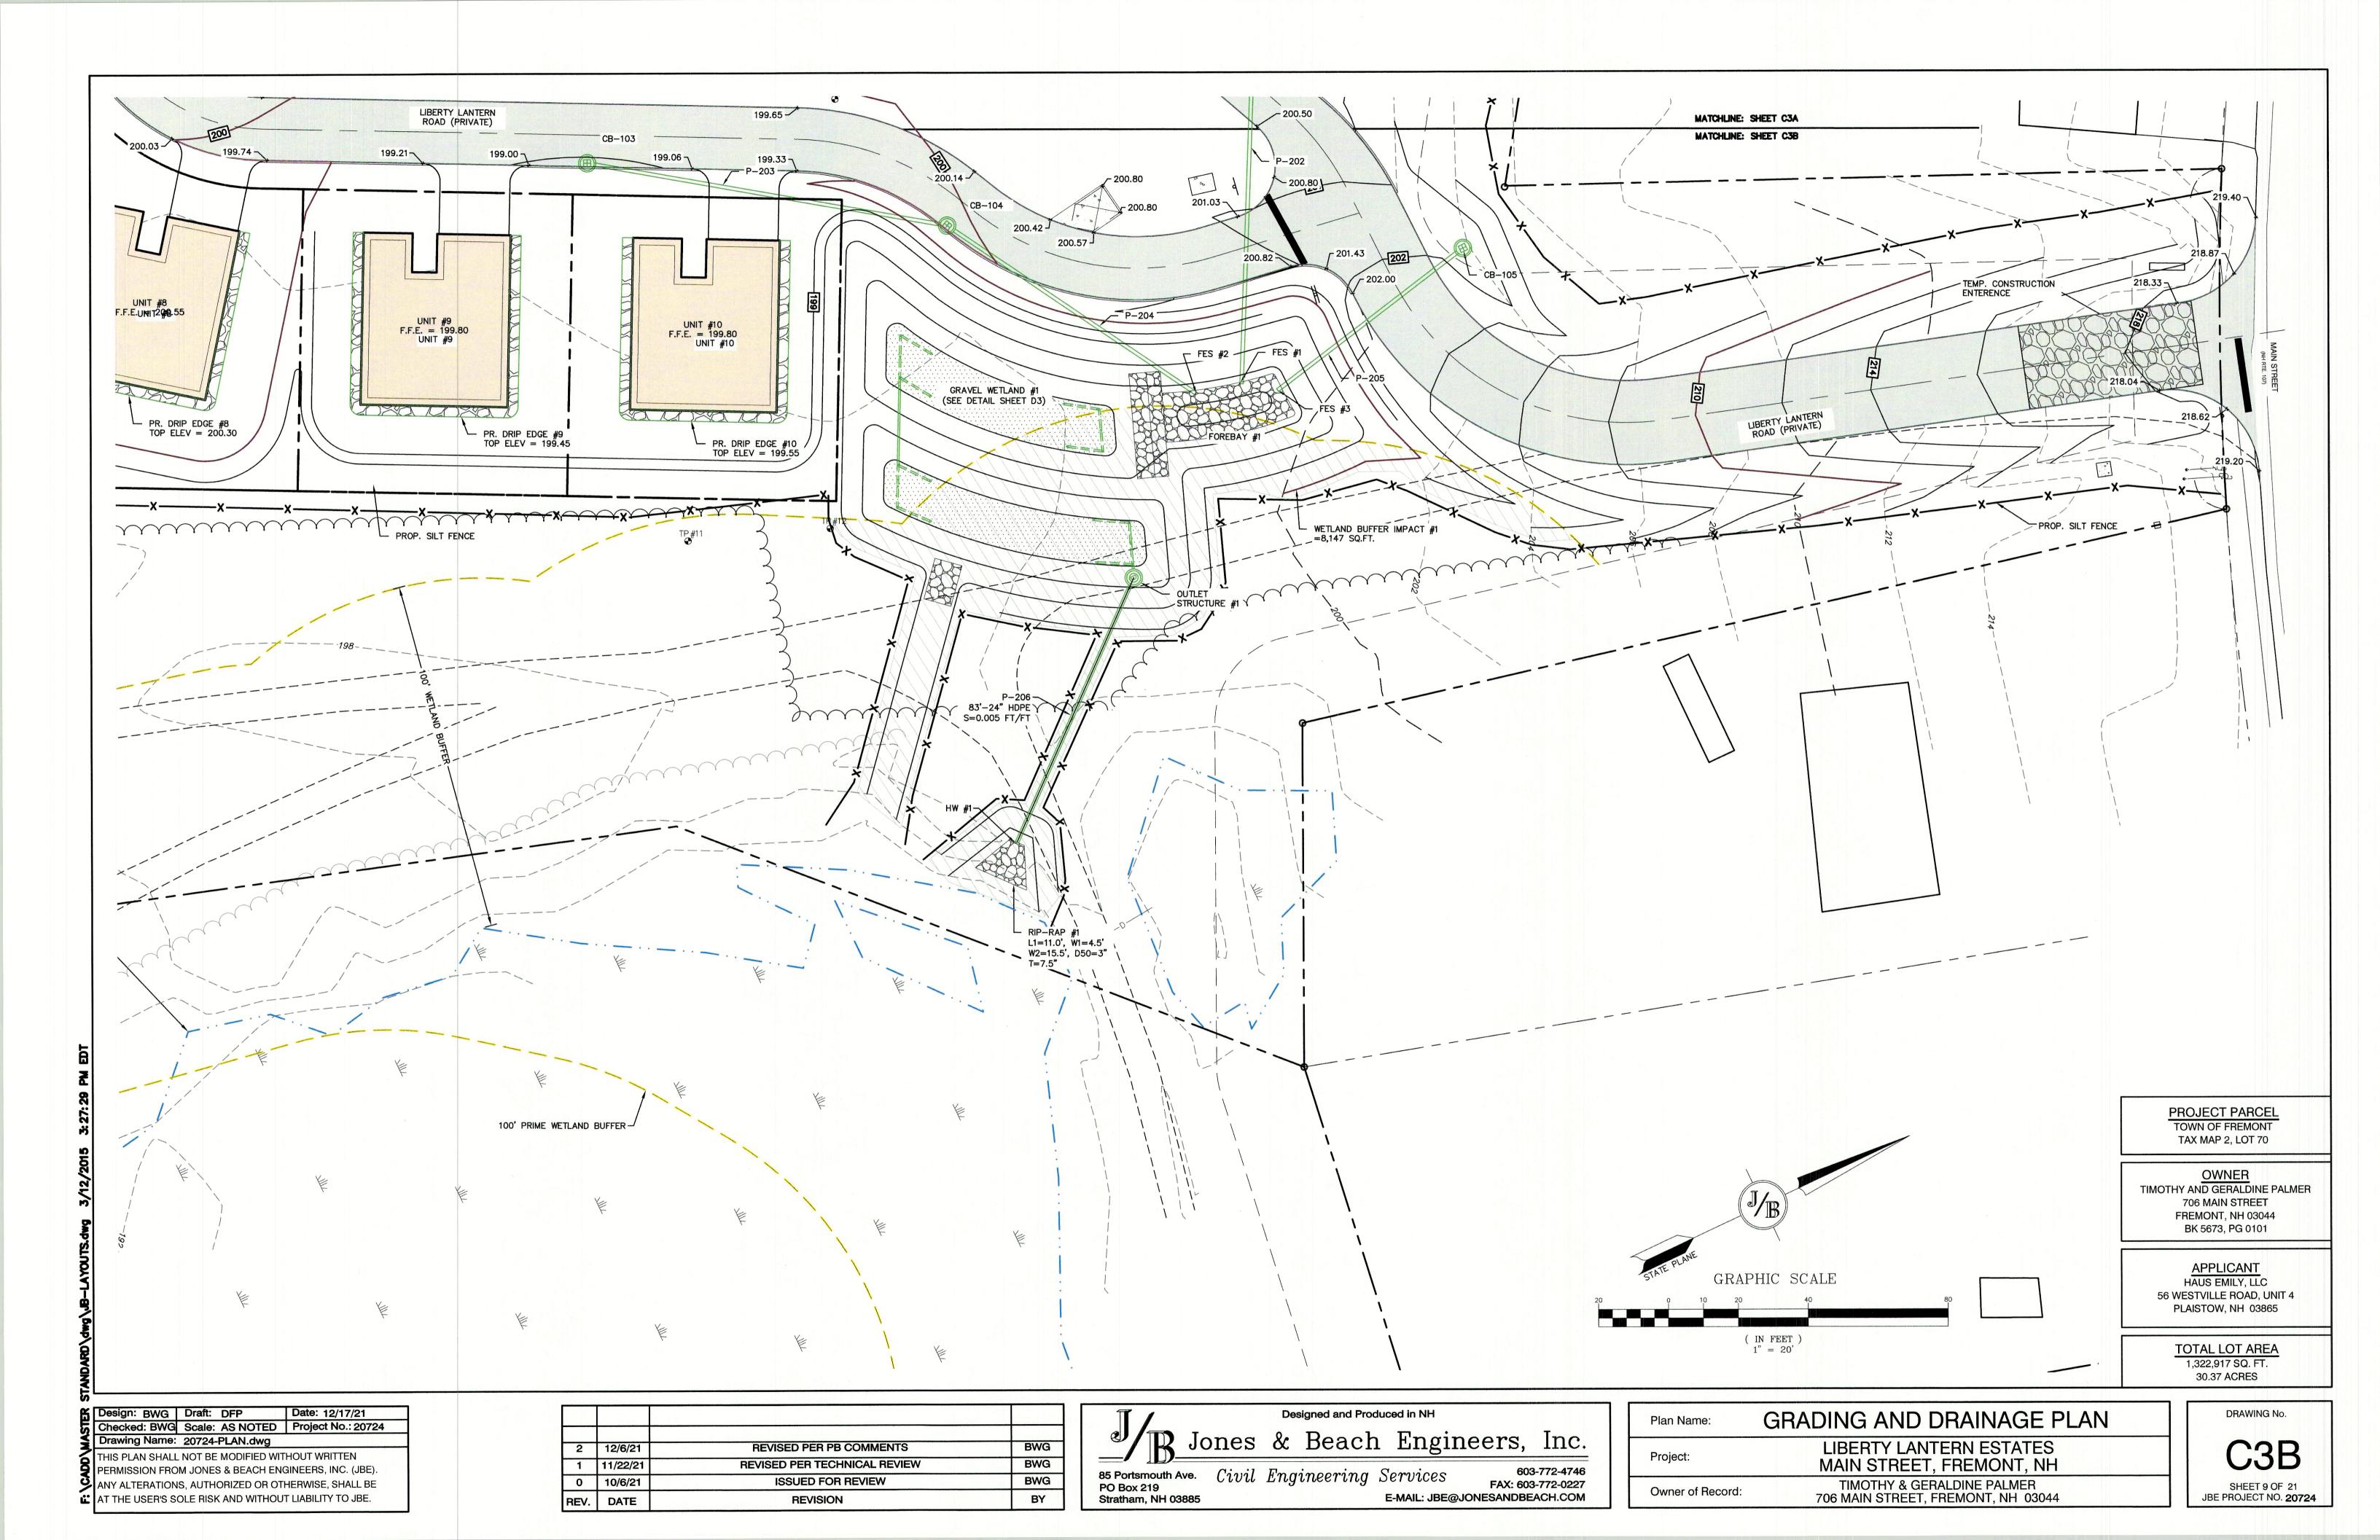

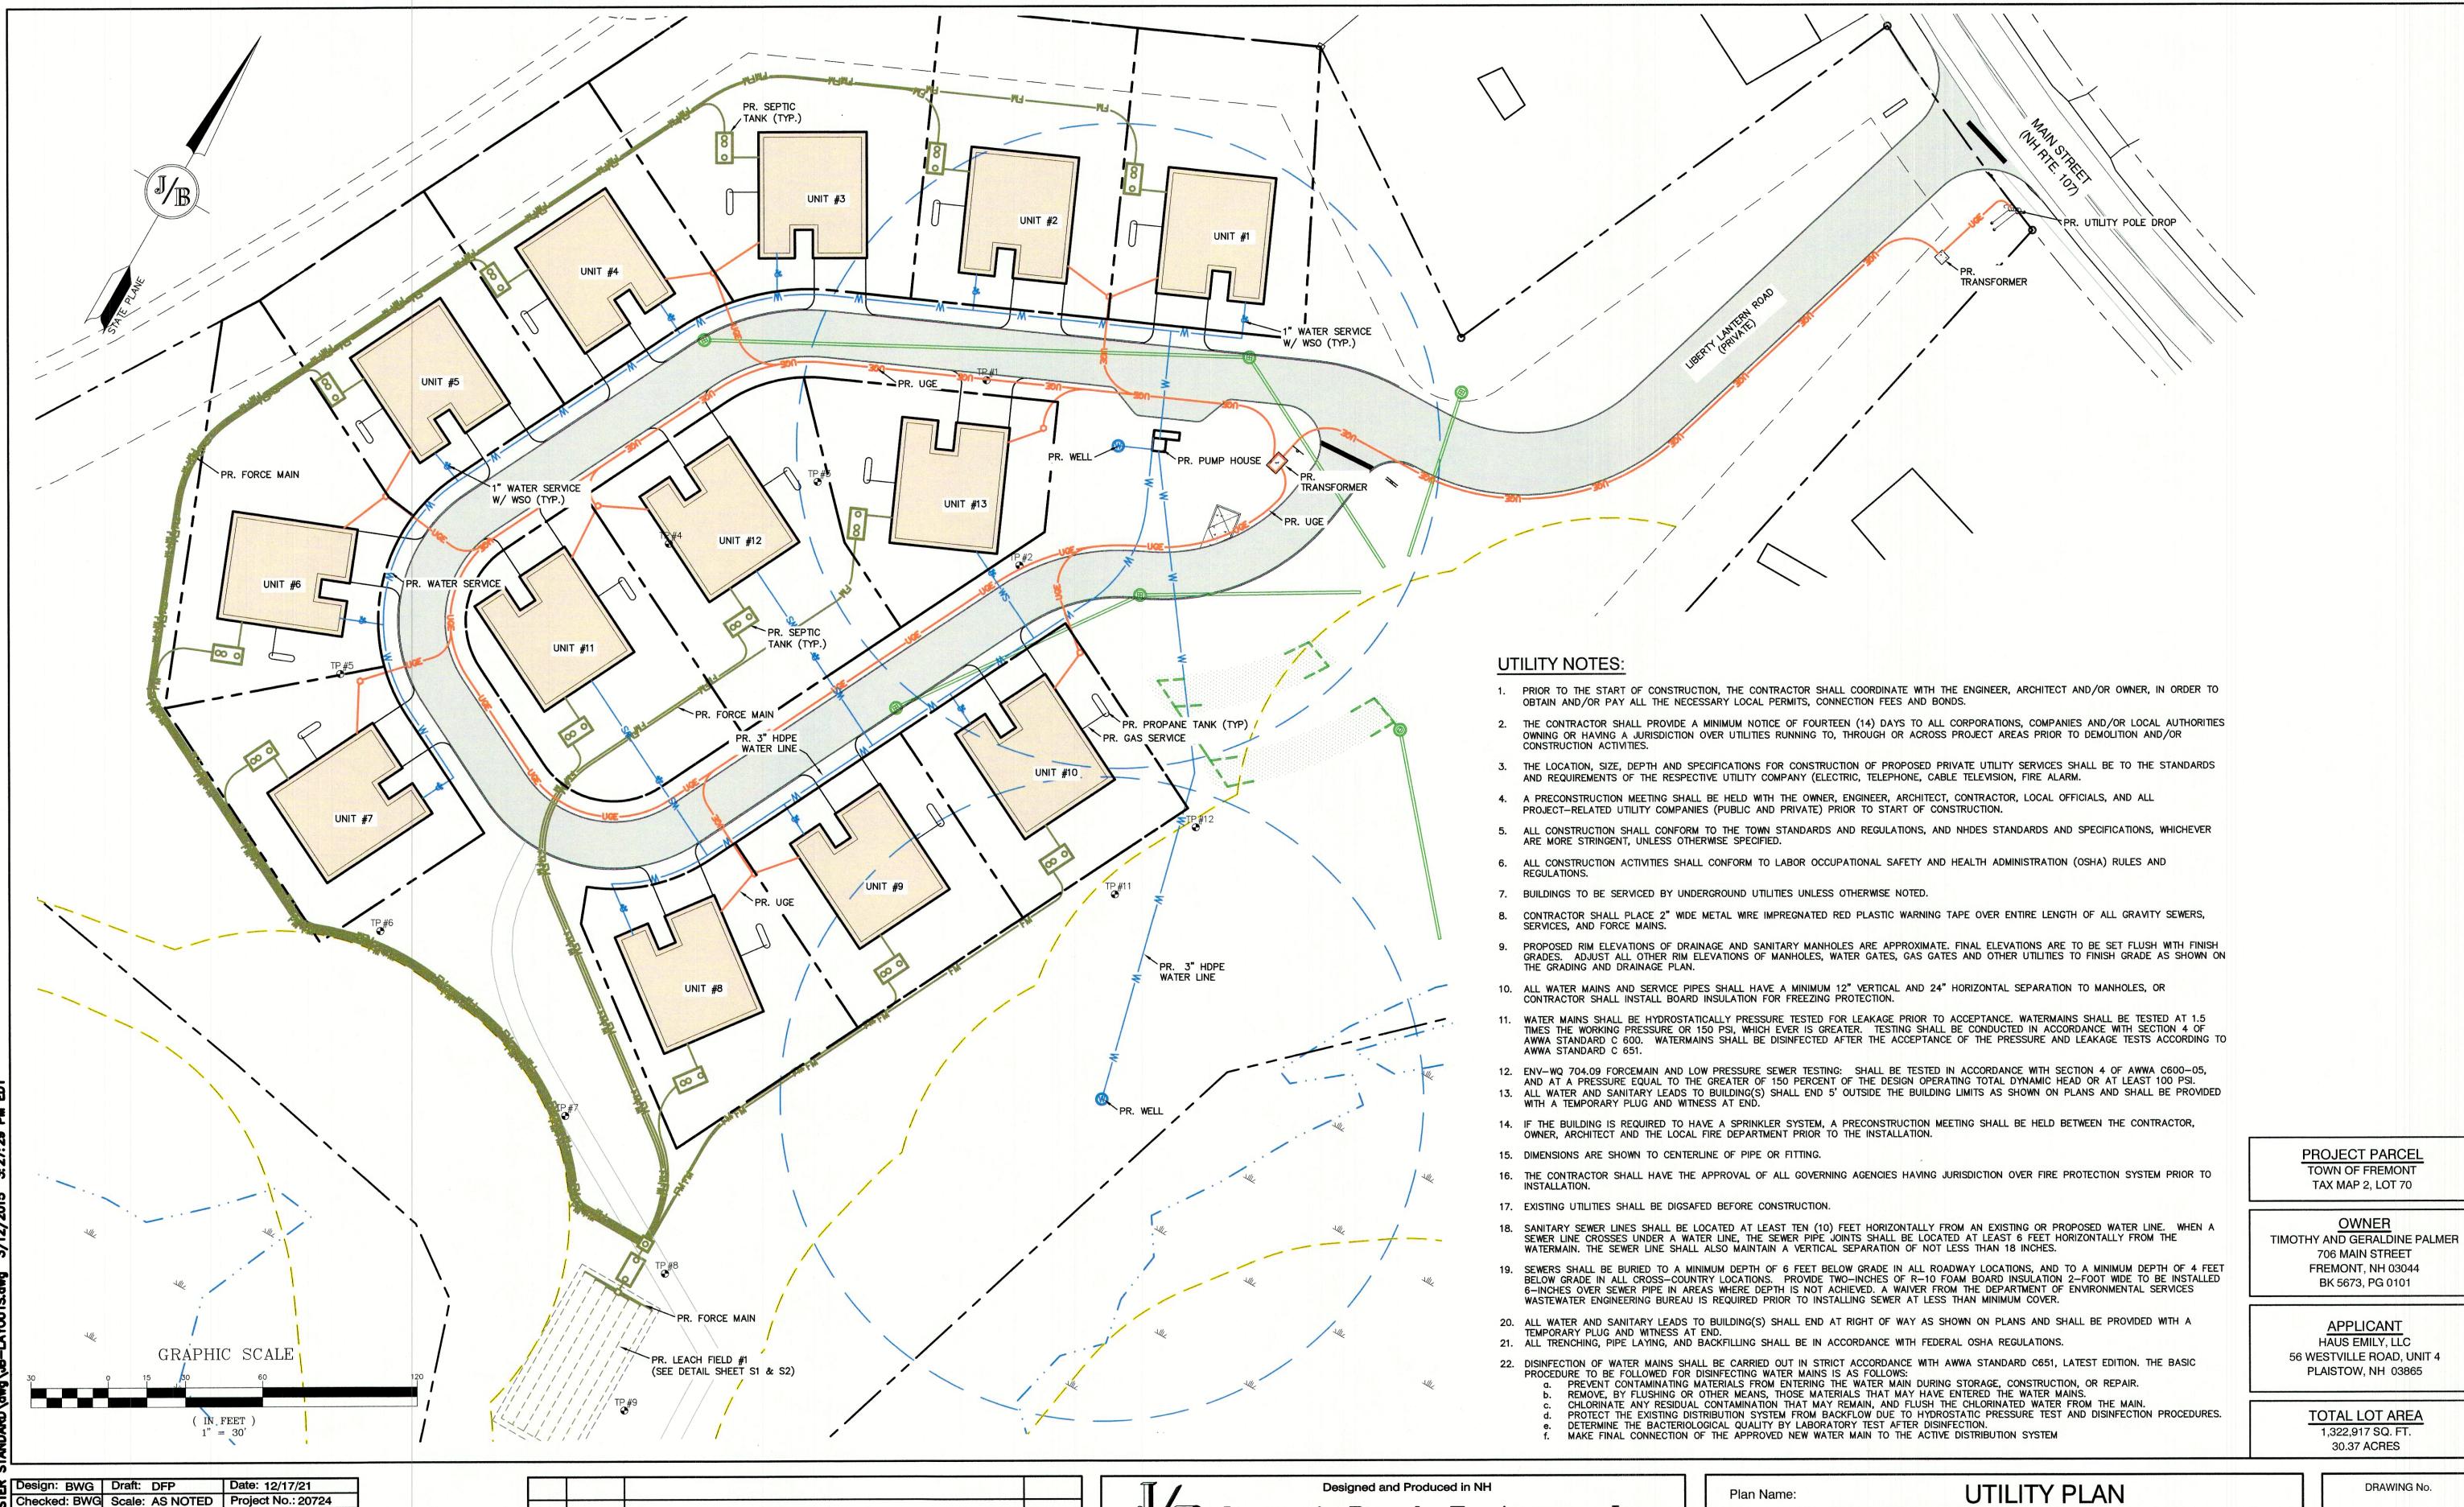

Drawing Name: 20724-PLAN.dwg

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Jones & Beach Engineers, Inc.


85 Portsmouth Ave. Civil Engineering Services PO Box 219 Stratham, NH 03885

603-772-4746 FAX: 603-772-0227 E-MAIL: JBE@JONESANDBEACH.COM

LIBERTY LANTERN ESTATES Project: MAIN STREET, FREMONT, NH TIMOTHY & GERALDINE PALMER Owner of Record: 706 MAIN STREET, FREMONT, NH 03044

SHEET 10 OF 21

JBE PROJECT NO. 20724

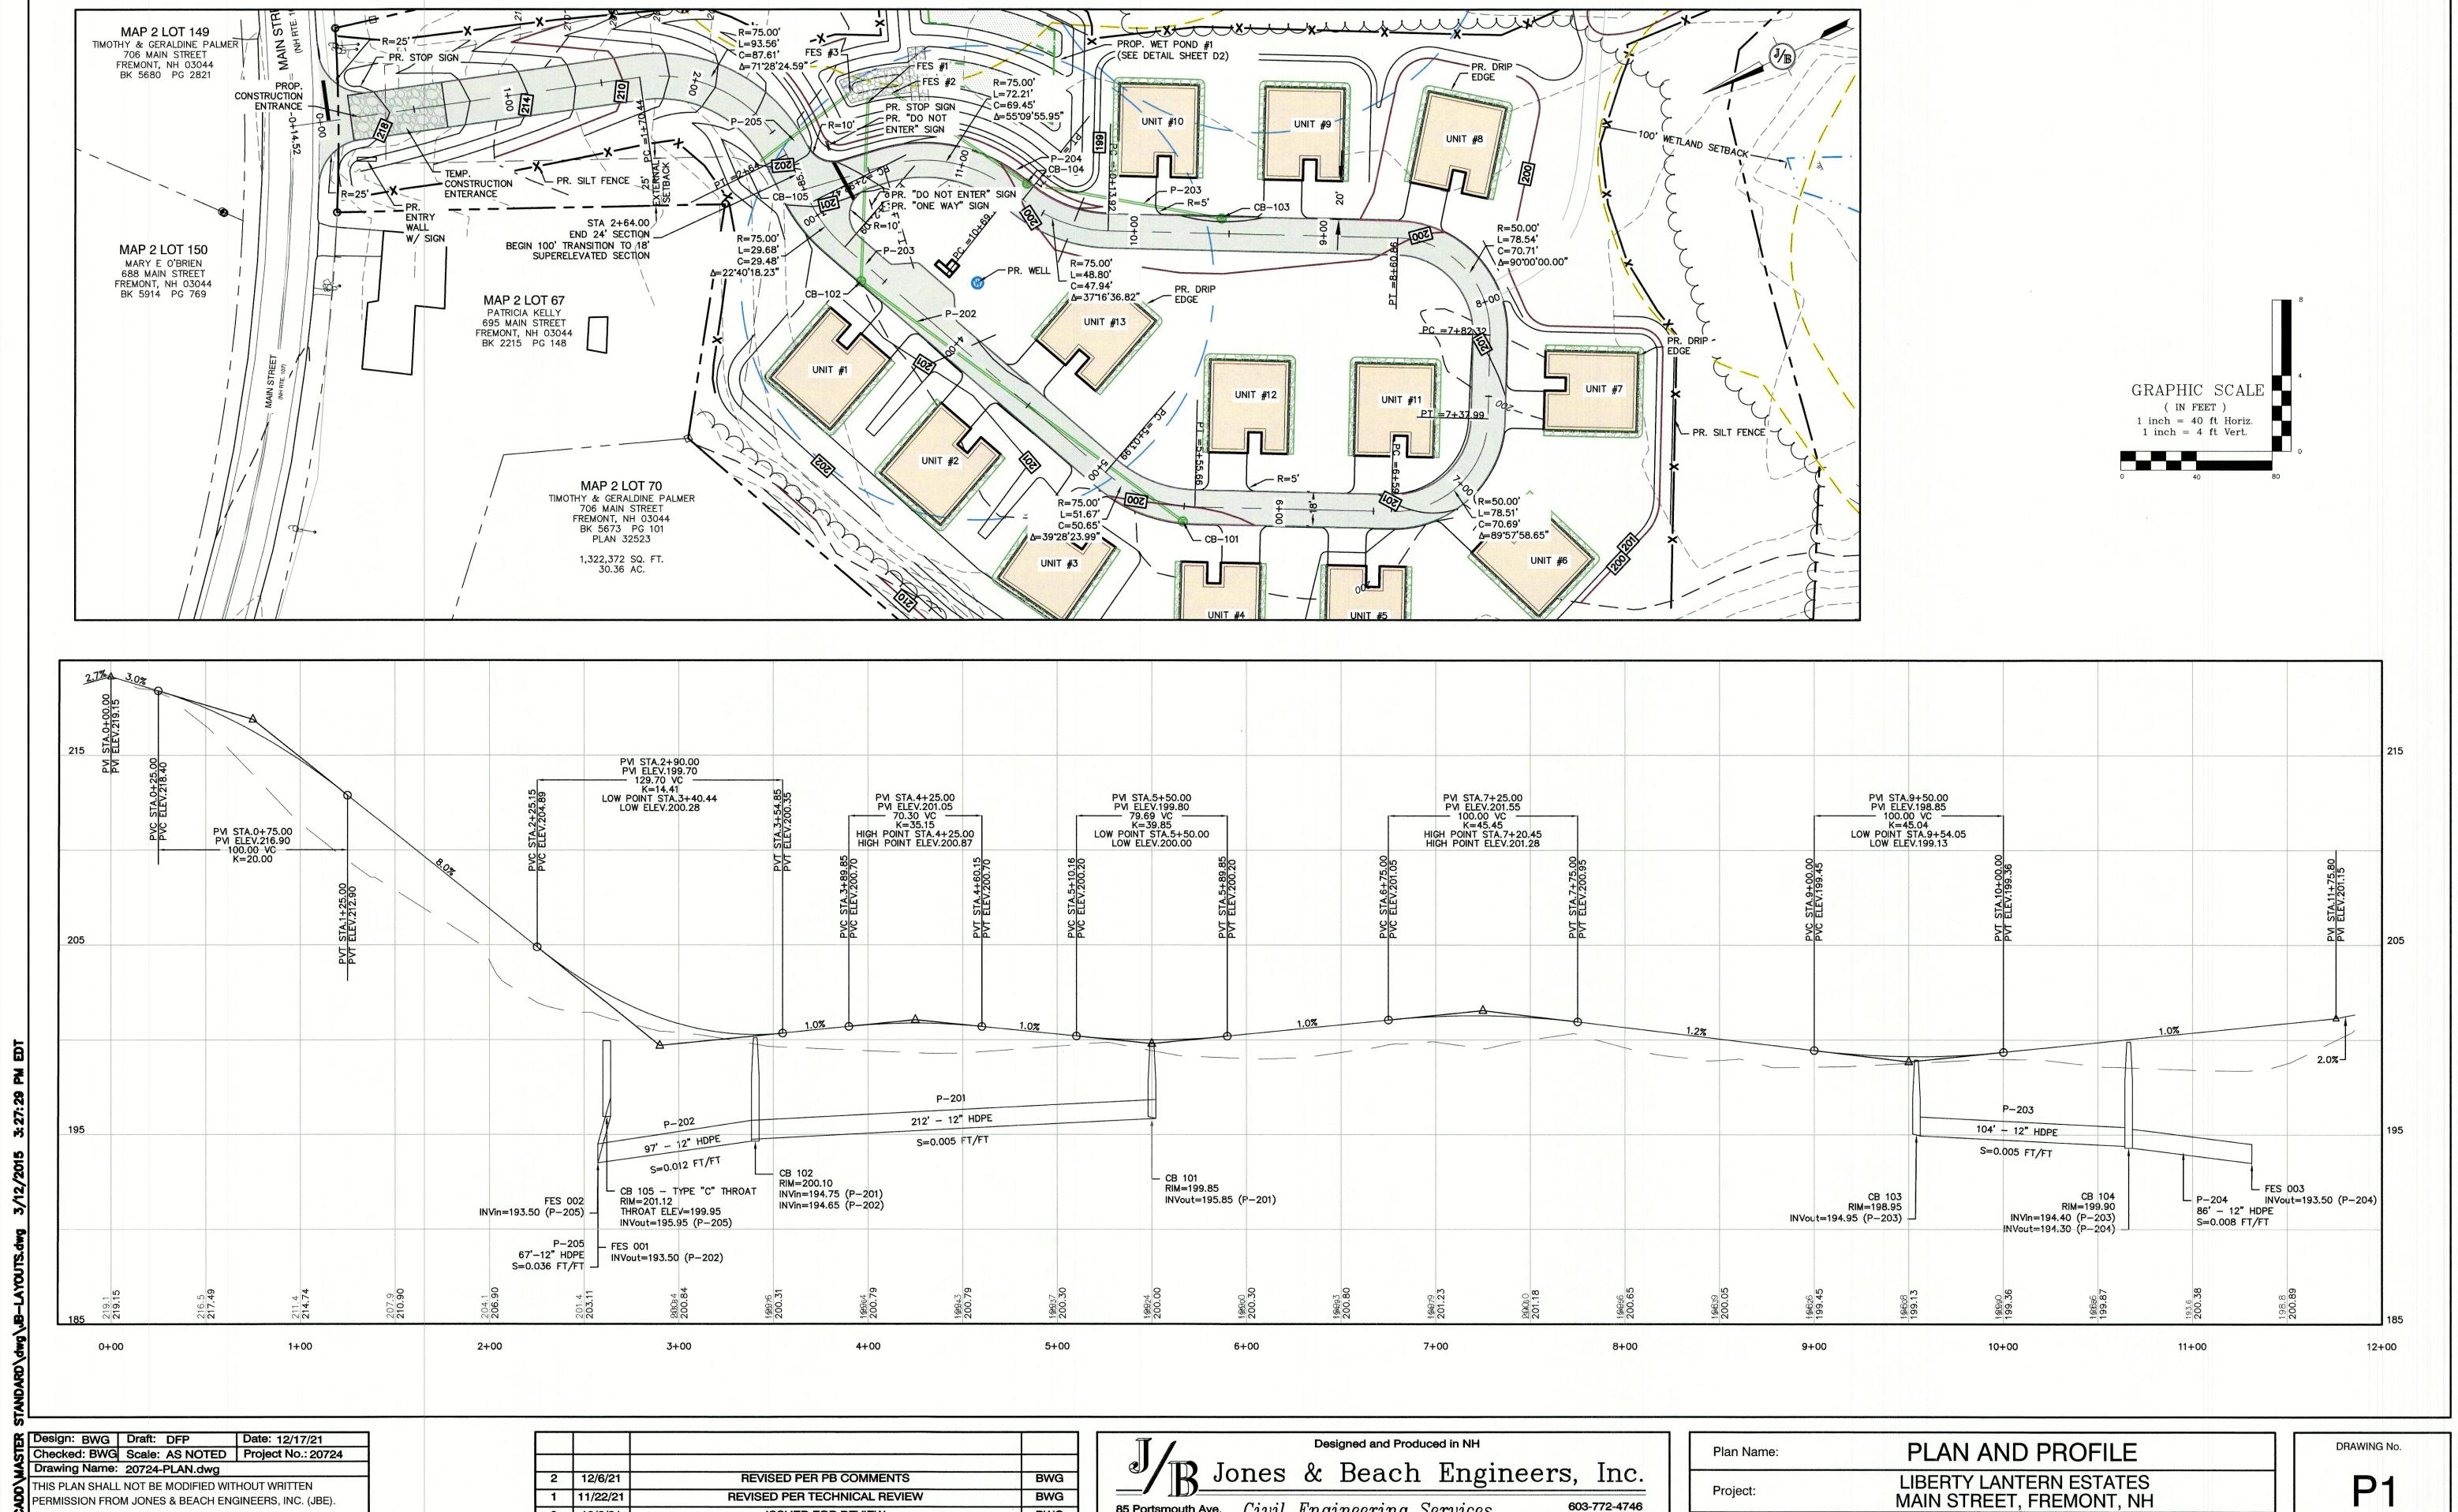

85 Portsmouth Ave. Civil Engineering Services

BWG

BWG

BY

PO Box 219

Stratham, NH 03885

REVISED PER TECHNICAL REVIEW

ISSUED FOR REVIEW

REVISION

Project:

Owner of Record:

TIMOTHY & GERALDINE PALMER 706 MAIN STREET, FREMONT, NH 03044

603-772-4746

FAX: 603-772-0227

E-MAIL: JBE@JONESANDBEACH.COM

2 12/6/21

1 11/22/21

0 10/6/21

REV. DATE


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 $oldsymbol{\mathcal{L}}$ AT THE USER'S SOLE RISK AND WITHOUT LIABILITY TO JBE.

PERMISSION FROM JONES & BEACH ENGINEERS, INC. (JBE).

ANY ALTERATIONS, AUTHORIZED OR OTHERWISE, SHALL BE

D SHEET 11 OF 21 JBE PROJECT NO. 20724

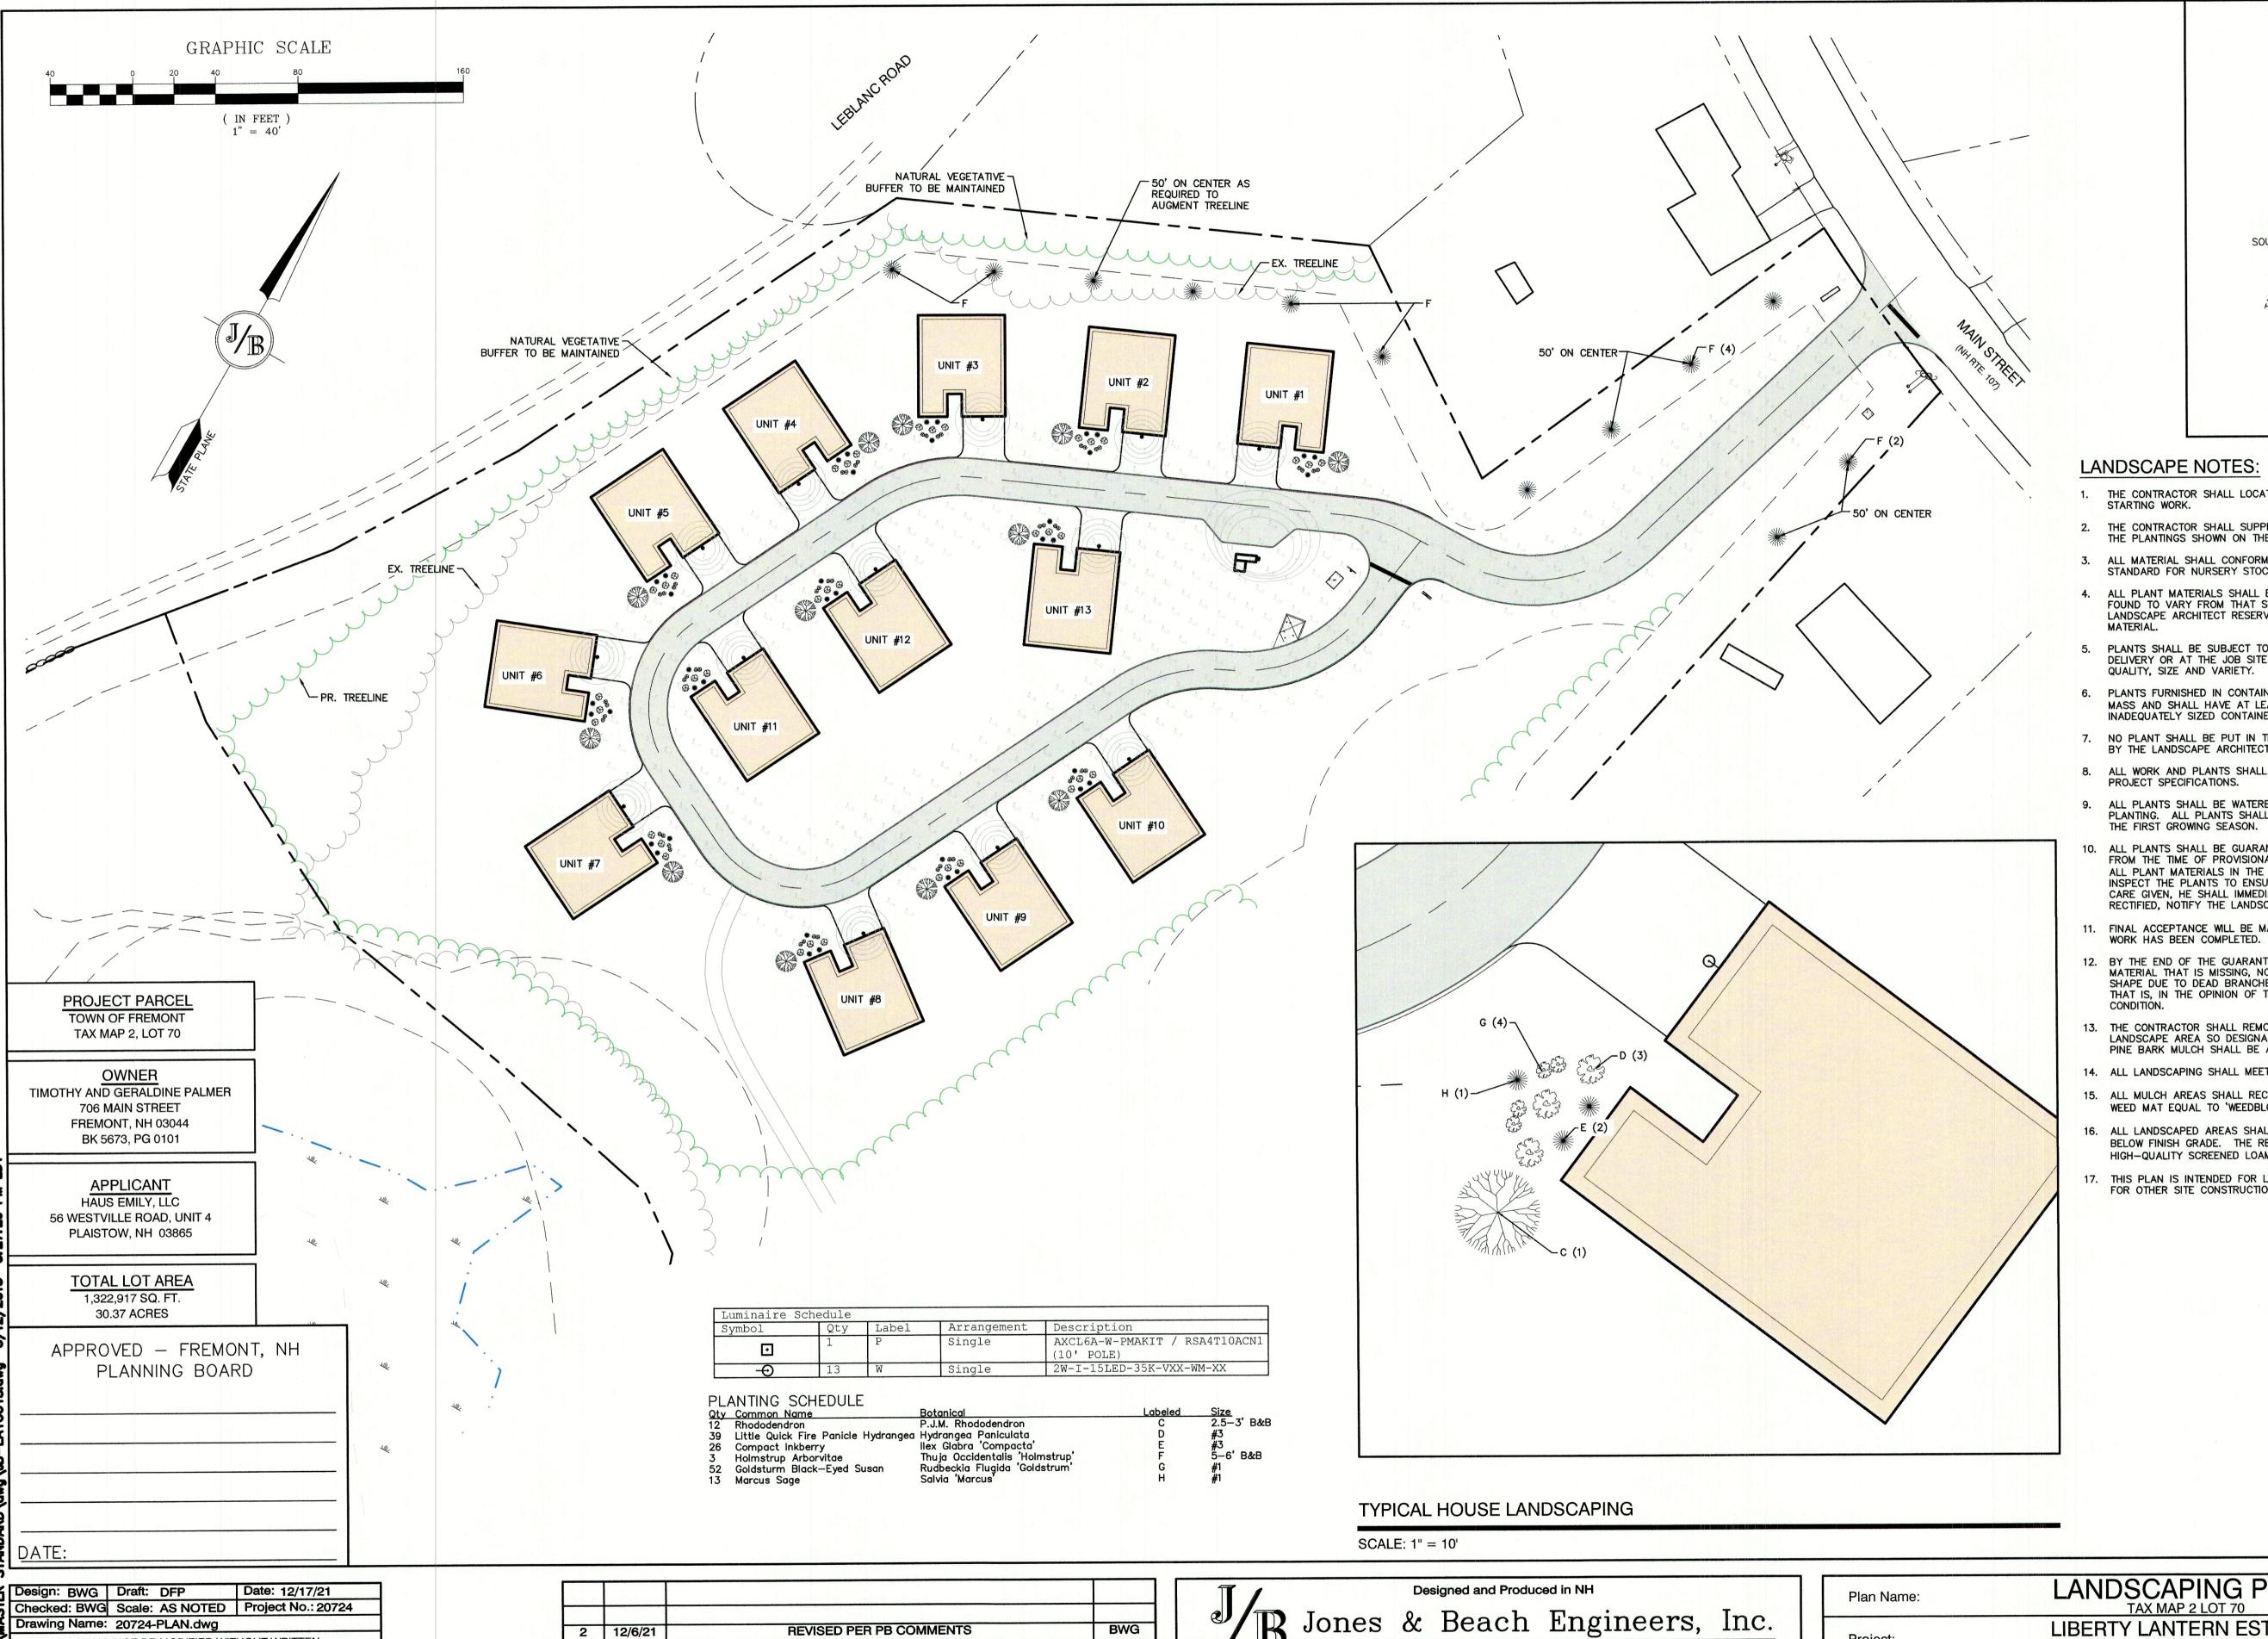

BWG

BWG

BY

PO Box 219

Stratham, NH 03885

REVISED PER TECHNICAL REVIEW

ISSUED FOR REVIEW

REVISION

11/22/21

DATE

0 10/6/21

REV.

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LOCUS SCALE: 1"=2000'

LANDSCAPE NOTES:


- THE CONTRACTOR SHALL LOCATE AND VERIFY THE EXISTENCE OF ALL UTILITIES PRIOR TO
- 2. THE CONTRACTOR SHALL SUPPLY ALL PLANT MATERIALS IN QUANTITIES SUFFICIENT TO COMPLETE THE PLANTINGS SHOWN ON THE DRAWINGS.
- 3. ALL MATERIAL SHALL CONFORM TO THE GUIDELINES ESTABLISHED BY THE CURRENT AMERICAN STANDARD FOR NURSERY STOCK PUBLISHED BY THE AMERICAN ASSOCIATION OF NURSERYMEN.
- 4. ALL PLANT MATERIALS SHALL BE EXACTLY AS SPECIFIED. IF PLANT SPECIES CULTIVARS ARE FOUND TO VARY FROM THAT SPECIFIED AT ANY TIME DURING THE GUARANTEE PERIOD, THE LANDSCAPE ARCHITECT RESERVES THE RIGHT TO HAVE THE CONTRACTOR REPLACE THAT PLANT
- PLANTS SHALL BE SUBJECT TO INSPECTION AND APPROVAL AT THE PLACE OF GROWTH, UPON DELIVERY OR AT THE JOB SITE WHILE WORK IS ON-GOING FOR CONFORMITY TO SPECIFIED
- PLANTS FURNISHED IN CONTAINERS SHALL HAVE THE ROOTS WELL ESTABLISHED IN THE SOIL MASS AND SHALL HAVE AT LEAST ONE (1) GROWING SEASON. ROOT-BOUND PLANTS OR INADEQUATELY SIZED CONTAINERS TO SUPPORT THE PLANT MAY BE DEEMED UNACCEPTABLE.
- 7. NO PLANT SHALL BE PUT IN THE GROUND BEFORE GRADING HAS BEEN FINISHED AND APPROVED BY THE LANDSCAPE ARCHITECT.
- 8. ALL WORK AND PLANTS SHALL BE DONE, INSTALLED AND DETAILED IN STRICT ACCORDANCE WITH PROJECT SPECIFICATIONS.
- 9. ALL PLANTS SHALL BE WATERED THOROUGHLY TWICE DURING THE FIRST 24—HOUR PERIOD AFTER PLANTING. ALL PLANTS SHALL BE WATERED WEEKLY, OR MORE OFTEN IF NECESSARY, DURING
- 10. ALL PLANTS SHALL BE GUARANTEED BY THE CONTRACTOR FOR NOT LESS THAN ONE FULL YEAR FROM THE TIME OF PROVISIONAL ACCEPTANCE. DURING THIS TIME, THE OWNER SHALL MAINTAIN ALL PLANT MATERIALS IN THE ABOVE MANNER. IT IS THE CONTRACTOR'S RESPONSIBILITY TO INSPECT THE PLANTS TO ENSURE PROPER CARE. IF THE CONTRACTOR IS DISSATISFIED WITH THE CARE GIVEN. HE SHALL IMMEDIATELY, AND IN SUFFICIENT TIME TO PERMIT THE CONDITION TO BE RECTIFIED, NOTIFY THE LANDSCAPE ARCHITECT IN WRITING OR OTHERWISE FORFEIT HIS CLAIM.
- 11. FINAL ACCEPTANCE WILL BE MADE UPON THE CONTRACTOR'S REQUEST AFTER ALL CORRECTIVE
- 12. BY THE END OF THE GUARANTEE PERIOD, THE CONTRACTOR SHALL HAVE REPLACED ANY PLANT MATERIAL THAT IS MISSING, NOT TRUE TO SIZE AS SPECIFIED, THAT HAS DIED, LOST NATURAL SHAPE DUE TO DEAD BRANCHES, EXCESSIVE PRUNING OR INADEQUATE OR IMPROPER CARE, OR THAT IS, IN THE OPINION OF THE LANDSCAPE ARCHITECT, IN UNHEALTHY OR UNSIGHTLY
- 13. THE CONTRACTOR SHALL REMOVE WEEDS, ROCKS, CONSTRUCTION ITEMS, ETC. FROM ANY LANDSCAPE AREA SO DESIGNATED TO REMAIN, WHETHER ON OR OFF-SITE. GRASS SEED OR PINE BARK MULCH SHALL BE APPLIED AS DEPICTED ON PLANS.
- 14. ALL LANDSCAPING SHALL MEET THE TOWN STANDARDS AND REGULATIONS.
- 15. ALL MULCH AREAS SHALL RECEIVE A 3" LAYER OF SHREDDED PINE BARK MULCH OVER A 10 MIL WEED MAT EQUAL TO 'WEEDBLOCK' BY EASY GARDENER OR DEWITT WEED BARRIER.
- 16. ALL LANDSCAPED AREAS SHALL HAVE SELECT MATERIALS REMOVED TO A DEPTH OF AT LEAST 9" BELOW FINISH GRADE. THE RESULTING VOID IS TO BE FILLED WITH A MINIMUM OF 9" HIGH-QUALITY SCREENED LOAM AMENDED WITH 3" OF AGED ORGANIC COMPOST.
- 17. THIS PLAN IS INTENDED FOR LANDSCAPING PURPOSES ONLY. REFER TO CIVIL/SITE DRAWINGS FOR OTHER SITE CONSTRUCTION INFORMATION.

85 Portsmouth Ave. Civil Engineering Services E-MAIL: JBE@JONESANDBEACH.COM


Project: FAX: 603-772-0227

LANDSCAPING PLAN TAX MAP 2 LOT 70 LIBERTY LANTERN ESTATES MAIN STREET, FREMONT, NH **TIMOTHY & GERALDINE PALMER** Owner of Record: 706 MAIN STREET, FREMONT, NH 03044

DRAWING No. **SHEET 12 OF 21** JBE PROJECT NO. 20724

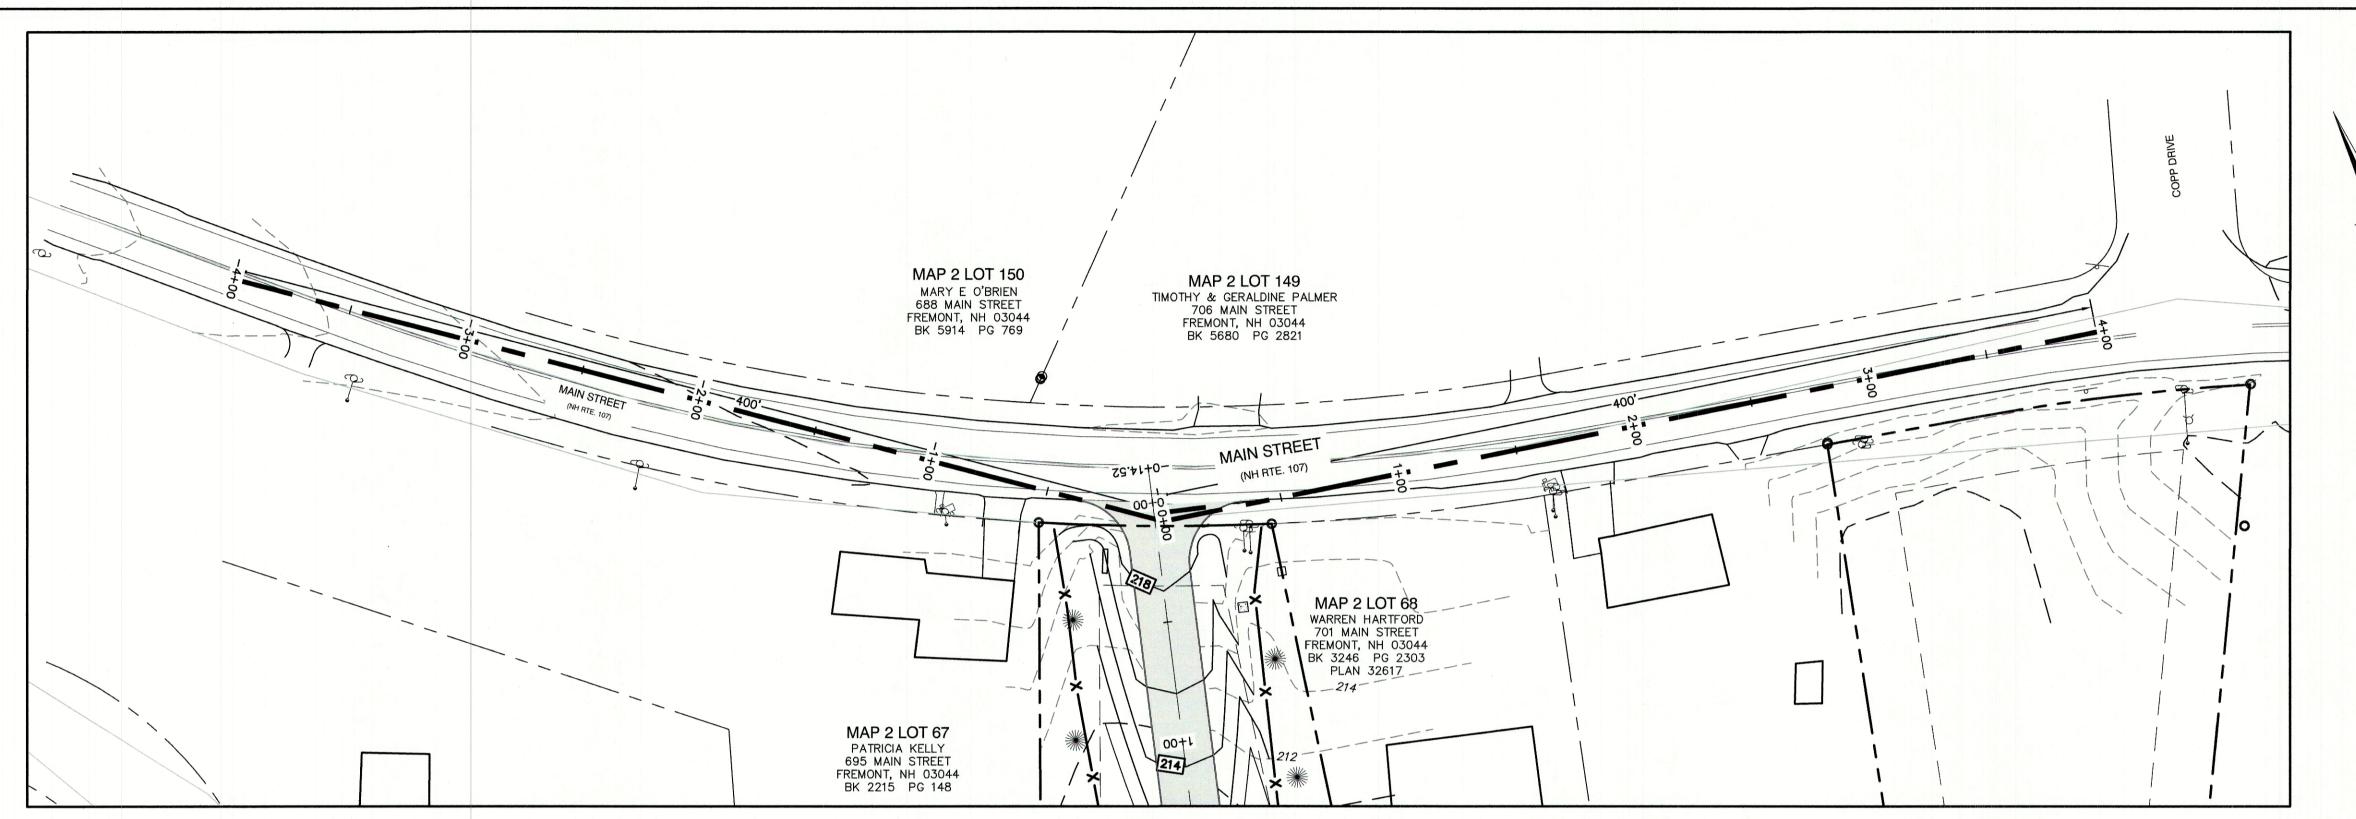

LIBERTY LANTERN ROAD / MAIN STREET INTERSECTION

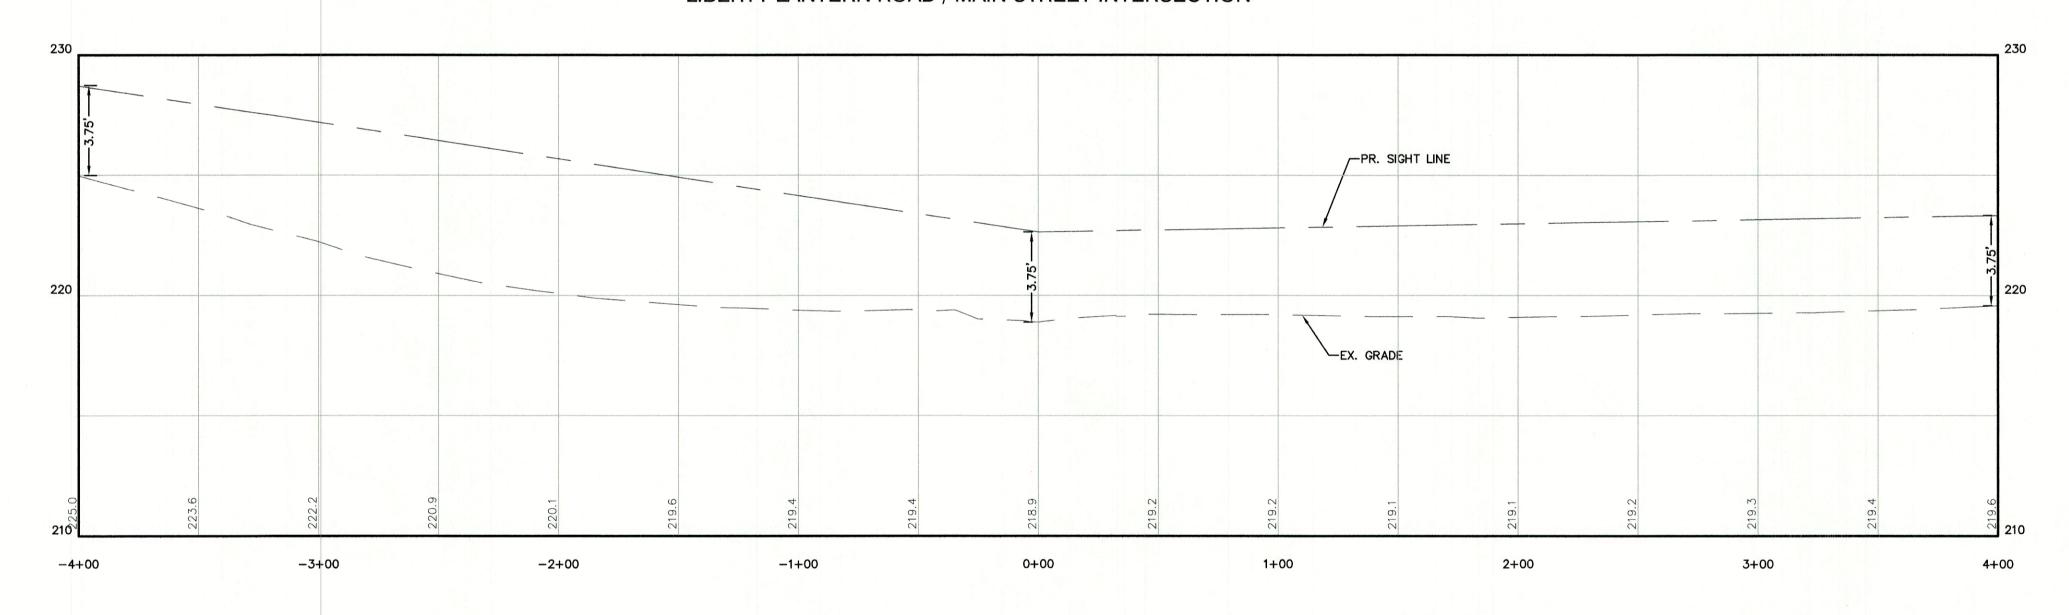




PROPERTY LINES
MAJOR CONTOUR
MINOR CONTOUR
EDGE OF PAVEMENT
SINGLE WHITE LINE
DOUBLE YELLOW LINE
STONEWALL
TREELINE
IRON PIPE/IRON ROD
DRILL HOLE
STONE/GRANITE BOUND
FRESHWATER WETLANDS

DESCRIPTION

UTILITY POLE

NOTES:

- 1. POSTED SPEED LIMIT= 40 MPH
- 2. SIGNS SHALL BE TO THE MANUAL OF UNIFORM TRAFFIC CONTROL DEVICES (MUTCD) STANDARDS AND NHDOT STANDARDS.
- 3. SIGN, HARDWARE, AND INSTALLATION TO CONFORM TO 2016 NHDOT STANDARD SPECIFICATIONS, SECTION 615 TRAFFIC SIGNS.
- 4. STOP BAR TO CONFORM TO NHDOT PM-9 STOP BAR DETAIL

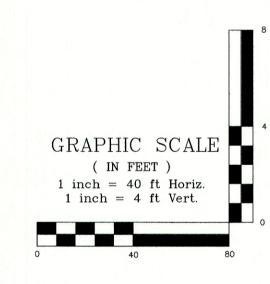

		TRA	FFIC	CONTROL	SCHED	ULE	
NUMBER	SIGN		F SIGN HEIGHT	DESCRIPTION	MOUNT TYPE	MOUNT HEIGHT	REMARKS
R1-1	STOP	30"	30"	WHITE ON RED	CHANNEL	7'-0"	REFLECTORIZED SIGN

Design: BWG Draft: DFP Date: 12/17/21
Checked: BWG Scale: AS NOTED Project No.: 20724
Drawing Name: 20724-PLAN.dwg
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2	12/6/21	REVISED PER PB COMMENTS	BWG
1	11/22/21	REVISED PER TECHNICAL REVIEW	BWG
0	10/6/21	ISSUED FOR REVIEW	BWG
REV.	DATE	REVISION	BY

Designed and Produced in NH

Jones & Beach Engineers, Inc.

85 Portsmouth Ave. Civil Engineering Services
PO Box 219

Designed and Produced in NH


Engineers, Inc.


603-772-4746
FAX: 603-772-0227


Stratham, NH 03885


E-MAIL: JBE@JONESANDBEACH.COM

Plan Name:	HIGHWAY ACCESS PLAN	
Project:	LIBERTY LANTERN ESTATES MAIN STREET, FREMONT, NH	
Owner of Record:	TIMOTHY & GERALDINE PALMER 706 MAIN STREET, FREMONT, NH 03044	

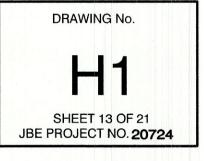

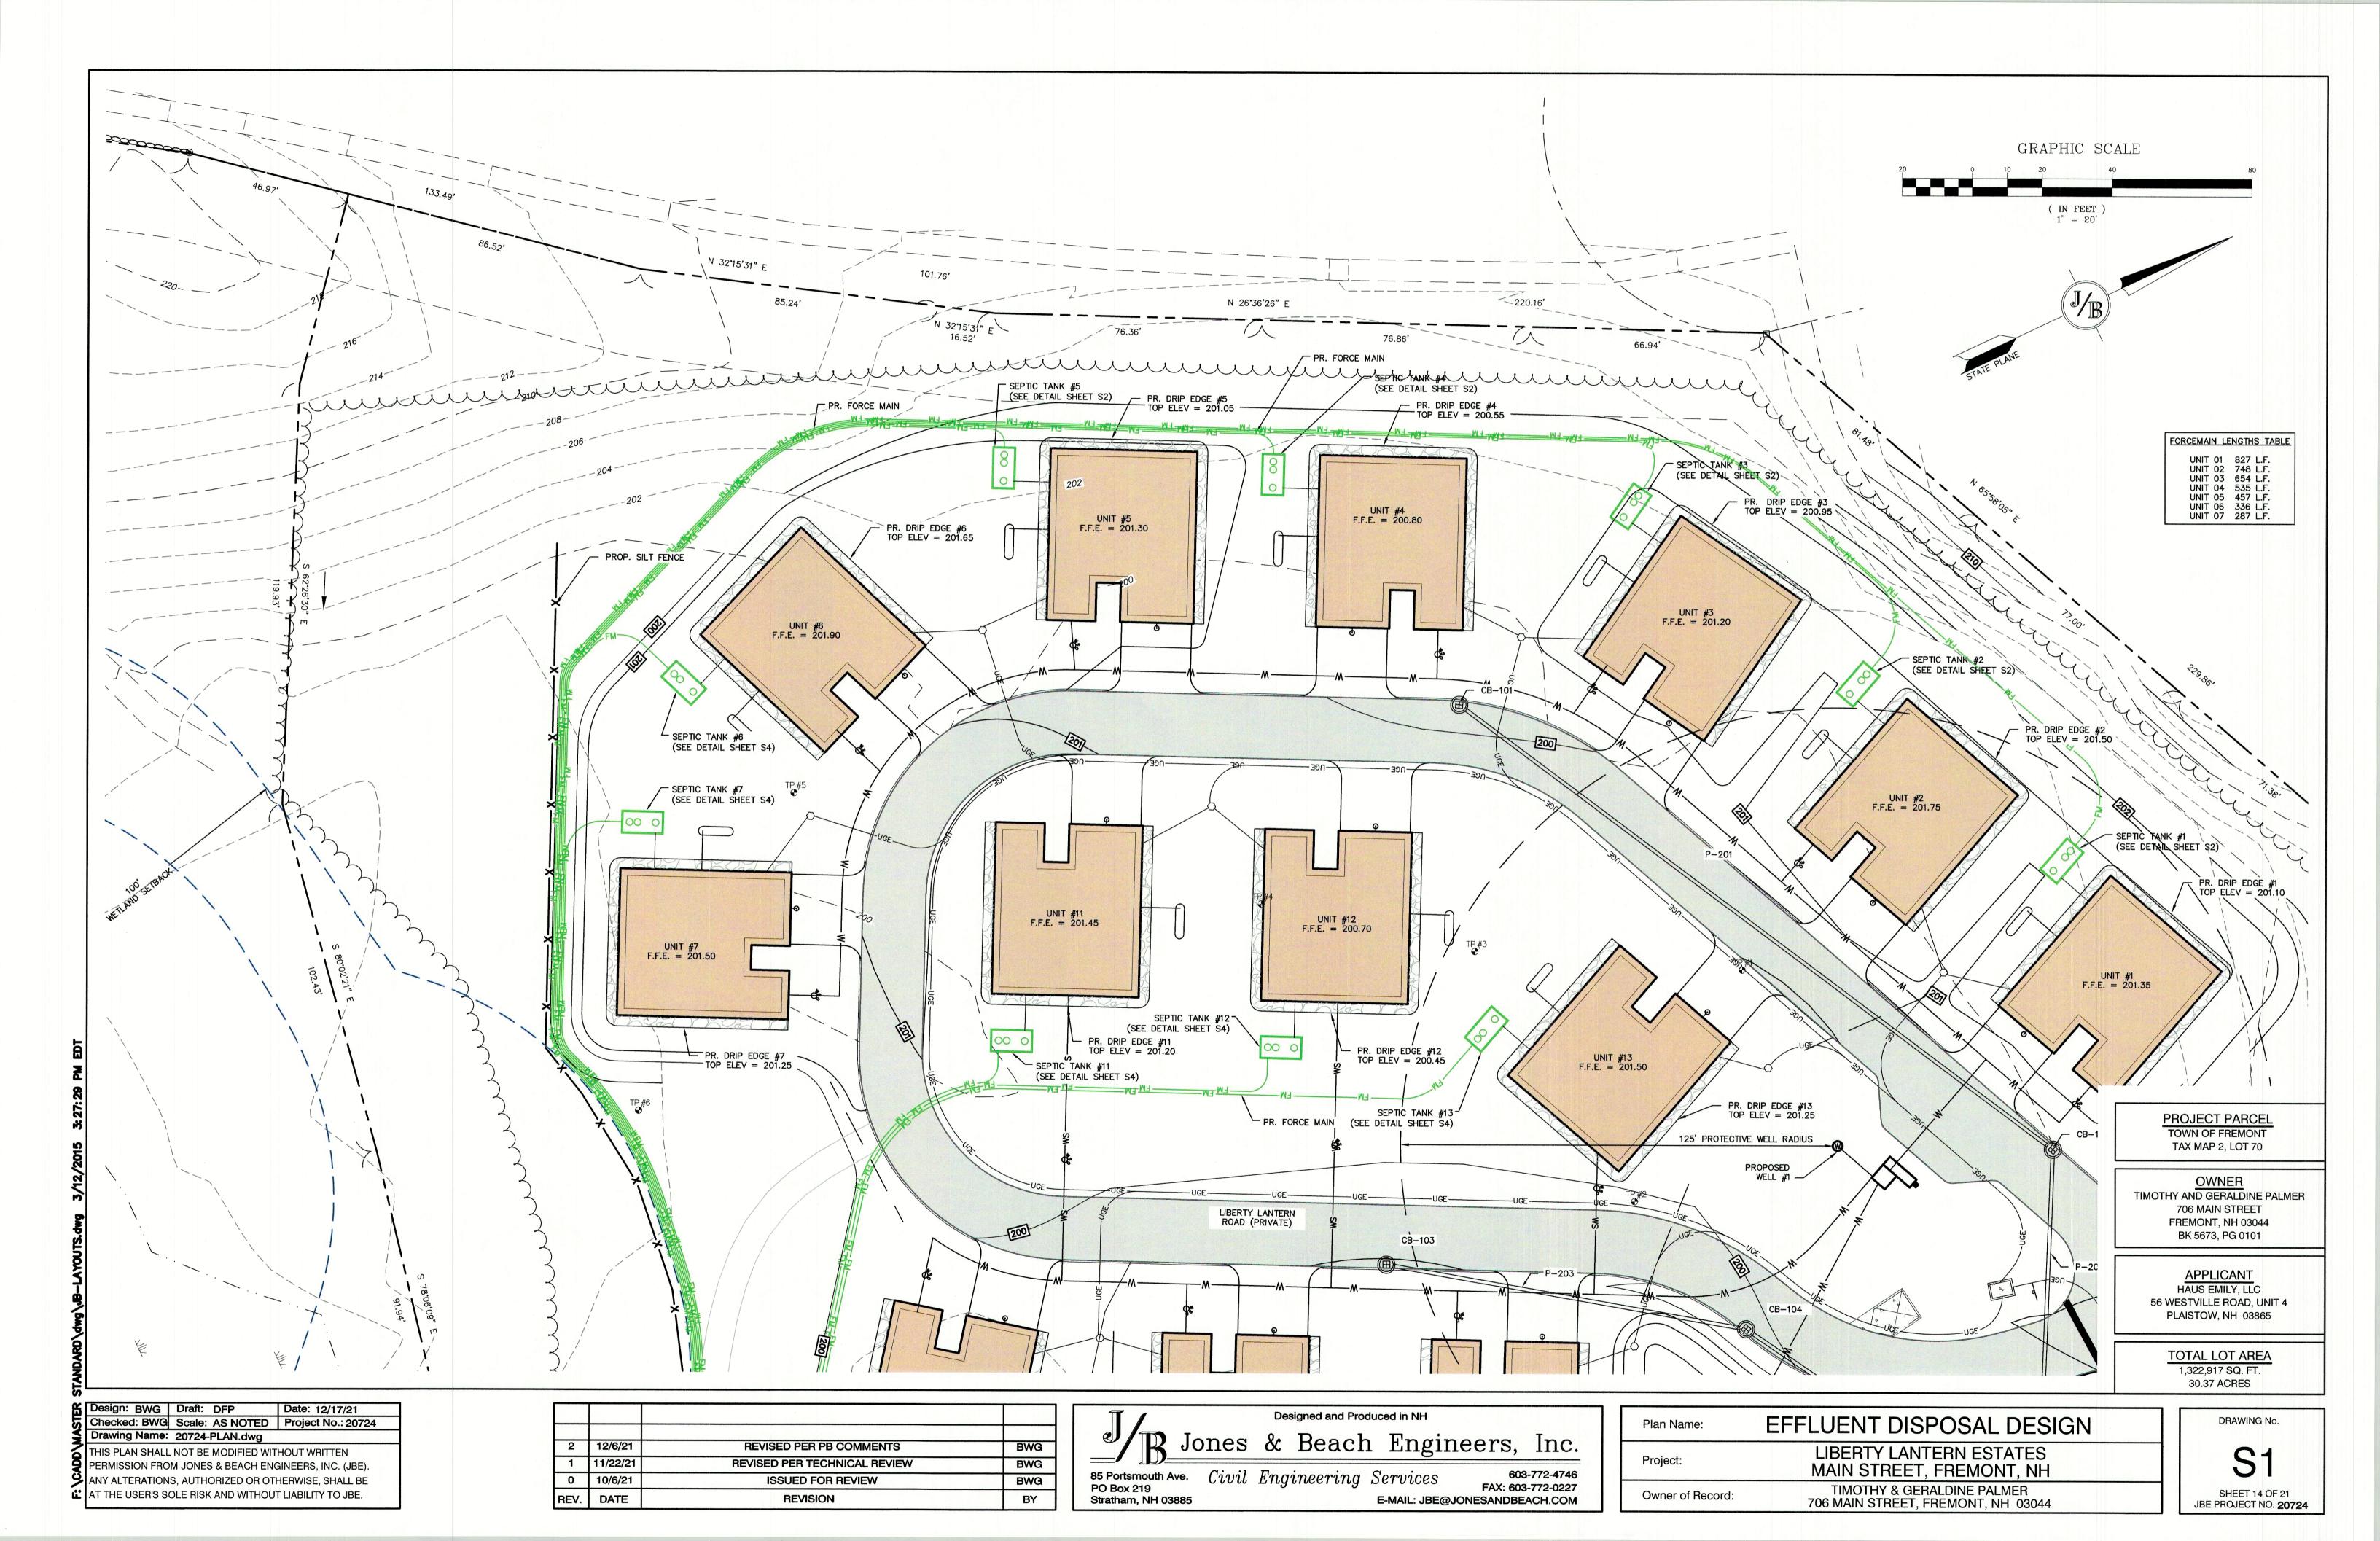

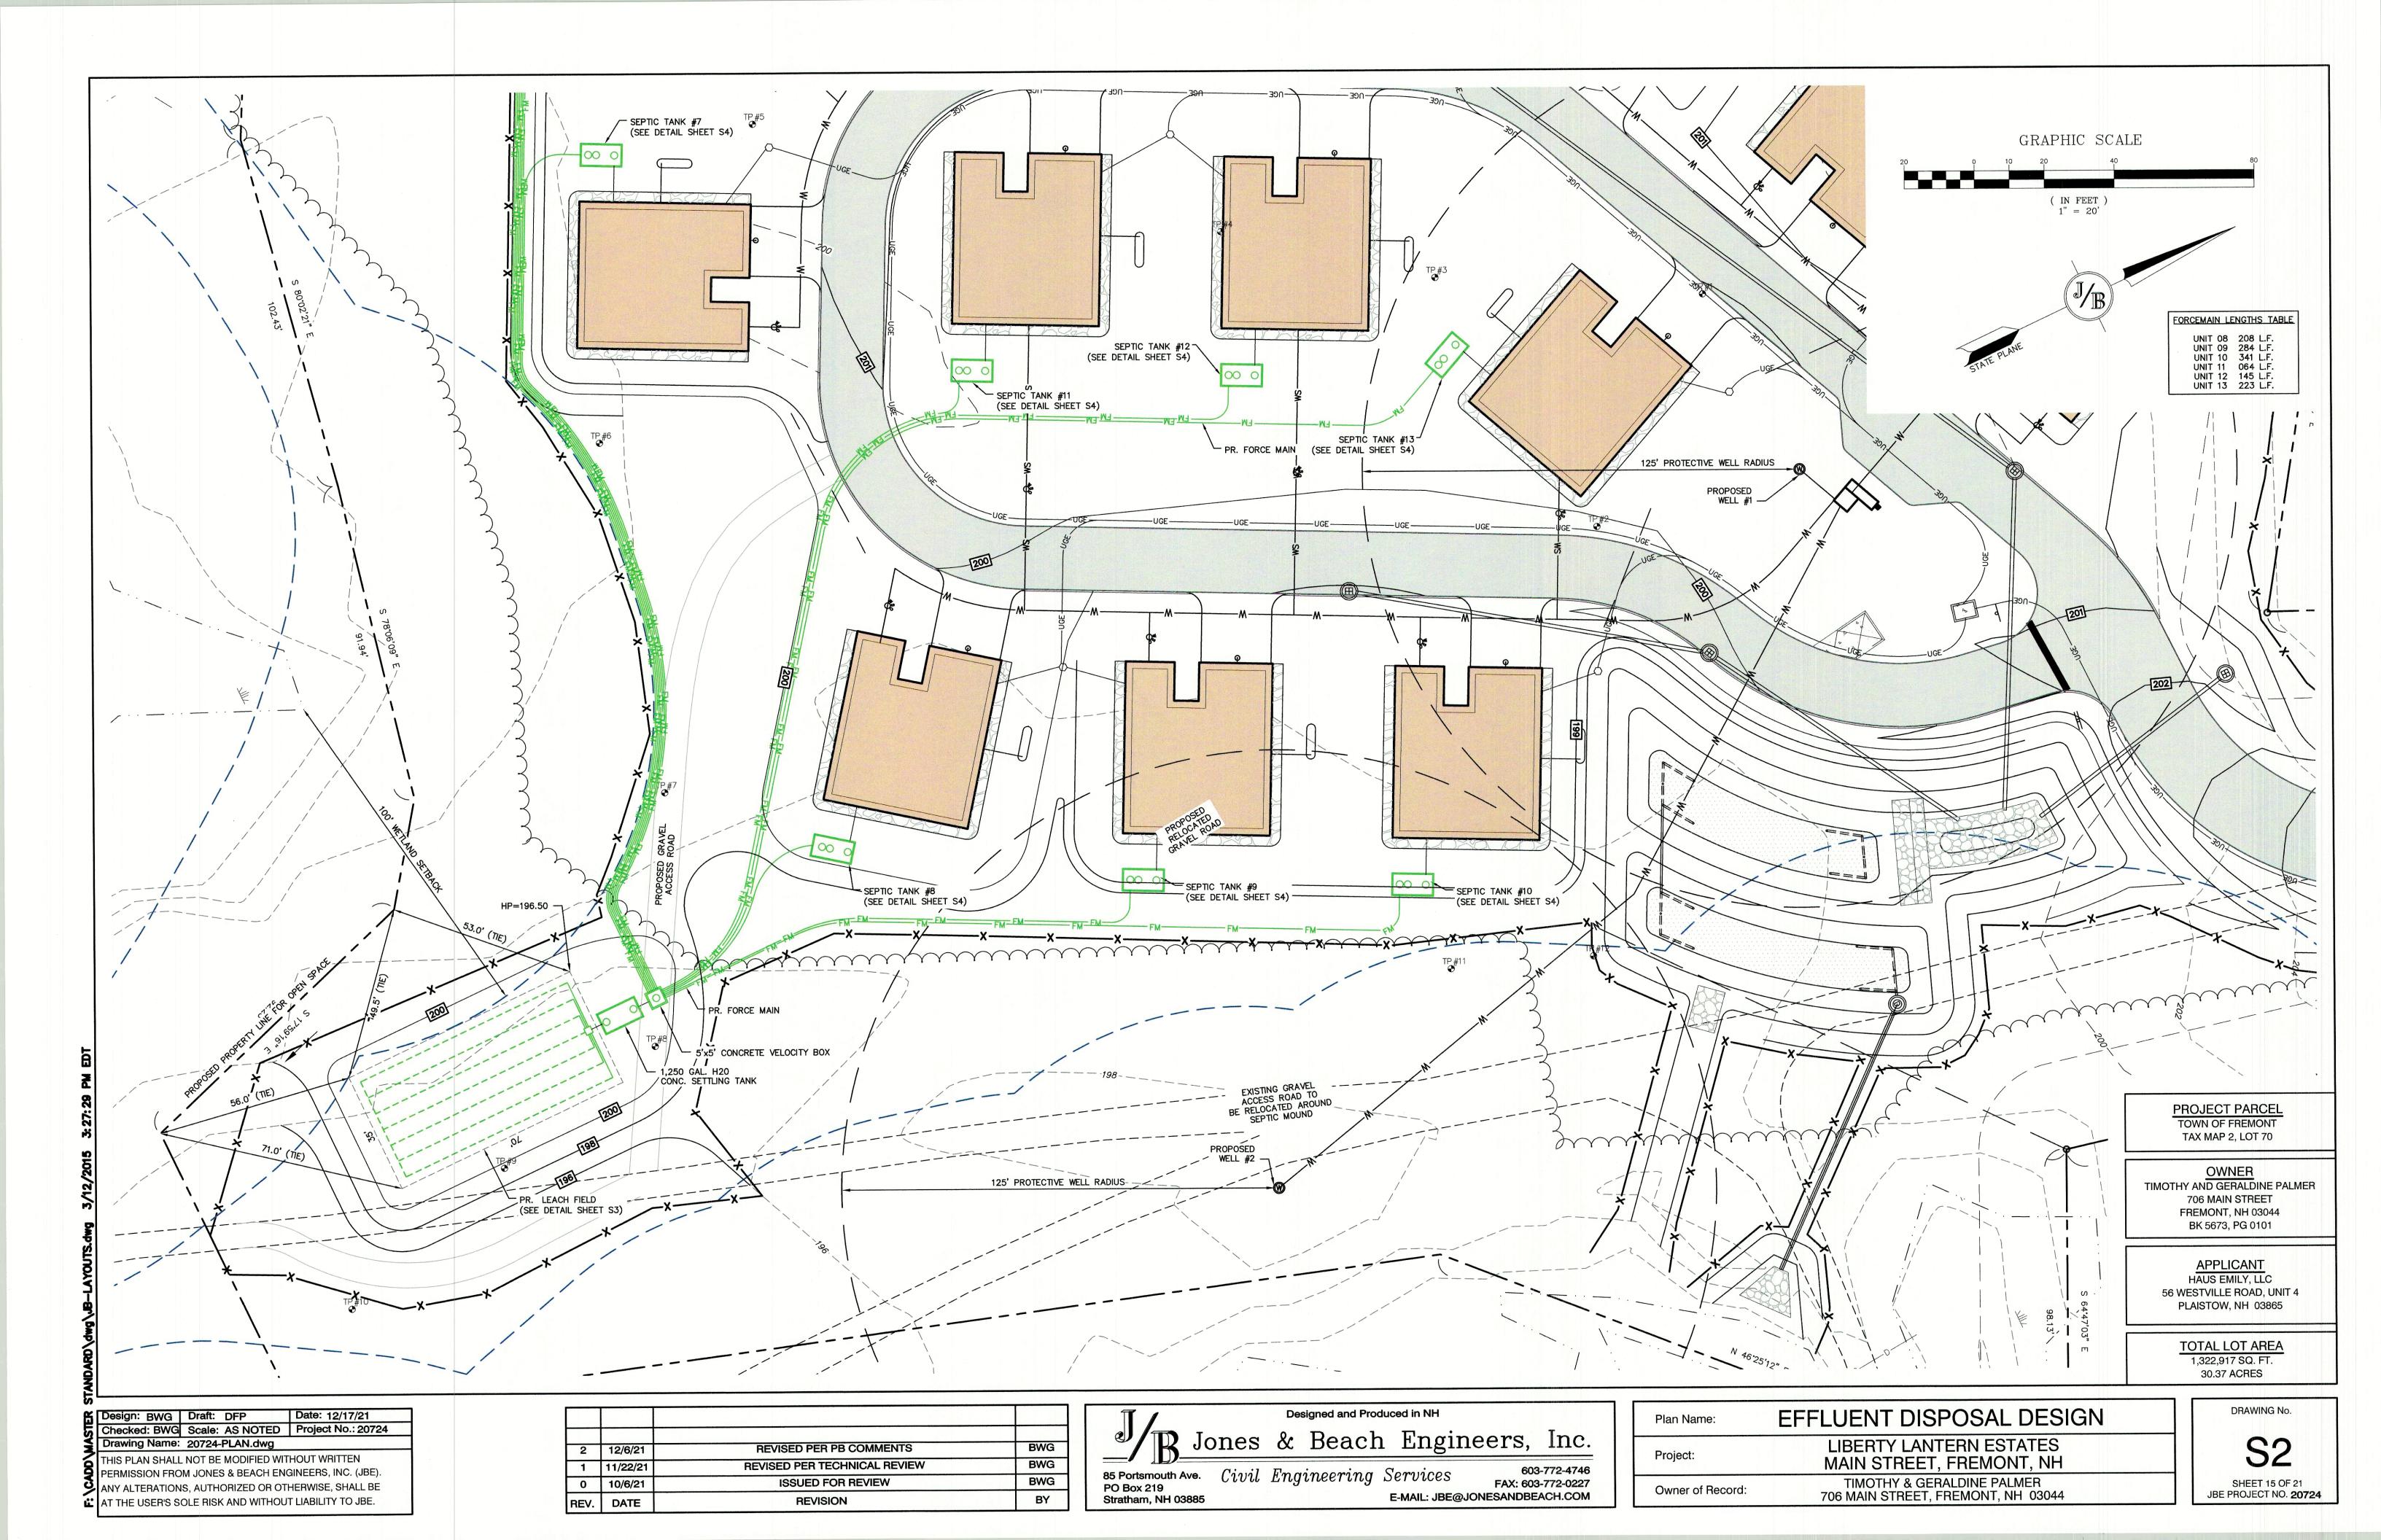

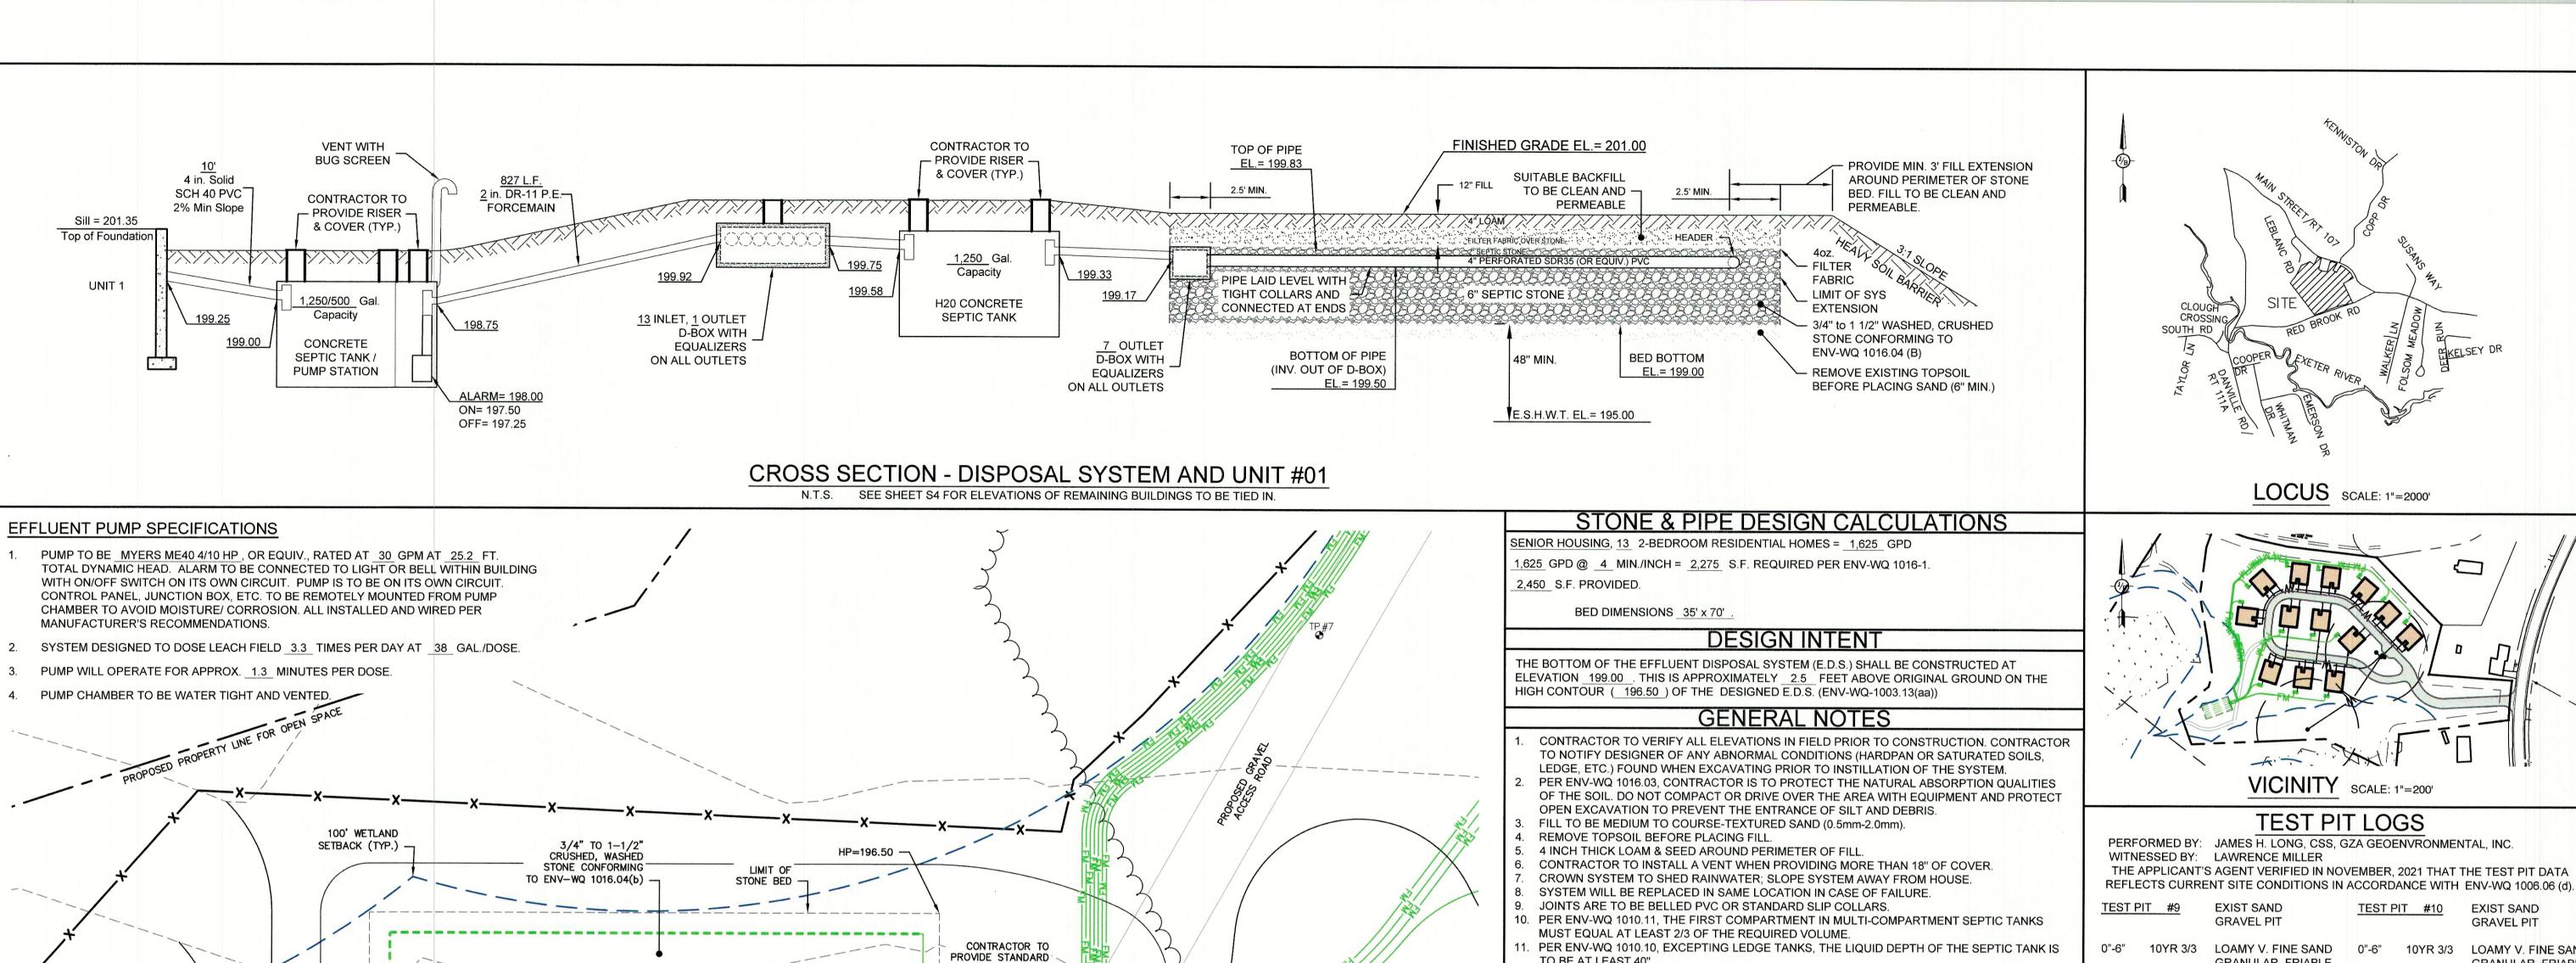

(IN FEET)

1 inch = 10 feet

PO Box 219

Stratham, NH 03885

24" H20 CAST IRON _____ FRAME AND COVER 7 OUTLET D-BOX 5'x5' CONCRETE VELOCITY BOX 2.5 1,250 GAL. H20 CONC. SETTLING TANK 4" SOLID SDR35 PVC 4" PERFORATED SDR35 DISTRUBUTION PIPES TO 90' ELBOW Dig Safe Systems, Inc. It's Smart. It's Easy. It's the Law. GRAPHIC SCALE - CONTRACTOR IS RESPONSIBLE FOR CONSTRUCTING THE SEPTIC PLAN FROM THE NHDES APPROVED PLAN THE BUILDER/SITE CONTRACTOR IS RESPONSIBLE TO CONFIRM THE ZONING DIMENSIONAL REQUIREMENTS AND SETBACK LINE REQUIREMENTS PRIOR TO INITIATING CONSTRUCTION OF THE PROPOSED HOUSE AND SEPTIC SYSTEM. THE ZONING ORDINANCE OF THE MUNICIPALITY

- TO BE AT LEAST 40".
- THE SURFACE EQUAL TO 40% OF THE LIQUID DEPTH AND SHALL EXTEND ABOVE THE LIQUID LINE TO NOT LESS THAN ONE INCH FROM THE TOP OF THE TANK.
- ALL CONNECTIONS BETWEEN A SEPTIC TANK AND THE PIPES LEADING TO AND EXITING FROM THE SEPTIC TANK SHALL BE SEALED WITH A WATERTIGHT, FLEXIBLE JOINT CONNECTOR THAT: (1) WILL ACCOMMODATE NORMAL MOVEMENT OF THE SEPTIC TANK WITHOUT LEAKING OR BREAKING; AND (2) HAS BEEN CERTIFIED BY ITS MANUFACTURER OR DISTRIBUTOR AS MEETING OR EXCEEDING THE APPLICABLE STANDARD IN ASTM C 1644-06, SECTION 7.
- CONTRACTOR TO PROVIDE RISERS FOR TANKS WITH MORE THAN 12" OF COVER. IF GARBAGE GRINDERS ARE DESIRED, SEPTIC TANK SHALL BE 50% LARGER. IF A BASEMENT EJECTOR PUMP IS DESIRED, SEPTIC TANK SHALL BE INCREASED BY 250 GALLONS.
- APPROVAL FOR CONSTRUCTION IS VALID FOR 4 YEARS FROM DATE OF ISSUE, EXCEPT APPROVAL IS ONLY VALID FOR 90 DAYS FOR FAILED SYSTEM REPLACEMENTS.
- TOWN OF FREMONT REQUIRES BED BOTTOM INSPECTION. 18. PVC PIPING TO BE SUPPLIED BY: ELIMINATOR SYSTEMS INC. (603) 868-2242) OR EQUAL.
- SEPTIC TANK & D-BOX TO BE SUPPLIED BY: SHEA CONCRETE (800-696-7432) OR EQUAL.
- 20. ROCKINGHAM COUNTY SOIL CONSERVATION SERVICE SOIL TYPE: PITS, SAND AND GRAVEL 21. ANY CHANGES TO SEPTIC TANK, BUILDING OR WELL LOCATION/ORIENTATION WILL REQUIRE AN AS-BUILT PLAN TO BE PROVIDED BY THE DESIGNER PRIOR TO NHDES FINAL INSPECTION.
- 22. PER ENV-WQ 1004.10, SYSTEMS OVER 2,500 GPD ARE TO BE INSPECTED BY DESIGNER. 23. PER ENV-WQ 1003.13(a)(3) THERE ARE NO KNOWN BURIAL SITES OR CEMETERIES ON THE LOT
- WITHIN 100' OF ANY COMPONENT OF THE ISDS. 24. 50' SETBACK FROM POORLY DRAINED SOILS.

LESS THAN 20' FROM GROUND SURFACE

SUBDIVISION APPROVAL #

GROUTING THE CASING

E-MAIL: JBE@JONESANDBEACH.COM

- 25. ALL SEWER PIPE WITHIN 75' OF AN ON-SITE WELL SHALL BE SDR26 OR EQUIVALENT IN ACCORDANCE WITH ENV-WQ 1008.04(c)(1).
- 26. ALL SEPTIC TANKS SHALL BE COATED WITH A SEALANT TO PREVENT INFILTRATION AND EXFILTRATION IN ACCORDANCE WITH ENV-WQ 1008.04(c)(2).

REFERENCES

WELL LOCATION

IF THE WELL IS LOCATED LESS THAN 50' FROM THE STATE HIGHWAY RIGHT-OF-WAY AND OR

LESS THAN 75' FROM THE PROPERTY LINE WITH DESIGN FLOWS FOR STRUCTURES UP TO 5

BEDROOMS. SPECIAL METHODS OF CONSTRUCTION SHALL INCLUDE BUT NOT BE LIMITED TO:

INSTALL NO LESS THAN 40' OF CASING INTO COMPETENT BEDROCK WHERE BEDROCK IS

ISSUED:

NO REFUSAL TEST PIT, DATE: JUNE 29, 2021 TEST PIT, DATE: JUNE 29, 2021 PERC. TEST, DATE: JUNE 29, 2021 ◆ PERC. TEST, DATE: JUNE 29, 2021 4 MIN./INCH 4 MIN./INCH

LOCUS SCALE: 1"=2000'

VICINITY SCALE: 1"=200"

TEST PIT LOGS

SAND, SINGLE-GRAIN, 6"-20" 2.5Y 5/4

EXIST SAND

LOOSE

LOOSE

LOOSE

GRAVEL PIT

GRANULAR, FRIABLE

SAND, SINGLE-GRAIN,

COBBLY, GRAVELLY,

COARSE SAND.

SINGLE-GRAIN,

EXIST SAND

GRAVEL PIT

20"-36" 2.5Y 6/3 COBBLY, GRAVELLY

LOOSE

LOAMY V. FINE SAND

GRANULAR, FRIABLE

COBBLY, GRAVELLY

SAND, SINGLE-GRAIN

SAND, SINGLE-GRAIN

COBBLY, GRAVELLY

COARSE SAND

SINGLE-GRAIN,

WETLAND DELINEATION

WETLANDS ON-SITE WERE DELINEATED BY:

DATE: WINTER, 2020

SHWT = 18"

H₂O AT 48"

ROOTS to 20"

NO REFUSAL

6"-18" 10YR 5/4

18"-30" 2.5Y 5/4

30"-60" 2.5Y 4/3

CLOUGH

SOUTH RD

JAMES H. LONG, CSS GZA GEOENVIRONMENTAL, INC. 5 COMMERCE PARK NORTH, SUITE 201 BEDFORD, NH 03110

36"-64" 2.5Y 6/3

SHWT = 20"

H₂O AT 52"

ROOTS to 20"

OWNER NOTES

- KNOW THE LOCATION OF YOUR SEPTIC TANK AND LEACHING AREA. INSPECT YOUR SEPTIC TANK YEARLY. HAVE THE SEPTIC TANK PUMPED AS NEEDED
- BUT AT LEAST ONCE EVERY THREE YEARS. DO NOT FLUSH BULKY ITEMS SUCH AS DIAPERS, SANITARY PADS OR BABY WIPES. DO NOT FLUSH TOXIC CHEMICALS SUCH AS PAINT THINNERS, DRANO, PESTICIDES, OR CHLORINE, AS THEY MAY KILL THE NECESSARY BACTERIA IN THE SEPTIC TANK
- REPAIR LEAKING FIXTURES IN THE BUILDING PROMPTLY BE CONSERVATIVE WITH WATER USE, SPREAD OUT USE OVER TIME, AND USE WATER-REDUCING FIXTURES WHENEVER AND WHEREVER POSSIBLE. TOO MUCH USE IN A SHORT TIME CAN OVERLOAD THE SYSTEM, WHICH MAY LEAD TO FAILURE MOW YOUR LEACHING AREA REGULARLY. PREVENT DEEP-ROOTED TREES AND
- SHRUBS FROM GROWING ON AND ADJACENT TO YOUR LEACHING AREA. NO VEHICULAR TRAVEL, LIVESTOCK TRAVEL, OR SNOW REMOVAL IN AREA OF

SYSTEM, UNLESS SPECIFICALLY DESIGNED FOR H20 LOADING.

Design: BWG | Draft: DFP Date: 12/17/21 Checked: BWG Scale: AS NOTED | Project No.: 20724 Drawing Name: 20724-PLAN.dwg THIS PLAN SHALL NOT BE MODIFIED WITHOUT WRITTEN PERMISSION FROM JONES & BEACH ENGINEERS, INC. (JBE). ANY ALTERATIONS, AUTHORIZED OR OTHERWISE, SHALL BE

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LOCATION AND BED-BOTTOM INSPECTIONS.

IS TO BE COMPLIED WITH. THE BUILDER/SITE CONTRACTOR IS ALSO RESPONSIBLE TO CONTACT

THE MUNICIPALITY REGARDING INSPECTIONS PRIOR TO AND DURING CONSTRUCTION, I.E.

2	12/6/21	REVISED PER PB COMMENTS	BWG
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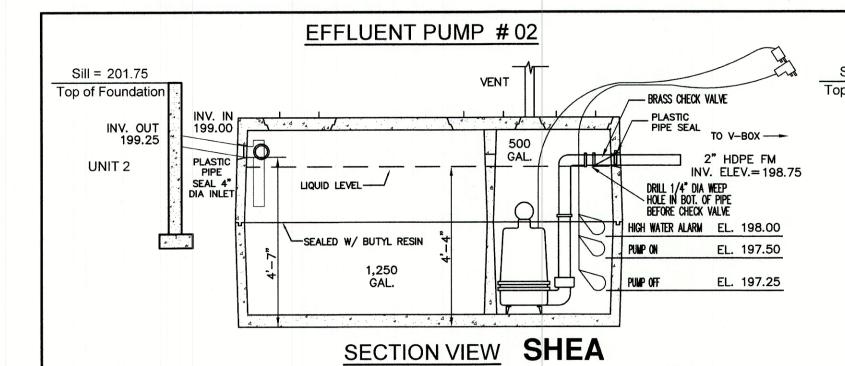
Project: 603-772-4746 FAX: 603-772-0227 Owner of Record:

INSTALLATION SHALL COMPLY WITH 'We 602.05' WELL LOCATION RULES

EFFLUENT DISPOSAL DESIGN Plan Name:


CO SHEET 16 OF 21 JBE PROJECT NO. 20724

DRAWING No. LIBERTY LANTERN ESTATES MAIN STREET, FREMONT, NH **TIMOTHY & GERALDINE PALMER** 706 MAIN STREET, FREMONT, NH 03044



EFFLUENT PUMP SPECIFICATIONS

- PUMP TO BE MYERS ME40 4/10 HP, OR EQUIV., RATED AT 31 GPM AT 24.5 FT. TOTAL DYNAMIC HEAD. ALARM TO BE CONNECTED TO LIGHT OR BELL WITHIN BUILDING WITH ON/OFF SWITCH ON ITS OWN CIRCUIT. PUMP IS TO BE ON ITS OWN CIRCUIT, CONTROL PANEL, JUNCTION BOX, ETC. TO BE REMOTELY MOUNTED FROM PUMP CHAMBER TO AVOID MOISTURE/ CORROSION. ALL INSTALLED AND WIRED PER MANUFACTURER'S RECOMMENDATIONS.
- 2. SYSTEM DESIGNED TO DOSE LEACH FIELD 3.3 TIMES PER DAY AT 38 GAL./DOSE
- PUMP WILL OPERATE FOR APPROX. 1.2 MINUTES PER DOSE
- PUMP CHAMBER TO BE WATER TIGHT AND VENTED.

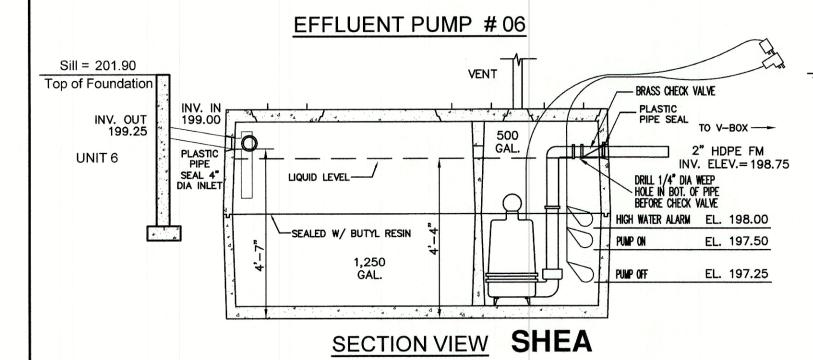

EFFLUENT PUMP SPECIFICATIONS

- PUMP TO BE BARNES SE411 4/10 HP, OR EQUIV., RATED AT 31 GPM AT 13.3 FT. TOTAL DYNAMIC HEAD. ALARM TO BE CONNECTED TO LIGHT OR BELL WITHIN BUILDING WITH ON/OFF SWITCH ON ITS OWN CIRCUIT. PUMP IS TO BE ON ITS OWN CIRCUIT. CONTROL PANEL, JUNCTION BOX, ETC. TO BE REMOTELY MOUNTED FROM PUMP CHAMBER TO AVOID MOISTURE/ CORROSION. ALL INSTALLED AND WIRED PER MANUFACTURER'S RECOMMENDATIONS.
- SYSTEM DESIGNED TO DOSE LEACH FIELD 3.3 TIMES PER DAY AT 38 GAL./DOSE
- 3. PUMP WILL OPERATE FOR APPROX. 1.2 MINUTES PER DOSE.
- 4. PUMP CHAMBER TO BE WATER TIGHT AND VENTED.

EFFLUENT PUMP # 10 Sill = 199.80VENT Top of Foundation ----- BRASS CHECK VALVE INV. OU 197.2 TO V-BOX --GAL. PLASTIC PIPE UNIT 10 INV. ELEV.= 196.75 LIQUID LEVEL-BEFORE CHECK VALVE HIGH WATER ALARM EL. 196.00 -SEALED W/ BUTYL RESIN EL. 195.50 EL. 195.25 SECTION VIEW SHEA

EFFLUENT PUMP SPECIFICATIONS

- PUMP TO BE BARNES SE411 4/10 HP , OR EQUIV., RATED AT 30 GPM AT 14.8 FT. TOTAL DYNAMIC HEAD. ALARM TO BE CONNECTED TO LIGHT OR BELL WITHIN BUILDING WITH ON/OFF SWITCH ON ITS OWN CIRCUIT. PUMP IS TO BE ON ITS OWN CIRCUIT. CONTROL PANEL, JUNCTION BOX, ETC. TO BE REMOTELY MOUNTED FROM PUMP CHAMBER TO AVOID MOISTURE/ CORROSION. ALL INSTALLED AND WIRED PER MANUFACTURER'S RECOMMENDATIONS.
- SYSTEM DESIGNED TO DOSE LEACH FIELD 3.3 TIMES PER DAY AT 38 GAL./DOSE

Date: 12/17/21

- PUMP WILL OPERATE FOR APPROX. 1.3 MINUTES PER DOSE
- PUMP CHAMBER TO BE WATER TIGHT AND VENTED.

Design: BWG | Draft: DFP

EFFLUENT PUMP # 03 Sill = 201.20Top of Foundation ----- BRASS CHECK VALVE INV. OU 198.7 198.50 500 2" HDPF FM INV. ELEV.= 198.25 SEAL 4" DIA INLET BEFORE CHECK VALVE HIGH WATER ALARM EL. 197.50 -SEALED W/ BUTYL RESIN EL. 197.00 EL. 196.75

SECTION VIEW SHEA

EFFLUENT PUMP SPECIFICATIONS

- PUMP TO BE MYERS ME40 4/10 HP, OR EQUIV., RATED AT 33 GPM AT 24.8 FT. TOTAL DYNAMIC HEAD. ALARM TO BE CONNECTED TO LIGHT OR BELL WITHIN BUILDING WITH ON/OFF SWITCH ON ITS OWN CIRCUIT. PUMP IS TO BE ON ITS OWN CIRCUIT. CONTROL PANEL, JUNCTION BOX, ETC. TO BE REMOTELY MOUNTED FROM PUMP CHAMBER TO AVOID MOISTURE/ CORROSION. ALL INSTALLED AND WIRED PER MANUFACTURER'S RECOMMENDATIONS.
- SYSTEM DESIGNED TO DOSE LEACH FIELD 3.3 TIMES PER DAY AT 38 GAL./DOSE.
- PUMP WILL OPERATE FOR APPROX. 1.2 MINUTES PER DOSE
- 4. PUMP CHAMBER TO BE WATER TIGHT AND VENTED

EFFLUENT PUMP # 07 Sill = 201.50Top of Foundation 198.50 TO V-BOX ---500 1.5" HDPE FM PLASTIC UNIT 7 INV. ELEV.= 198.25 LIQUID LEVEL---1/4" DIA WEEP HOLE IN BOT. OF PIPE BEFORE CHECK VALVE HIGH WATER ALARM EL. 197.50 -SEALED W/ BUTYL RESIN EL. 197.00 SECTION VIEW SHEA

EFFLUENT PUMP SPECIFICATIONS

PUMP TO BE MYERS ME3F 1/3 HP, OR EQUIV., RATED AT 27 GPM AT 23.8 FT. TOTAL DYNAMIC HEAD. ALARM TO BE CONNECTED TO LIGHT OR BELL WITHIN BUILDING WITH ON/OFF SWITCH ON ITS OWN CIRCUIT. PUMP IS TO BE ON ITS OWN CIRCUIT. CONTROL PANEL, JUNCTION BOX, ETC. TO BE REMOTELY MOUNTED FROM PUMP CHAMBER TO AVOID MOISTURE/ CORROSION. ALL INSTALLED AND WIRED PER MANUFACTURER'S RECOMMENDATIONS.

EFFLUENT PUMP # 11

VENT

SECTION VIEW SHEA

PUMP TO BE BARNES SE411 4/10 HP , OR EQUIV., RATED AT 33 GPM AT 13.1 FT. TOTAL DYNAMIC

OWN CIRCUIT. PUMP IS TO BE ON ITS OWN CIRCUIT. CONTROL PANEL, JUNCTION BOX, ETC. TO BE

SYSTEM DESIGNED TO DOSE LEACH FIELD 3.3 TIMES PER DAY AT 38 GAL./DOSE.

HEAD. ALARM TO BE CONNECTED TO LIGHT OR BELL WITHIN BUILDING WITH ON/OFF SWITCH ON ITS

REMOTELY MOUNTED FROM PUMP CHAMBER TO AVOID MOISTURE/ CORROSION. ALL INSTALLED AND

500

GAL.

BY

----- BRASS CHECK VALVE

BEFORE CHECK VALVE

HIGH WATER ALARM EL. 197.50

1.5" HDPE FM

EL. 197.00

EL. 196.75

2. SYSTEM DESIGNED TO DOSE LEACH FIELD 3.3 TIMES PER DAY AT 38 GAL./DOSE.

LIQUID LEVEL-

-SEALED W/ BUTYL RESIN

- 3. PUMP WILL OPERATE FOR APPROX. 1.4 MINUTES PER DOSE.
- 4. PUMP CHAMBER TO BE WATER TIGHT AND VENTED

PLASTIC PIPE

DIA INLET

EFFLUENT PUMP SPECIFICATIONS

Sill = 201.45

Top of Foundation

UNIT 11

REV. DATE

INV. OUT


198.7

PUMP WILL OPERATE FOR APPROX. 1.1 MINUTES PER DOSE 4. PUMP CHAMBER TO BE WATER TIGHT AND VENTED. EFFLUENT PUMP # 08 Sill = 200.55VENT

SYSTEM DESIGNED TO DOSE LEACH FIELD 3.3 TIMES PER DAY AT 38 GAL./DOSE.

LIQUID LEVEL----

-SEALED W/ BUTYL RESIN

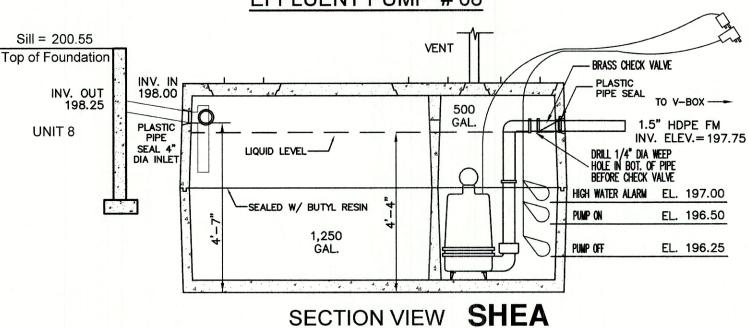

EFFLUENT PUMP # 04

VENT

SECTION VIEW SHEA

PUMP TO BE MYERS ME40 4/10 HP , OR EQUIV., RATED AT 35 GPM AT 23.8 FT. TOTAL DYNAMIC

OWN CIRCUIT. PUMP IS TO BE ON ITS OWN CIRCUIT. CONTROL PANEL, JUNCTION BOX, ETC. TO BE

HEAD. ALARM TO BE CONNECTED TO LIGHT OR BELL WITHIN BUILDING WITH ON/OFF SWITCH ON ITS

REMOTELY MOUNTED FROM PUMP CHAMBER TO AVOID MOISTURE/ CORROSION. ALL INSTALLED AND

500

--- Brass Check Valve

BEFORE CHECK VALVE

HIGH WATER ALARM EL. 197.00

2" HDPE FM

INV. ELEV.= 197.75

EL. 196.25

EFFLUENT PUMP SPECIFICATIONS

EFFLUENT PUMP SPECIFICATIONS

WIRED PER MANUFACTURER'S RECOMMENDATIONS.

Sill = 200.80

UNIT 4

Top of Foundation

INV. OU'

198.2

- PUMP TO BE MYERS ME3F 1/3 HP, OR EQUIV., RATED AT 30 GPM AT 22.8 FT. TOTAL DYNAMIC HEAD. ALARM TO BE CONNECTED TO LIGHT OR BELL WITHIN BUILDING WITH ON/OFF SWITCH ON ITS OWN CIRCUIT. PUMP IS TO BE ON ITS OWN CIRCUIT. CONTROL PANEL, JUNCTION BOX, ETC. TO BE REMOTELY MOUNTED FROM PUMP CHAMBER TO AVOID MOISTURE/ CORROSION. ALL INSTALLED AND WIRED PER MANUFACTURER'S RECOMMENDATIONS.
- SYSTEM DESIGNED TO DOSE LEACH FIELD 3.3 TIMES PER DAY AT 38 GAL./DOSE.
- PUMP WILL OPERATE FOR APPROX. 1.3 MINUTES PER DOSE.
- PUMP CHAMBER TO BE WATER TIGHT AND VENTED

Sill = 201.30VENT Top of Foundation PIPE SEAL TO V-BOX ---500 2" HDPE FM PLASTIC PIPE UNIT 5 INV. ELEV.= 198.25 LIQUID LEVEL----BEFORE CHECK VALVE HIGH WATER ALARM EL. 197.50 -SEALED W/ BUTYL RESIN EL. 196.75

EFFLUENT PUMP # 05

SECTION VIEW SHEA

EFFLUENT PUMP SPECIFICATIONS

- PUMP TO BE MYERS ME3F 1/3 HP , OR EQUIV., RATED AT 35 GPM AT 20.6 FT. TOTAL DYNAMIC HEAD. ALARM TO BE CONNECTED TO LIGHT OR BELL WITHIN BUILDING WITH ON/OFF SWITCH ON ITS OWN CIRCUIT. PUMP IS TO BE ON ITS OWN CIRCUIT. CONTROL PANEL, JUNCTION BOX, ETC. TO BE REMOTELY MOUNTED FROM PUMP CHAMBER TO AVOID MOISTURE/ CORROSION. ALL INSTALLED AND WIRED PER MANUFACTURER'S RECOMMENDATIONS.
- 2. SYSTEM DESIGNED TO DOSE LEACH FIELD 3.3 TIMES PER DAY AT 38 GAL./DOSE.
- PUMP WILL OPERATE FOR APPROX. 1.1 MINUTES PER DOSE.
- 4. PUMP CHAMBER TO BE WATER TIGHT AND VENTED.

EFFLUENT PUMP # 09 Sill = 199.80VENT Top of Foundation - Brass Check Valve INV. OUT TO V-BOX ---500 1.5" HDPE FM PLASTIC UNIT 9 INV. ELEV.= 196.75 LIQUID LEVEL-DIA INLET BEFORE CHECK VALVE HIGH WATER ALARM EL. 196.00 -SEALED W/ BUTYL RESIN EL. 195.50 EL. 195.25

SECTION VIEW SHEA


EFFLUENT PUMP SPECIFICATIONS

- 1. PUMP TO BE MYERS ME3F 1/3 HP, OR EQUIV., RATED AT 26 GPM AT 23.7 FT. TOTAL DYNAMIC HEAD. ALARM TO BE CONNECTED TO LIGHT OR BELL WITHIN BUILDING WITH ON/OFF SWITCH ON ITS OWN CIRCUIT. PUMP IS TO BE ON ITS OWN CIRCUIT. CONTROL PANEL, JUNCTION BOX, ETC. TO BE REMOTELY MOUNTED FROM PUMP CHAMBER TO AVOID MOISTURE/ CORROSION. ALL INSTALLED AND WIRED PER MANUFACTURER'S RECOMMENDATIONS
- 2. SYSTEM DESIGNED TO DOSE LEACH FIELD 3.3 TIMES PER DAY AT 38 GAL./DOSE.
- 3. PUMP WILL OPERATE FOR APPROX. 1.5 MINUTES PER DOSE.
- 4. PUMP CHAMBER TO BE WATER TIGHT AND VENTED.

EFFLUENT PUMP #12 Sill = 200.70VENT Top of Foundation - Brass Check Valve INV. OU 198.2 500 1.5" HDPE FM PLASTIC PIPE UNIT 12 INV. ELEV.= 198.25 INV. ELEV.= 197.75 SEAL 4" DIA INLET LIQUID LEVEL---DRILL 1/4" DIA WEEP HOLE IN BOT. OF PIPE BEFORE CHECK VALVE HIGH WATER ALARM EL. 197.00 -SEALED W/ BUTYL RESIN EL. 196.50 PUMP OFF EL. 196.25 GAL. SHEA **SECTION VIEW**

EFFLUENT PUMP SPECIFICATIONS

- PUMP TO BE BARNES SE411 4/10 HP, OR EQUIV., RATED AT 26 GPM AT 14.7 FT. TOTAL DYNAMIC HEAD. ALARM TO BE CONNECTED TO LIGHT OR BELL WITHIN BUILDING WITH ON/OFF SWITCH ON ITS OWN CIRCUIT. PUMP IS TO BE ON ITS OWN CIRCUIT. CONTROL PANEL, JUNCTION BOX, ETC. TO BE REMOTELY MOUNTED FROM PUMP CHAMBER TO AVOID MOISTURE/ CORROSION. ALL INSTALLED AND WIRED PER MANUFACTURER'S RECOMMENDATIONS.
- 2. SYSTEM DESIGNED TO DOSE LEACH FIELD 3.3 TIMES PER DAY AT 38 GAL./DOSE.
- PUMP WILL OPERATE FOR APPROX. 1.5 MINUTES PER DOSE.
- PUMP CHAMBER TO BE WATER TIGHT AND VENTED

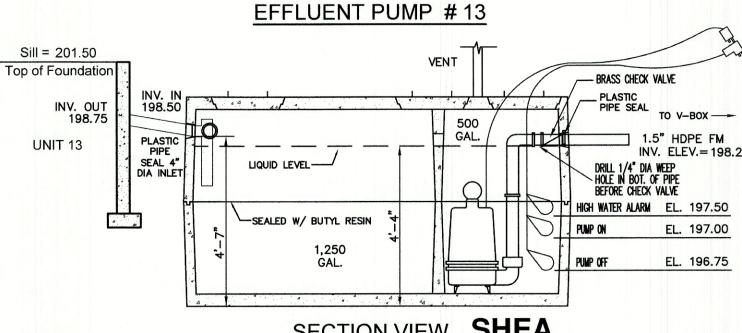

SHEA **SECTION VIEW**

EFFLUENT PUMP SPECIFICATIONS

- PUMP TO BE MYERS ME3F 1/3 HP, OR EQUIV., RATED AT 29 GPM AT 22.2 FT. TOTAL DYNAMIC HEAD. ALARM TO BE CONNECTED TO LIGHT OR BELL WITHIN BUILDING WITH ON/OFF SWITCH ON ITS OWN CIRCUIT. PUMP IS TO BE ON ITS OWN CIRCUIT. CONTROL PANEL, JUNCTION BOX, ETC. TO BE REMOTELY MOUNTED FROM PUMP CHAMBER TO AVOID MOISTURE/ CORROSION. ALL INSTALLED AND WIRED PER MANUFACTURER'S RECOMMENDATIONS.
- 2. SYSTEM DESIGNED TO DOSE LEACH FIELD 3.3 TIMES PER DAY AT 38 GAL./DOSE.
- PUMP WILL OPERATE FOR APPROX. 1.3 MINUTES PER DOSE
- 4. PUMP CHAMBER TO BE WATER TIGHT AND VENTED.

TIMOTHY & GERALDINE PALMER

706 MAIN STREET, FREMONT, NH 03044

EFFLUENT DISPOSAL DESIGN - PUMPS Plan Name: LIBERTY LANTERN ESTATES Project: MAIN STREET, FREMONT, NH

Owner of Record:

SHEET 17 OF 21 JBE PROJECT NO. 20724

DRAWING No.

BWG REVISED PER PB COMMENTS 2 12/6/21 REVISED PER TECHNICAL REVIEW **BWG** 1 11/22/21 **BWG ISSUED FOR REVIEW** 0 10/6/21

REVISION


WIRED PER MANUFACTURER'S RECOMMENDATIONS

4. PUMP CHAMBER TO BE WATER TIGHT AND VENTED.

PUMP WILL OPERATE FOR APPROX. 1.1 MINUTES PER DOSE


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GRAVEL TRAIL SECTION


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NHDOT CATCH BASIN TYPE "C" THROAT

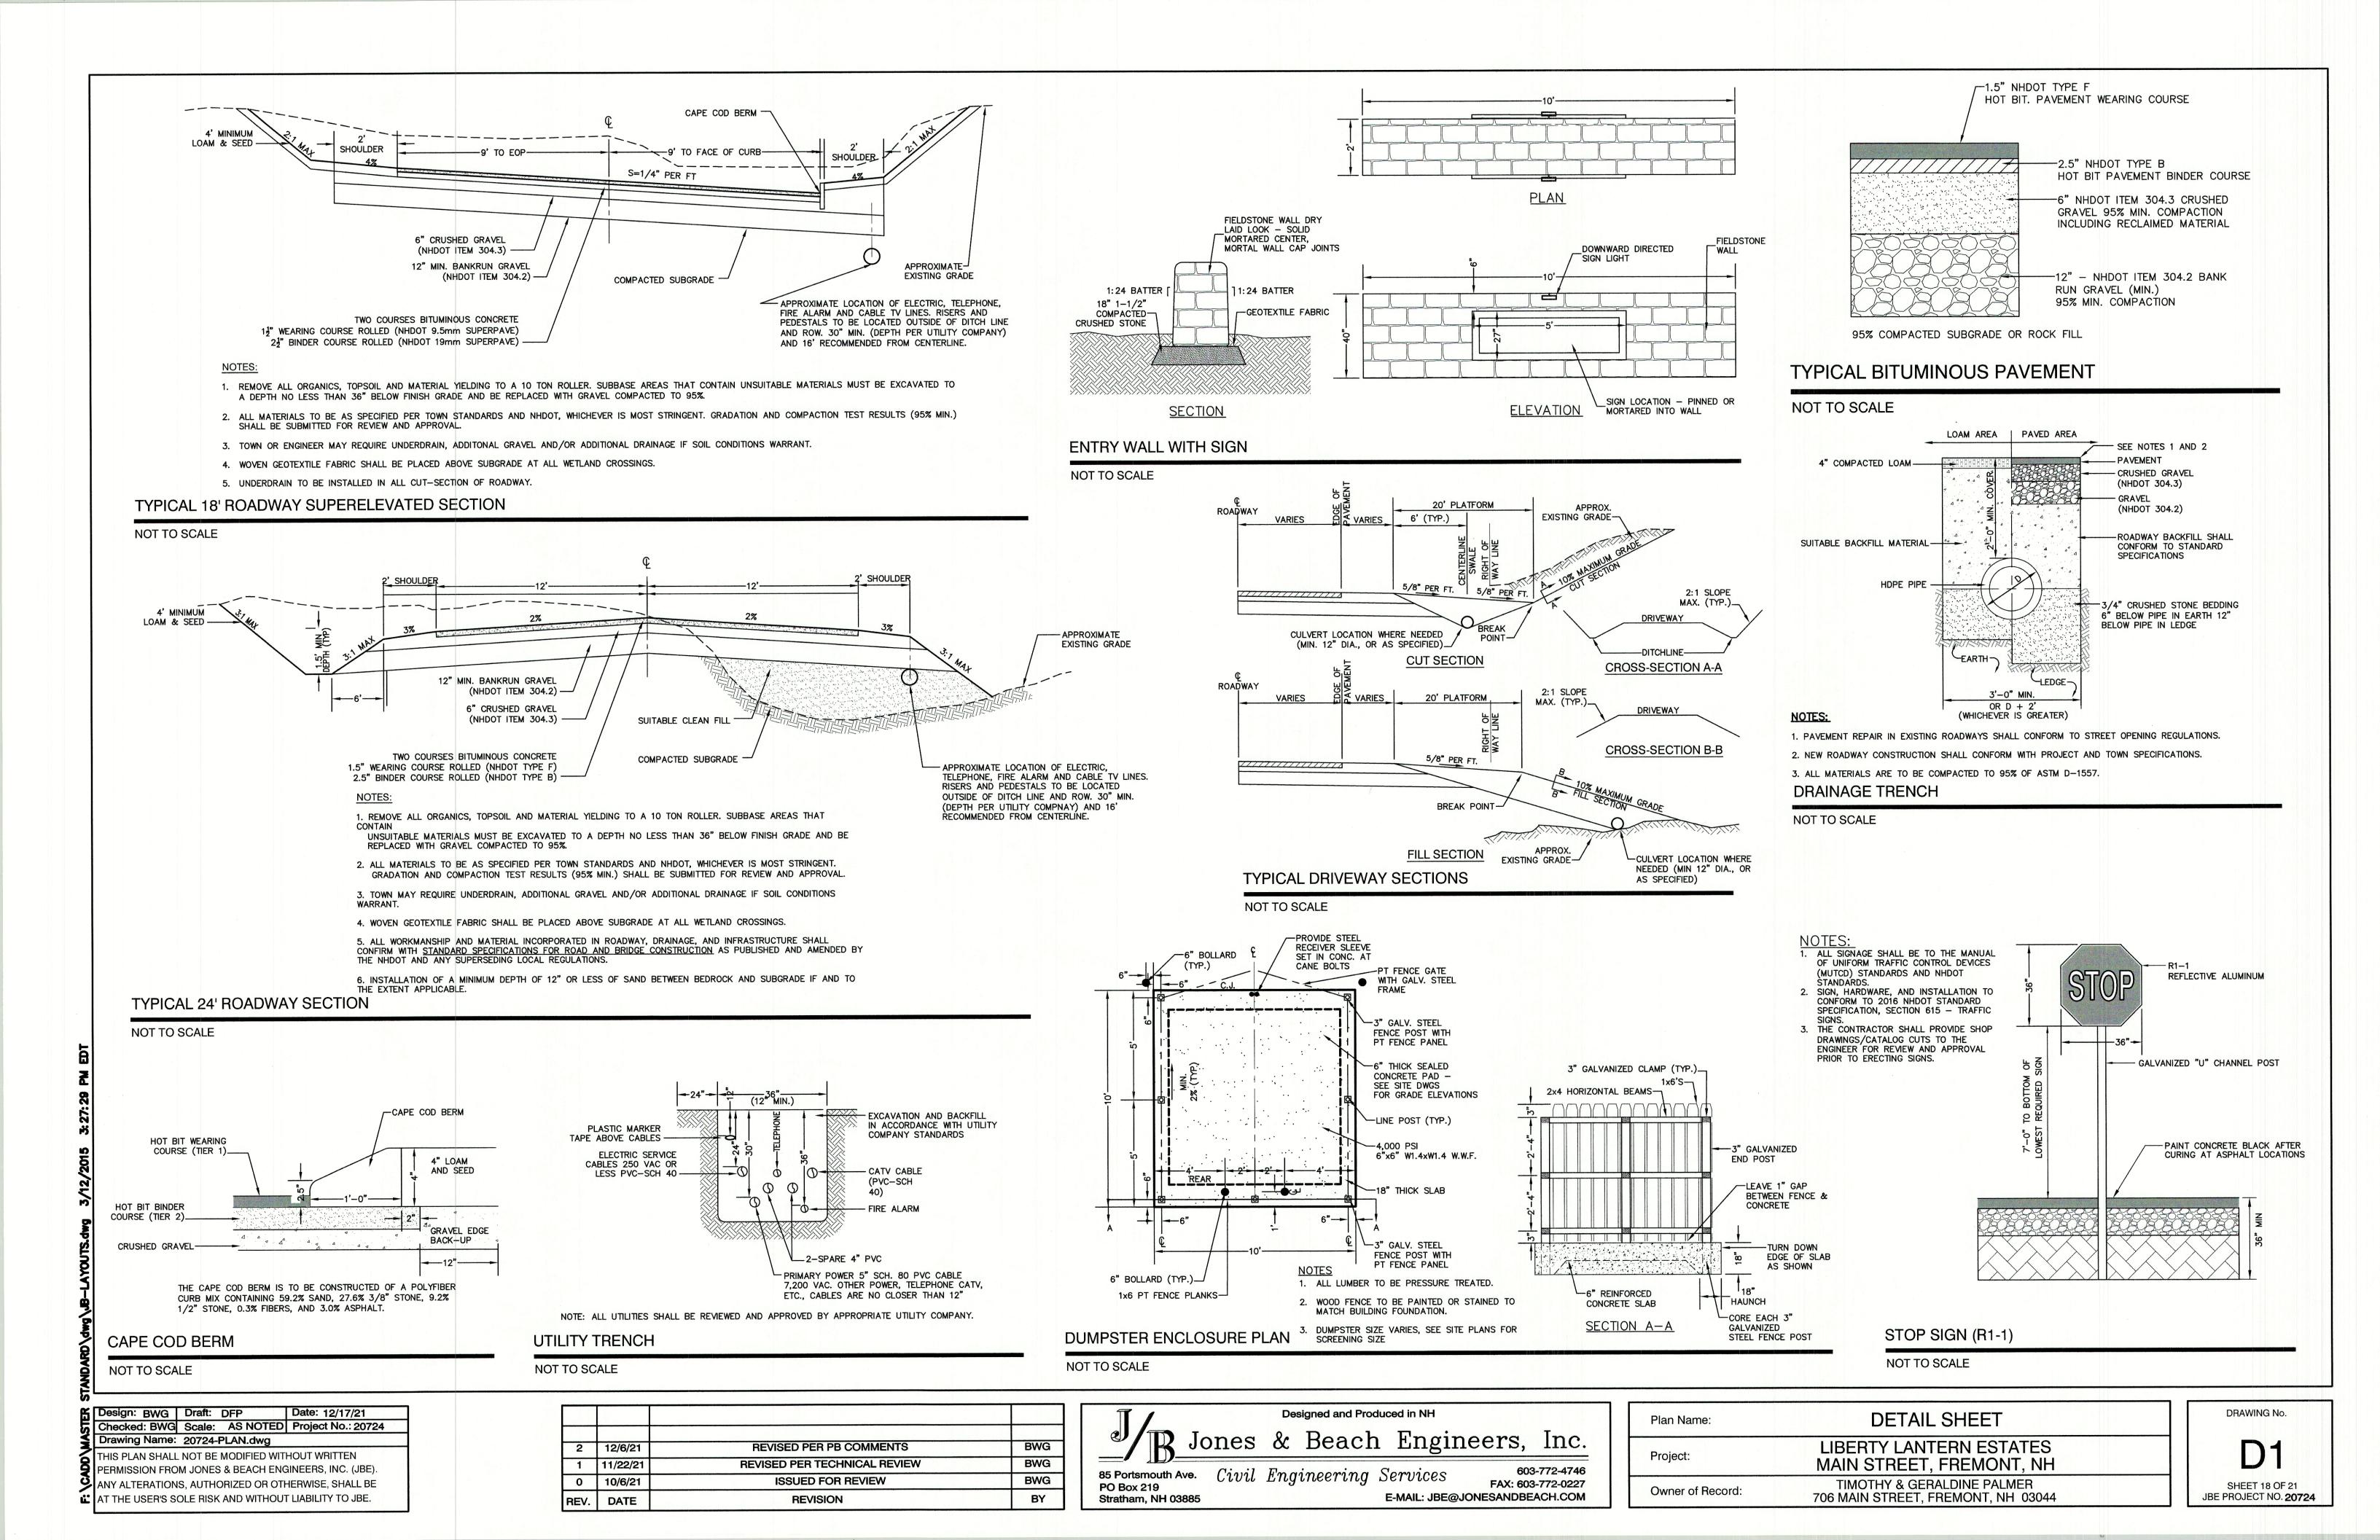
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F:\DETAILS\DRAINAGE\NHDOT BASIN TYPE C THOAT.dwg 11/12/2007 2:20:38 PM EST




EMERGENCY SPILLWAY
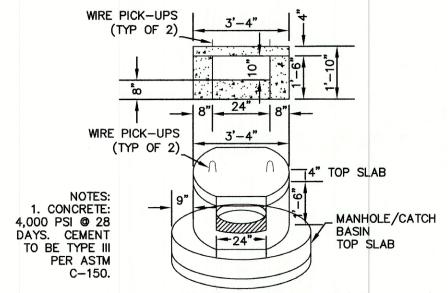
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DRIP EDGE INFILTRATION DETAIL
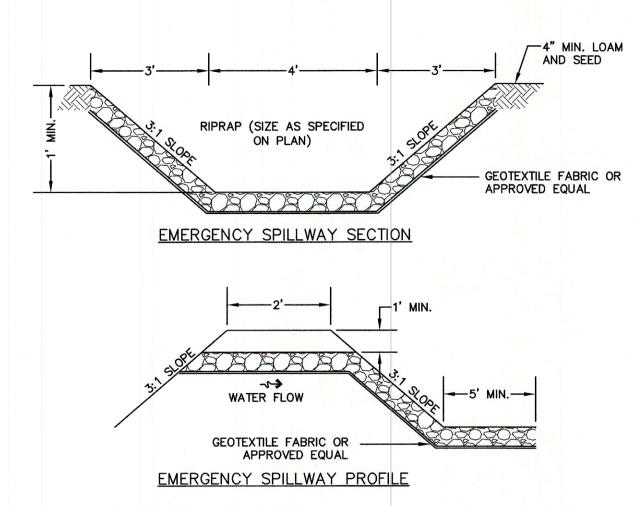
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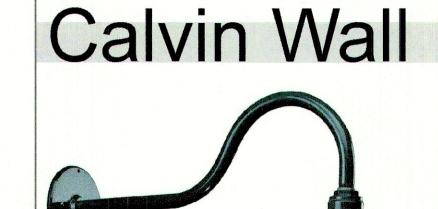


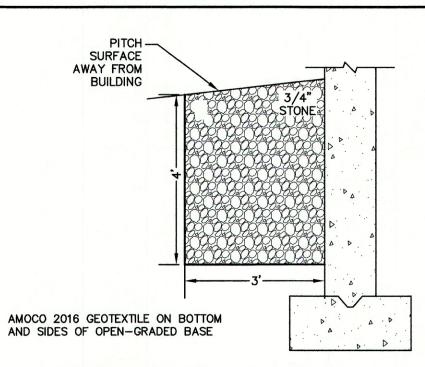1. BASE SECTION SHALL BE MONOLITHIC WITH 48" INSIDE DIAMETER. (NHDOT ITEM 304.3)

- 2. ALL SECTIONS SHALL BE DESIGNED FOR H20 LOADING.
- 3. CONCRETE SHALL BE COMPRESSIVE STRENGTH 4000 PSI, TYPE II CEMENT.
- 4. FRAMES AND GRATES SHALL BE HEAVY DUTY AND DESIGNED FOR H20 LOADING
- 5. PROVIDE "V" KNOCKOUTS FOR PIPES WITH 2" MAX. CLEARANCE TO OUTSIDE OF PIPE. MORTAR ALL PIPE CONNECTIONS SO AS TO BE WATERTIGHT.
- 6. JOINT SEALANT BETWEEN PRECAST SECTIONS SHALL BE BUTYL RUBBER.
- 7. ALL CATCH BASIN FRAMES AND GRATES SHALL BE NHDOT CATCH BASIN TYPE ALTERNATE 1 OR NEENAH R-3570 OR APPROVED EQUAL (24"x24" TYPICAL).
- 8. STANDARD CATCH BASIN FRAME AND GRATE(S) SHALL BE SET IN FULL MORTAR BED. ADJUST TO GRADE WITH CLAY BRICK AND MORTAR (2 BRICK COURSES TYPICALLY, 5 BRICK COURSES MAXIMUM, BUT NO MORE THAN 12"), OR PRECAST CONCRETE 'DONUTS'.

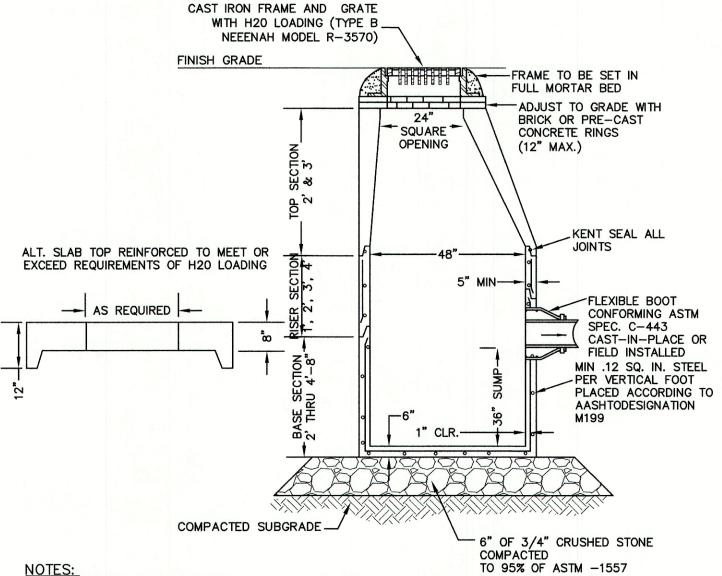CATCH BASIN

NOT TO SCALE



Features

- Provides excellent coverage and uniformity with cut-off
- Practical and aesthetic options for application and design flexibility
- Weatherproof construction to withstand the elements
- Quality components combined with the most current technology for high efficiency and reduced lighting costs

Applications

The Calvin wall-mount luminaire is ideal for illuminating areas where localized distribution is necessary, such as doorways and entrances, laneways, patios and could provide adequate night time security lighting. It lends itself to commercial, and industrial applications that could benefit from materials and maintenance cost reductions. Calvin could either augment the existing lighting, or illuminate a small to medium-sized area.

Calvin is also available as a pendant-style model.

TMSLIGHTING

ESTABLISHED 1923

High grade spun aluminum, brushed solid copper, or brushed 316L stainless steel reflector, with stainless steel mounting hardware, for indoor and outdoor applications.

Operates with Cree™ LED (19W max.), compact fluorescent (42W max.), metal halide (100W max.), or incandescent (150W max.). Specify 3000K, 3500K or 4000K CCT for LED systems. A dimmable, screw-type, 17W LED lamp is also available (PAR 38, E26 base, 120V, 4000K CCT).

(PAR 38, E26 base, 120V, 4000K CCT).

Note: LED systems are available with 120-277V supply voltage only.

LED modules do not require a socket, and are wired directly to the integral driver. Incandescent and metal halide systems, and those using the 17W LED PAR 38 lamp, use a medium base socket (E26).

Globe: clear and prismatic, elongated, glass globes are available.

Lens: the clear, flat lens provides slight diffusion, and protects any components

Note: G3 is used with 100IN, 32CF, and 15LED max.
Only prismatic globes are compatible with LED systems.

Option

located in the reflector.

Wire Guard: a steel, chrome-plated wire guard is available for lamp protection against light projectiles, wildlife, and serves as a vandal deterrent.

Ballasts are efficient with a high power factor greater than 90%, and quiet with an "A"


Globes are not available with the 17W LED PAR 38 lamps.

sound rating.

The LED source is controlled by an advanced electronic driver that delivers consistent power.

Ballast and LED drivers are electronic, and available for integral and remote

mounting, indoor or outdoor.

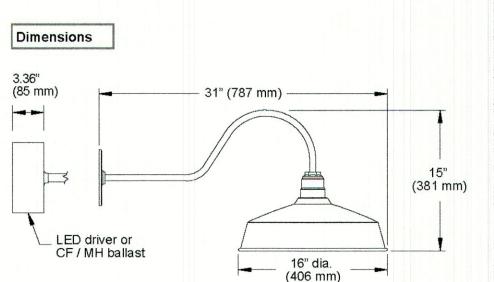

c (us c (€ IP23

WALL MOUNTED LUMINAIRE DETAIL

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Jones & Beach Engineers, Inc.

85 Portsmouth Ave. Civil Engineering Services
PO Box 219

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Engineers, Inc.

603-772-4746
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Stratham, NH 03885


Plan Name:	DETAIL SHEET	
Project:	LIBERTY LANTERN ESTATES MAIN STREET, FREMONT, NH	
Owner of Record:	TIMOTHY & GERALDINE PALMER 706 MAIN STREET, FREMONT, NH 03044	


DRAWING No.

D2

SHEET 19 OF 21


JBE PROJECT NO. 20724

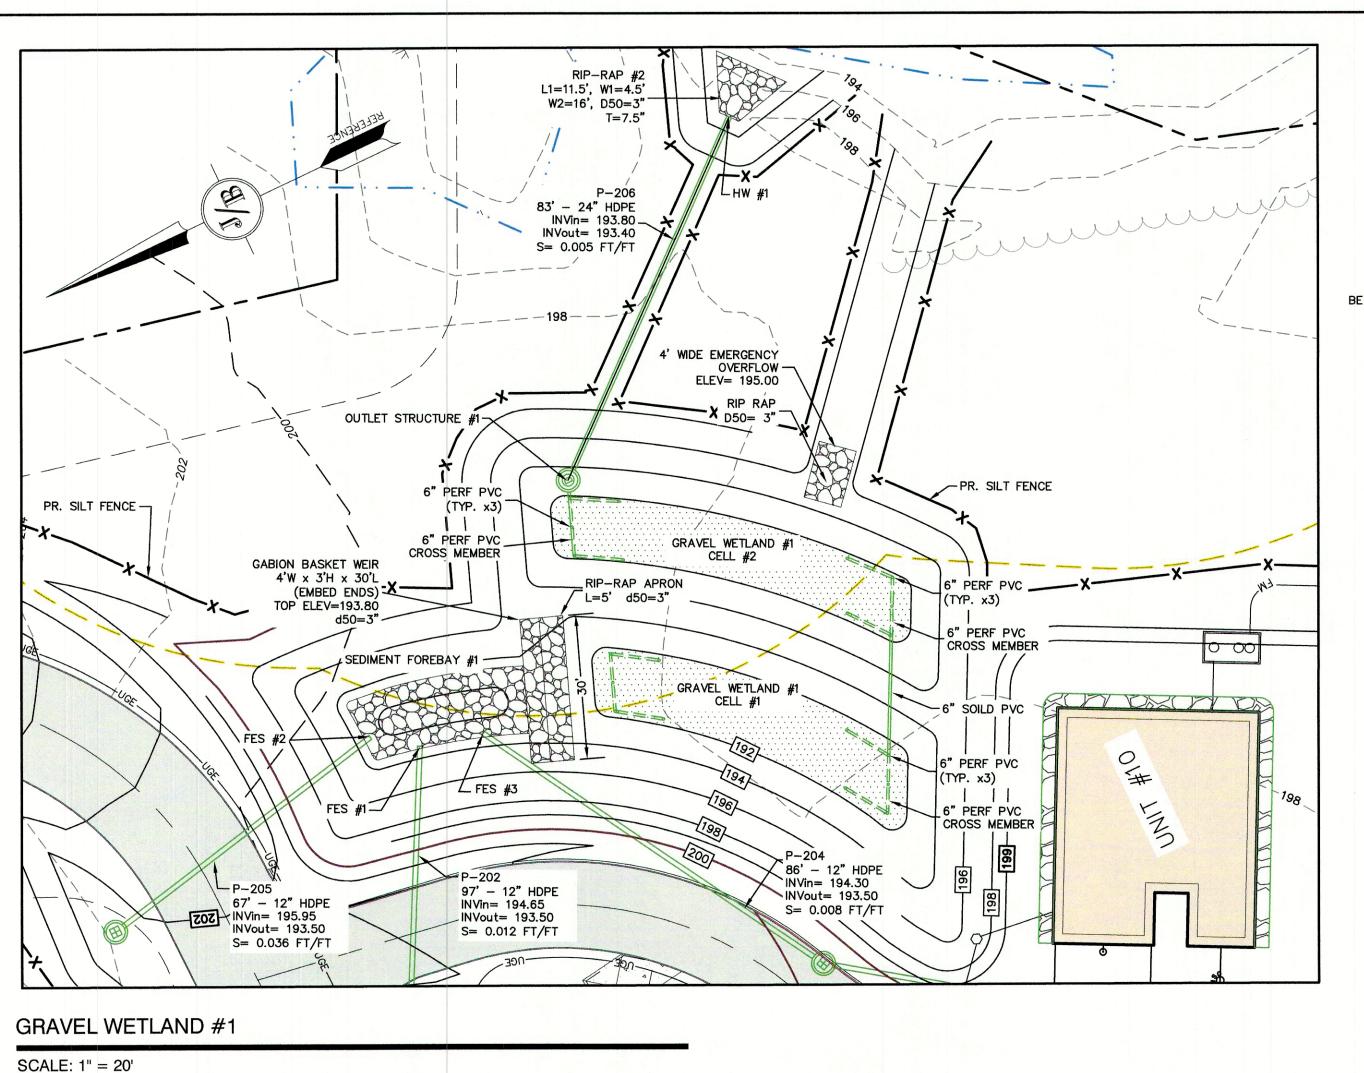

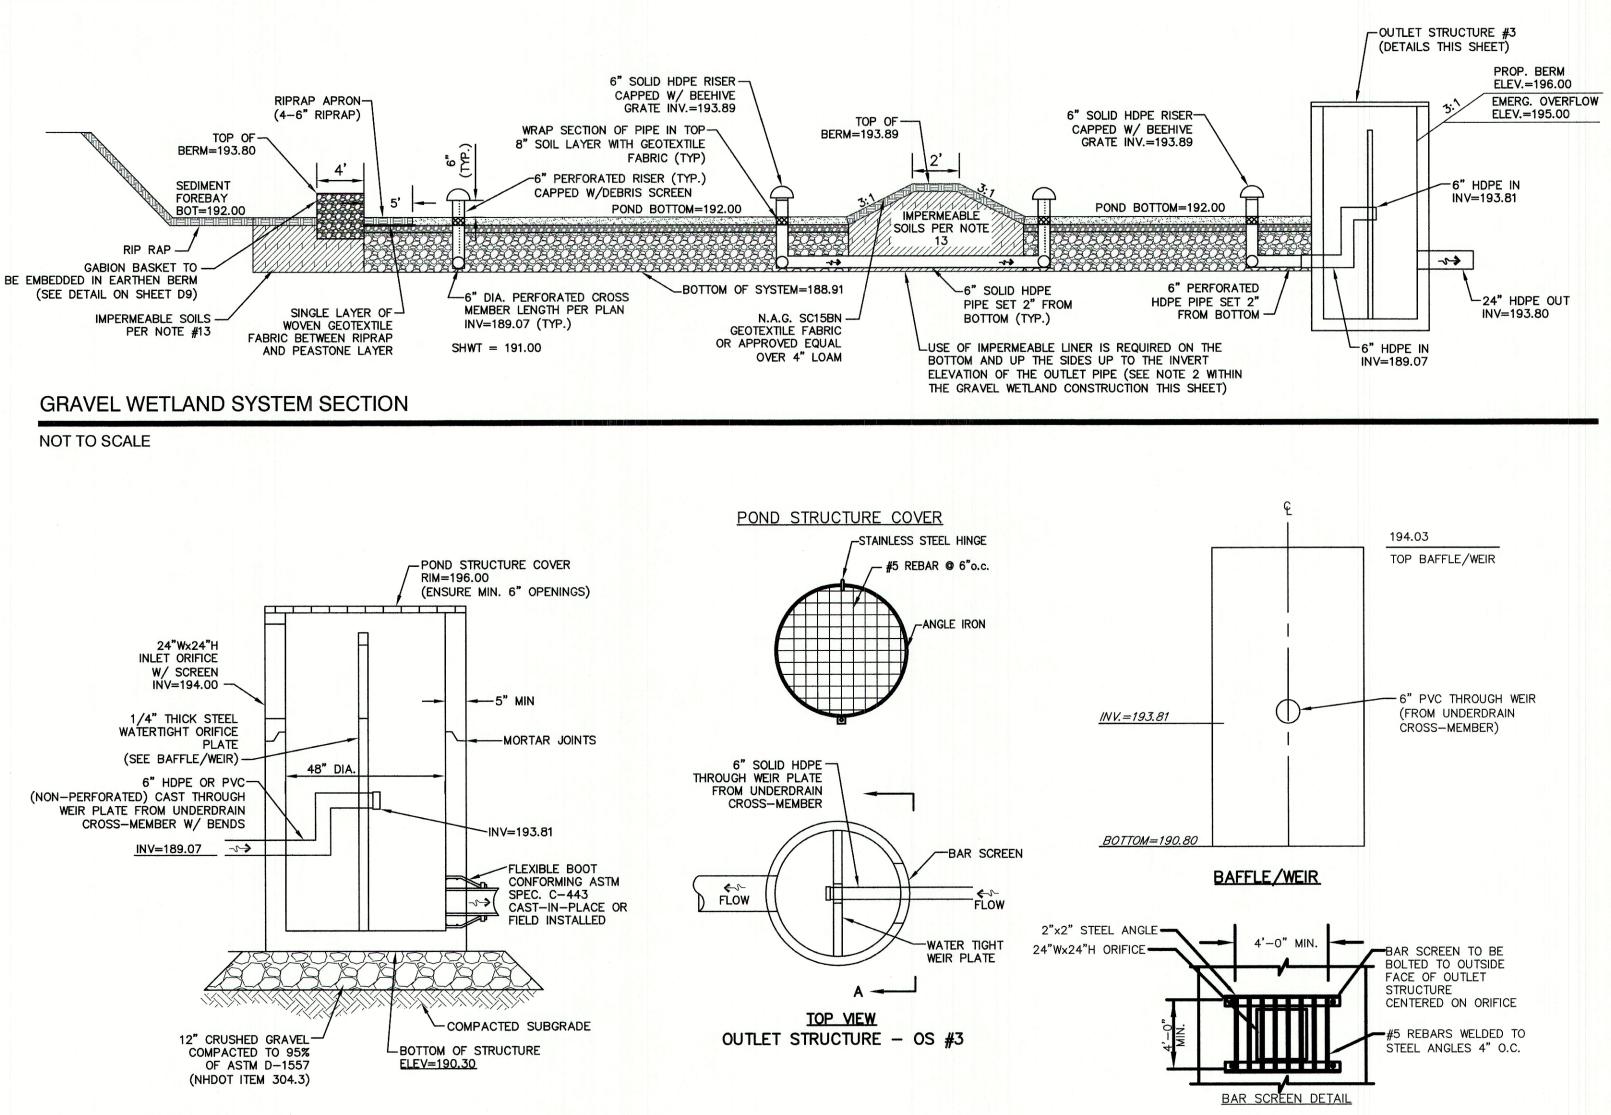

OUTLET STRUCTURE #1 (OS #1)

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Plan Name:	DETAIL SHEET	
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DRAWING No. SHEET 20 OF 21 JBE PROJECT NO. 20724

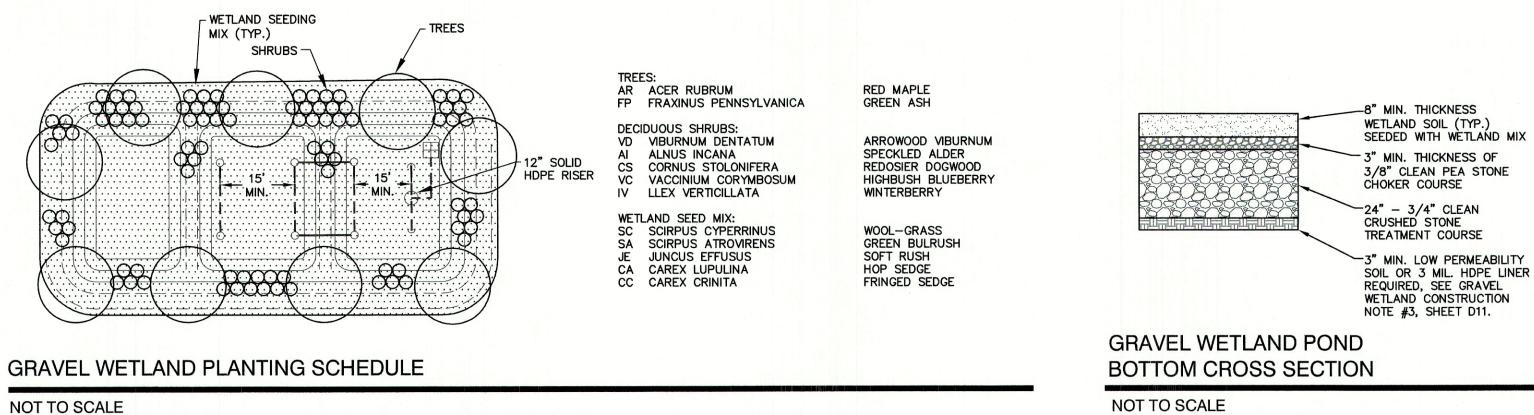WETLAND SOIL SPEC:

(0.1-0.01 FT/DAY)

1. LOW HYDRAULIC CONDUCTIVITY

2. A BLEND OF LOAM, SAND, AND

3. AVOID A FINAL SOIL MIX WITH

DRYING AND CRACKING;

SOME FINE SOILS WITH MORE THAN 15% ORGANIC MATTER

CLAY CONTENT IN EXCESS OF

ALLOWING THE MIGRATION OF

FINES INTO THE SUBSURFACE

15% SO AS NOT TO ENCOURAGE


TEMPORARY EROSION CONTROL NOTES

. THE SMALLEST PRACTICAL AREA OF LAND SHALL BE EXPOSED AT ANY ONE TIME. AT NO TIME SHALL AN AREA IN EXCESS OF 5 ACRES BE EXPOSED AT ANY ONE TIME BEFORE DISTURBED AREAS ARE STABILIZED.

- EROSION, SEDIMENT AND DETENTION MEASURES SHALL BE INSTALLED AS SHOWN ON THE PLANS AND AT LOCATIONS AS REQUIRED, DIRECTED BY THE ENGINEER.
- ALL DISTURBED AREAS (INCLUDING POND AREAS BELOW THE PROPOSED WATERLINE) SHALL BE RETURNED TO PROPOSED GRADES AND ELEVATIONS. DISTURBED AREAS SHALL BE LOAMED WITH A MINIMUM OF 6" OF SCREENED ORGANIC LOAM AND SEEDED WITH SEED MIXTURE 'C' AT A RATE NOT LESS THAN 1.10 POUNDS OF SEED PER 1,000 S.F. OF AREA (48 LBS. / ACRE).
- SILT FENCES AND OTHER BARRIERS SHALL BE INSPECTED EVERY SEVEN CALENDAR DAYS AND WITHIN 24 HOURS OF A RAINFALL OF 0.5" OR GREATER. ALL DAMAGED AREAS SHALL BE REPAIRED, AND SEDIMENT DEPOSITS SHALL PERIODICALLY BE REMOVED
- AFTER ALL DISTURBED AREAS HAVE BEEN STABILIZED, THE TEMPORARY EROSION CONTROL MEASURES SHALL BE REMOVED AND THE AREA DISTURBED BY THE REMOVAL SMOOTHED AND RE-VEGETATED.
- AREAS MUST BE SEEDED AND MULCHED OR OTHERWISE PERMANENTLY STABILIZED WITHIN 3 DAYS OF FINAL GRADING, OR TEMPORARILY STABILIZED WITHIN 14 DAYS OF THE INITIAL DISTURBANCE OF SOIL, ALL AREAS SHALL BE STABILIZED WITHIN 45 DAYS OF INITIAL DISTURBANCE.
- ALL PROPOSED VEGETATED AREAS THAT DO NOT EXHIBIT A MINIMUM OF 85 PERCENT VEGETATIVE GROWTH BY OCTOBER 15, OR WHICH ARE DISTURBED AFTER OCTOBER 15, SHALL BE STABILIZED BY SEEDING AND INSTALLING NORTH AMERICAN GREEN S75 EROSION CONTROL BLANKETS (OR AN EQUIVALENT APPROVED IN WRITING BY THE ENGINEER) ON SLOPES GREATER THAN 3:1, AND SEEDING AND PLACING 3 TO 4 TONS OF MULCH PER ACRE, SECURED WITH ANCHORED NETTING, ELSEWHERE. THE INSTALLATION OF EROSION CONTROL BLANKETS OR MULCH AND NETTING SHALL NOT OCCUR OVER ACCUMULATED SNOW OR ON FROZEN GROUND AND SHALL BE COMPLETED IN ADVANCE OF THAW OR SPRING MELT EVENTS.
- ALL DITCHES OR SWALES WHICH DO NOT EXHIBIT A MINIMUM OF 85 PERCENT VEGETATIVE GROWTH BY OCTOBER 15, OR WHICH ARE DISTURBED AFTER OCTOBER 15, SHALL BE STABILIZED TEMPORARILY WITH STONE OR EROSION CONTROL BLANKETS APPROPRIATE FOR THE DESIGN FLOW CONDITIONS.
- AFTER OCTOBER 15th, INCOMPLETE ROAD OR PARKING SURFACES, WHERE WORK HAS STOPPED FOR THE WINTER SEASON, SHALL BE PROTECTED WITH A MINIMUM OF 3" OF CRUSHED GRAVEL PER NHDOT ITEM 304.3.
- 10. AN AREA SHALL BE CONSIDERED STABLE IF ONE OF THE FOLLOWING HAS OCCURRED:
 - a. BASE COURSE GRAVELS HAVE BEEN INSTALLED IN AREAS TO BE PAVED;
 - b. A MINIMUM OF 85% VEGETATED GROWTH HAS BEEN ESTABLISHED;

d. EROSION CONTROL BLANKETS HAVE BEEN PROPERLY INSTALLED.

- c. A MINIMUM OF 3" OF NON-EROSIVE MATERIAL SUCH STONE OR RIPRAP HAS BEEN INSTALLED; OR
- FUGITIVE DUST CONTROL IS REQUIRED TO BE CONTROLLED IN ACCORDANCE WITH ENV-A 1000, AND THE PROJECT IS TO MEET THE REQUIREMENTS AND INTENT OF RSA 430:53 AND AGR 3800 RELATIVE TO INVASIVE SPECIES.
- 12. PRIOR TO BEGINNING CONSTRUCTION, THE CONTRACTOR'S NAME, ADDRESS, AND PHONE NUMBER SHALL BE SUBMITTED TO DES VIA EMAIL (SEE BELOW).
- 13. PRIOR TO CONSTRUCTION, A PHASING PLAN THAT DELINEATES EACH PHASE OF THE PROJECT SHALL BE SUBMITTED. ALL TEMPORARY SEDIMENT BASINS THAT WILL BE NEEDED FOR DEWATERING WORK AREAS SHALL BE LOCATED AND IDENTIFIED ON THIS
- IN ORDER TO ENSURE THE STABILITY OF THE SITE AND EFFECTIVE IMPLEMENTATION OF THE SEDIMENT AND EROSION CONTROL MEASURES SPECIFIED IN THE PLANS FOR THE DURATION OF CONSTRUCTION, THE CONTRACTOR SHALL BE IN STRICT COMPLIANCE
- WITH THE FOLLOWING INSPECTION AND MAINTENANCE REQUIREMENTS IN ADDITION TO THOSE CALLED FOR IN THE SWPPP: a. A CERTIFIED PROFESSIONAL IN EROSION AND SEDIMENT CONTROL OR A PROFESSIONAL ENGINEER LICENSED IN THE STATE OF NEW HAMPSHIRE ("MONITOR") SHALL BE EMPLOYED TO INSPECT THE SITE FROM THE START OF ALTERATION OF TERRAIN ACTIVITIES UNTIL THE SITE IS STABLE
- b. DURING THIS PERIOD, THE MONITOR SHALL INSPECT THE SUBJECT SITE AT LEAST ONCE A WEEK, AND IF POSSIBLE, DURING ANY 1/2 INCH OR GREATER RAIN EVENT (I.E. 1/2 INCH OF PRECIPITATION OR MORE WITHIN A 24 HOUR PERIOD). IF UNABLE TO BE PRESENT DURING SUCH A STORM, THE MONITOR SHALL INSPECT THE SITE WITHIN 24 HOURS OF THIS
- c. THE MONITOR SHALL PROVIDE TECHNICAL ASSISTANCE AND RECOMMENDATIONS TO THE CONTRACTOR ON THE APPROPRIATE BEST MANAGEMENT PRACTICES FOR EROSION AND SEDIMENT CONTROLS REQUIRED TO MEET THE REQUIREMENTS OF RSA 485 A:17 AND ALL APPLICABLE DES PERMIT CONDITIONS.

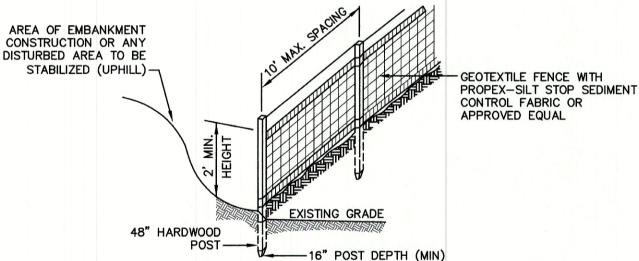

CONSTRUCTION SPECIFICATIONS:

SILT FENCE

NOT TO SCALE

Design: BWG | Draft: DFP

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WOVEN FABRIC FENCE TO BE FASTENED SECURELY TO FENCE POSTS WITH WIRE TIES OR STAPLES. FILTER CLOTH SHALL BE FASTENED TO WOVEN WIRE EVERY 24" AT TOP, MID AND BOTTOM AND EMBEDDED IN THE GROUND A MINIMUM OF 8" AND THEN COVERED WITH SOIL.

THE FENCE POSTS SHALL BE A MINIMUM OF 48" LONG, SPACED A MAXIMUM 10' APART, AND DRIVEN A MINIMUM OF 16" INTO THE GROUND.

WHEN TWO SECTIONS OF FILTER CLOTH ADJOIN EACH OTHER, THE ENDS OF THE FABRIC SHALL BE

OVERLAPPED 6", FOLDED AND STAPLED TO PREVENT SEDIMENT FROM BY-PASSING. MAINTENANCE SHALL BE PERFORMED AS NEEDED AND SEDIMENT REMOVED AND PROPERLY DISPOSED OF

Date: 12/17/21

- 5. PLACE THE ENDS OF THE SILT FENCE UP CONTOUR TO PROVIDE FOR SEDIMENT STORAGE.
- SILT FENCE SHALL REMAIN IN PLACE FOR 24 MONTHS.

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WHEN IT IS 6" DEEP OR VISIBLE 'BULGES' DEVELOP IN THE SILT FENCE.

-MAXIMUM RECOMMENDED UNCONTROLLED SLOPE LENGTH - DISTURBED AREA (UPHILL) -CONTOUR LINES___ _____ 600' RECOMMENDED MAXIMUM FENCING IS TO RUN WITH THE CONTOURS ACROSS A SLOPE -FLARE ENDS UPHILL TO PROVIDE TRAPPING CAPABILITY AND SEDIMENT STORAGE AREA

7. SILT FENCES SHALL BE REMOVED WHEN NO LONGER NEEDED AND THE SEDIMENT COLLECTED SHALL BE DISPOSED AS DIRECTED BY THE ENGINEER. THE AREA DISTURBED BY THE REMOVAL SHALL BE SMOOTHED AND REVEGETATED.

MAINTENANCE:

- 1. SILT FENCES SHALL BE INSPECTED IMMEDIATELY AFTER EACH RAINFALL AND AT LEAST DAILY DURING PROLONGED RAINFALL. ANY REPAIRS THAT ARE REQUIRED SHALL BE DONE IMMEDIATELY.
- 2. IF THE FABRIC ON A SILT FENCE SHOULD DECOMPOSE OR BECOME INEFFECTIVE DURING THE EXPECTED LIFE OF THE FENCE, THE FABRIC SHALL BE REPLACED PROMPTLY.
- 3. SEDIMENT DEPOSITS SHOULD BE INSPECTED AFTER EVERY STORM EVENT. THE DEPOSITS SHOULD BE REMOVED WHEN THEY REACH APPROXIMATELY ONE HALF THE HEIGHT OF THE BARRIER.
- 4. SEDIMENT DEPOSITS THAT ARE REMOVED, OR LEFT IN PLACE AFTER THE FABRIC HAS BEEN REMOVED,

SHALL BE GRADED TO CONFORM WITH THE EXISTING TOPOGRAPHY AND VEGETATED.

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SEEDING SPECIFICATIONS

- 1. GRADING AND SHAPING A. SLOPES SHALL NOT BE STEEPER THAN 2:1 WITHOUT APPROPRIATE EROSION CONTROL MEASURES AS
- SPECIFIED ON THE PLANS (3:1 SLOPES OR FLATTER ARE PREFERRED) B. WHERE MOWING WILL BE DONE, 3:1 SLOPES OR FLATTER ARE RECOMMENDED.

2. SEEDBED PREPARATION

A. SURFACE AND SEEPAGE WATER SHOULD BE DRAINED OR DIVERTED FROM THE SITE TO PREVENT DROWNING OR WINTER KILLING OF THE PLANTS.

B. STONES LARGER THAN 4 INCHES AND TRASH SHOULD BE REMOVED BECAUSE THEY INTERFERE WITH SEEDING AND FUTURE MAINTENANCE OF THE AREA. WHERE FEASIBLE, THE SOIL SHOULD BE TILLED TO A DEPTH OF ABOUT 4 INCHES TO PREPARE A SEEDBED AND FERTILIZER AND LIME MIXED INTO THE SOIL. THE SEEDBED SHOULD BE LEFT IN A REASONABLY FIRM AND SMOOTH CONDITION. THE LAST TILLAGE OPERATION SHOULD BE PERFORMED ACROSS THE SLOPE WHEREVER PRACTICAL.

3. ESTABLISHING A STAND

A. LIME AND FERTILIZER SHOULD BE APPLIED PRIOR TO OR AT THE TIME OF SEEDING AND INCORPORATED INTO THE SOIL. TYPES AND AMOUNTS OF LIME AND FERTILIZER SHOULD BE BASED ON AN EVALUATION OF SOIL TESTS. WHEN A SOIL TEST IS NOT AVAILABLE, THE FOLLOWING MINIMUM AMOUNTS SHOULD BE APPLIED:

AGRICULTURAL LIMESTONE, 2 TONS PER ACRE OR 100 LBS. PER 1,000 SQ.FT. NITROGEN(N), 50 LBS. PER ACRE OR 1.1 LBS. PER 1,000 SQ.FT.

PHOSPHATE(P205), 100 LBS. PER ACRE OR 2.2 LBS. PER 1,000 SQ.FT. POTASH(K20), 100 LBS. PER ACRE OR 2.2 LBS. PER 1,000 SQ.FT. (NOTE: THIS IS THE EQUIVALENT OF 500 LBS. PER ACRE OF 10-20-20 FERTILIZER OR 1,000 LBS. PER

ACRE OF 5-10-10.) SEED SHOULD BE SPREAD UNIFORMLY BY THE METHOD MOST APPROPRIATE FOR THE SITE. METHODS INCLUDE BROADCASTING, DRILLING AND HYDROSEEDING. WHERE BROADCASTING IS USED, COVER SEED WITH

- .25 INCH OF SOIL OR LESS, BY CULTIPACKING OR RAKING. C. REFER TO THE 'SEEDING GUIDE' AND 'SEEDING RATES' TABLES ON THIS SHEET FOR APPROPRIATE SEED MIXTURES AND RATES OF SEEDING. ALL LEGUMES (CROWNVETCH, BIRDSFOOT, TREFOIL AND FLATPEA)
- MUST BE INOCULATED WITH THEIR SPECIFIC INOCULANT PRIOR TO THEIR INTRODUCTION TO THE SITE. D. WHEN SEEDED AREAS ARE MULCHED, PLANTINGS MAY BE MADE FROM EARLY SPRING TO EARLY OCTOBER. WHEN SEEDED AREAS ARE NOT MULCHED, PLANTINGS SHOULD BE MADE FROM EARLY SPRING TO MAY 20th OR FROM AUGUST 10th TO SEPTEMBER 1st.

A. HAY, STRAW, OR OTHER MULCH, WHEN NEEDED, SHOULD BE APPLIED IMMEDIATELY AFTER SEEDING. B. MULCH WILL BE HELD IN PLACE USING APPROPRIATE TECHNIQUES FROM THE BEST MANAGEMENT PRACTICE FOR MULCHING. HAY OR STRAW MULCH SHALL BE PLACED AT A RATE OF 90 LBS PER 1000 S.F.

5. MAINTENANCE TO ESTABLISH A STAND

- A. PLANTED AREAS SHOULD BE PROTECTED FROM DAMAGE BY FIRE, GRAZING, TRAFFIC, AND DENSE WEED
- B. FERTILIZATION NEEDS SHOULD BE DETERMINED BY ONSITE INSPECTIONS. SUPPLEMENTAL FERTILIZER IS USUALLY THE KEY TO FULLY COMPLETE THE ESTABLISHMENT OF THE STAND BECAUSE MOST PERENNIALS TAKE 2 TO 3 YEARS TO BECOME FULLY ESTABLISHED.
- C. IN WATERWAYS, CHANNELS, OR SWALES WHERE UNIFORM FLOW CONDITIONS ARE ANTICIPATED, ANNUAL MOWING MAY BE NECESSARY TO CONTROL GROWTH OF WOODY VEGETATION.

USE	SEEDING MIXTURE 1/	DROUGHTY	WELL DRAINED	MODERATELY WELL DRAINED	POORLY DRAINED
STEEP CUTS AND FILLS, BORROW AND DISPOSAL AREAS	A B C	FAIR POOR POOR	GOOD GOOD GOOD	GOOD FAIR EXCELLENT	FAIR FAIR GOOD
	D	FAIR	EXCELLENT	EXCELLENT	POOR
WATERWAYS, EMERGENC' SPILLWAYS, AND OTHER CHANNELS WITH FLOWING WATER.	Y A C	GOOD GOOD	GOOD EXCELLENT	GOOD EXCELLENT	FAIR FAIR
LIGHTLY USED PARKING LOTS, ODD AREAS, UNUSED LANDS, AND LOW INTENSITY USE RECREATION SITES.	A B C	GOOD GOOD GOOD	GOOD GOOD EXCELLENT	GOOD FAIR EXCELLENT	FAIR POOR FAIR
PLAY AREAS AND ATHLETIC FIELDS. (TOPSOIL IS ESSENTIAL FOR GOOD TURF.)	E F	FAIR FAIR	EXCELLENT EXCELLENT	EXCELLENT EXCELLENT	<u>2/</u> 2/

GRAVEL PIT, SEE NH-PM-24 IN APPENDIX FOR RECOMMENDATION REGARDING RECLAMATION OF SAND


REFER TO SEEDING MIXTURES AND RATES IN TABLE BELOW. 27 POORLY DRAINED SOILS ARE NOT DESIRABLE FOR USE AS PLAYING AREA AND ATHLETIC FIELDS.

NOTE: TEMPORARY SEED MIX FOR STABILIZATION OF TURF SHALL BE WINTER RYE OR OATS AT A RATE OF 2.5 LBS. PER 1000 S.F. AND SHALL BE PLACED PRIOR TO OCTOBER 15th, IF PERMANENT SEEDING NOT

SEEDING GUIDE

POUNDS	POUNDS PER
PER ACRE	1.000 Sq. Ft
20	0.45
20	0.45
2	0.05
42	0.95
15	0.35
10	0.25
15	0.35
30	0.75
40 OR 55	0.95 OR 1.35
20	0.45
20	0.45
<u>8</u>	<u>0.20</u>
48	1.10
20	0.45
30	0.75
50	1.20
50	1.15
50	1.15
100	2.30
150	3.60
-	20 2 42 15 10 15 30 40 OR 55 20 20 8 48 20 30 50 50 100

SEEDING RATES

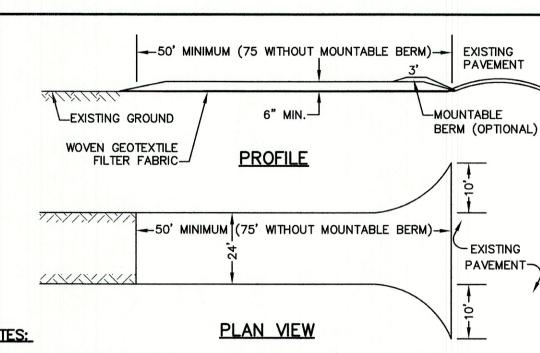

- 1. STONE FOR STABILIZED CONSTRUCTION ENTRANCE SHALL BE 3 INCH STONE, RECLAIMED STONE, OR RECYCLED CONCRETE EQUIVALENT.
- 2. THE LENGTH OF THE STABILIZED ENTRANCE SHALL NOT BE LESS THAN 50 FEET, 75' WITHOUT A MOUNTABLE BERM, AND EXCEPT FOR A SINGLE RESIDENTIAL LOT WHERE A 30 FOOT MINIMUM LENGTH
- WOULD APPLY. 3. THICKNESS OF THE STONE FOR THE STABILIZED ENTRANCE SHALL NOT BE LESS THAN 6 INCHES.
- 4. THE WIDTH OF THE ENTRANCE SHALL NOT BE LESS THAN THE FULL WIDTH OF THE ENTRANCE WHERE
- INGRESS OR EGRESS OCCURS, OR 10 FEET, WHICHEVER IS GREATER. 5. GEOTEXTILE FILTER FABRIC SHALL BE PLACED OVER THE ENTIRE AREA PRIOR TO PLACING THE STONE.
- FILTER FABRIC IS NOT REQUIRED FOR A SINGLE FAMILY RESIDENTIAL LOT. 6. ALL SURFACE WATER THAT IS FLOWING TO OR DIVERTED TOWARD THE CONSTRUCTION ENTRANCE SHALL B PIPED BENEATH THE ENTRANCE. IF PIPING IS IMPRACTICAL, A STONE BERM WITH 5:1 SLOPES THAT CAN BE
- CROSSED BY VEHICLES MAY BE SUBSTITUTED FOR THE PIPE. 7. THE ENTRANCE SHALL BE MAINTAINED IN A CONDITION THAT WILL PREVENT TRACKING OR FLOWING OF SEDIMENT ONTO THE PUBLIC RIGHT-OF-WAY. THIS MAY REQUIRE PERIODIC TOP DRESSING WITH ADDITIONAL STONE AS CONDITIONS DEMAND AND REPAIR AND/OR CLEAN OUT OF ANY MEASURES USED TO TRAP SEDIMENT. ALL SEDIMENT SPILLED, WASHED, OR TRACKED ONTO THE PUBLIC RIGHT-OF-WAY MUST BE

STABILIZED CONSTRUCTION ENTRANCE

NOT TO SCALE

REMOVED PROMPTLY.

CONSTRUCTION SEQUENCE

- PRIOR TO THE START OF ANY ACTIVITY, IT IS THE RESPONSIBILITY OF THE SITE'S SITE DEVELOPER (OR OWNER) TO FILE A NOTICE OF INTENT (NOI) FORM WITH THE ENVIRONMENTAL PROTECTION AGENCY (EPA) IN ORDER TO GAIN COVERAGE UNDER THE NPDES GENERAL PERMIT FOR STORM WATER DISCHARGES FROM CONSTRUCTION ACTIVITIES. A PRE CONSTRUCTION MEETING IS TO BE HELD WITH ALL DEPARTMENT HEADS PRIOR TO THE START OF CONSTRUCTION.
- WETLAND BOUNDARIES ARE TO BE CLEARLY MARKED PRIOR TO THE START OF CONSTRUCTION. AT LEAST A TEMPORARY CULVERT OR ROADBED TO BE IN PLACE PRIOR TO THE START OF CONSTRUCTION.
- CUT AND REMOVE TREES IN CONSTRUCTION AREA AS REQUIRED OR DIRECTED.
- INSTALL SILT FENCING, HAY BALES AND CONSTRUCTION ENTRANCES PRIOR TO THE START OF CONSTRUCTION. THESE ARE TO BE MAINTAINED UNTIL THE FINAL PAVEMENT SURFACING AND LANDSCAPING AREAS ARE ESTABLISHED.
- CLEAR, CUT, GRUB AND DISPOSE OF DEBRIS IN APPROVED FACILITIES. THIS INCLUDES ANY REQUIRED DEMOLITION OF EXISTING STRUCTURES, UTILITIES, ETC.
- 6. CONSTRUCT AND/OR INSTALL TEMPORARY OR PERMANENT SEDIMENT AND/OR DETENTION BASIN(S) AS REQUIRED. THESE FACILITIES SHALL BE INSTALLED AND STABILIZED PRIOR TO DIRECTING RUN-OFF TO THEM.
- STRIP LOAM AND PAVEMENT, OR RECLAIM EXISTING PAVEMENT WITHIN LIMITS OF WORK PER THE RECOMMENDATIONS OF THE PROJECT ENGINEER AND STOCKPILE EXCESS MATERIAL. STABILIZE STOCKPILE AS NECESSARY.
- 8. PERFORM PRELIMINARY SITE GRADING IN ACCORDANCE WITH THE PLANS.
- 9. PREPARE BUILDING PAD(S) TO ENABLE BUILDING CONSTRUCTION TO BEGIN.
- 10. INSTALL THE DRAINAGE SYSTEMS FIRST, THEN ANY OTHER UTILITIES IN ACCORDANCE WITH THE PLAN AND DETAILS. ANY CONFLICTS BETWEEN UTILITIES ARE TO BE RESOLVED WITH THE INVOLVEMENT AND APPROVAL OF THE ENGINEER.
- 11. ALL SWALES AND DRAINAGE STRUCTURES ARE TO BE CONSTRUCTED AND STABILIZED PRIOR TO HAVING RUN-OFF DIRECTED TO THEM. 12. DAILY, OR AS REQUIRED, CONSTRUCT TEMPORARY BERMS, DRAINAGE DITCHES, CHECK DAMS, SEDIMENT TRAPS, ETC., TO PREVENT
- EROSION ON THE SITE AND PREVENT ANY SILTATION OF ABUTTING WATERS AND/OR PROPERTY.
- 13. PERFORM FINAL FINE GRADING, INCLUDING PLACEMENT OF 'SELECT' SUBGRADE MATERIALS.
- 14. PAVE ALL PARKING LOTS AND ROADWAYS WITH INITIAL 'BASE COURSE'.
- 15. PERFORM ALL REMAINING SITE CONSTRUCTION (i.e. BUILDING, UTILITY CONNECTIONS, ETC.).
- 16. LOAM AND SEED ALL DISTURBED AREAS AND INSTALL ANY REQUIRED SEDIMENT AND EROSION CONTROL FACILITIES (i.e. RIP RAP, EROSION CONTROL BLANKETS, ETC.).
- 17. FINISH PAVING ALL ROADWAYS AND PARKING AREAS WITH 'FINISH' COURSE.
- 18. ALL ROADWAYS AND PARKING LOTS SHALL BE STABILIZED WITHIN 72 HOURS OF ACHIEVING FINISHED GRADE.
- 19. ALL CUT AND FILL SLOPES SHALL BE SEEDED/LOAMED WITHIN 72 HOURS OF ACHIEVING FINISHED GRADE.
- 20. COMPLETE PERMANENT SEEDING AND LANDSCAPING.
- 21. REMOVE TEMPORARY EROSION CONTROL MEASURES AFTER SEEDING AREAS HAVE BEEN 75%-85% ESTABLISHED AND SITE IMPROVEMENTS ARE COMPLETE. SMOOTH AND RE-VEGETATE ALL DISTURBED AREAS.
- 22. CLEAN SITE AND ALL DRAINAGE STRUCTURES, PIPES AND SUMPS OF ALL SILT AND DEBRIS
- 23. INSTALL ALL PAINTED PAVEMENT MARKINGS AND SIGNAGE PER THE PLANS AND DETAILS.
- 24. ALL EROSION CONTROLS SHALL BE INSPECTED WEEKLY AND AFTER EVERY HALF-INCH OF RAINFALL.
- 25. UPON COMPLETION OF CONSTRUCTION, IT IS THE RESPONSIBILITY OF THE CONTRACTOR TO NOTIFY ANY RELEVANT PERMITTING AGENCIES THAT THE CONSTRUCTION HAS BEEN FINISHED IN A SATISFACTORY MANNER.

Designed and Produced in NH

Plan Name: EROSION AND SEDIMENT CONTROL DETAILS LIBERTY LANTERN ESTATES Project:

SHEET 21 OF 21

DRAWING No.

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