SITE PLAN & LOT LINE ADJUSTMENT PPM TOWNHOMES

TAX MAP 3 LOT 37-3 & 37-2 SPAULDING ROAD, FREMONT, NH

SHEET INDEX

CS COVER SHEET

EXISTING CONDITIONS PLAN

A1 LOT LINE ADJUSTMENT

C2 OVERALL SITE PLAN

C3 GRADING AND DRAINAGE PLAN


P1 PLAN AND PROFILE

S1-S2 SEPTIC DETAIL SHEETS

D1 DETAIL SHEETS

DETAIL SHEETS

E1 EROSION AND SEDIMENT CONTROL DETAILS

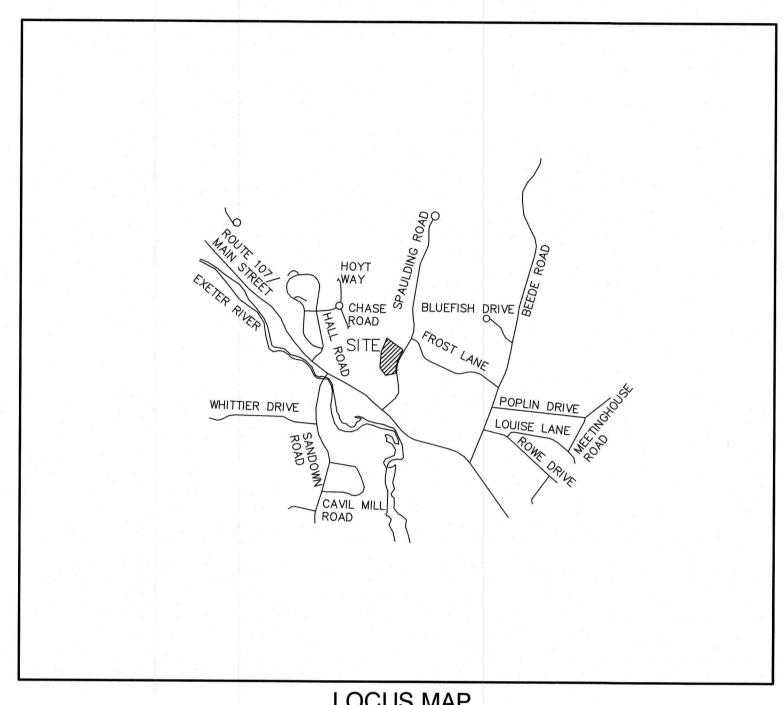

LOCUS MAP SCALE 1" = 2000'

PERMITS

TYPE OF PERMIT

NHDES SUBDIVISION PERMIT:

<u>STATUS</u>

SUBMITTED:

NMENTAL SERVICES - PERMIT NO.
RFACE SYSTEMS BUREAU

29 HAZEN DRIVE, P.O. BOX 95
CONCORD, NEW HAMPSHIRE 03302-0095
(603) 271-3503
DATED:

RESPONSIBLE CONSULTANT: EXPIRATION: JONES & BEACH ENGINEERS. INC.

USEPA NPDES PHASE II CONSTRUCTION GENERAL PERMIT,
NOTICE OF INTENT (NOI), AND NOTICE OF TERMINATION
(NOT) TO BE FILED IN ACCORDANCE WITH FEDERAL AND
LOCAL REGULATIONS PRIOR TO AND FOLLOWING CONSTRUCTION
EPA STORMWATER NOTICE PROCESSING CENTER

MAIL CODE 4203M,
US EPA
1200 PENNSYLVANIA AVENUE, NW
WASHINGTON, DC 20460
RESPONSIBLE CONSULTANT:
JONES & BEACH ENGINEERS, INC.

TYPE OF PERMIT

STATUS

TOWN OF FREMONT SITE PLAN APPROVAL:

SUBMITTED:
TOWN OF FREMONT PLANNING BOARD
295 MAIN STREET

JONES & BEACH ENGINEERS, INC.

295 MAIN STREET PERMIT NO. FREMONT, NEW HAMPSHIRE 03044

(603) 895-2226 RESPONSIBLE CONSULTANT:

DATED:

EXPIRATION:

APPLICANT / DEVELOPER
PPM FREMONT HOLDING, LLC
326 MAIN STREET
FREMONT, NH 03044
CONTACT: TOM NISBET

CIVIL ENGINEER / SURVEYOR
JONES & BEACH ENGINEERS, INC.
85 PORTSMOUTH AVENUE
PO BOX 219
STRATHAM, NH 03885
(603) 772-4746
CONTACT: BARRY GIER
EMAIL: BGIER@JONESANDBEACH.COM

OWNER OF RECORD
PPM FREMONT HOLDING, LLC

326 MAIN STREET FREMONT, NH 03044 CONTACT: TOM NISBET

WETLAND CONSULTANT
GZA GEOENVIRONMENTAL INC.
5 COMMERCE PARK NORTH, SUITE 201
BEDFORD, NH 03110
(603) 430-9282

ELECTRIC

EVERSOURCE 740 N COMMERCIAL ST PO BOX 330 MANCHESTER, NH 03105-0330 (800) 662-7764

TELEPHONE
CONSOLIDATED COMMUNICATIONS
100 TRI CITY ROAD
SOMERWORTH, NH 03878
ATTN:DAVE KESTNER
(603) 743-1114

CABLE TV
COMCAST COMMUNICATION CORPORATION
334-B CALEF HIGHWAY
EPPING, NH 03042-2325
(603) 679-5695

PROJECT PARCEL
TOWN OF FREMONT
TAX MAP 3, BLOCK 37, LOT 3

APPLICANT/OWNER
PPM FREMONT HOLDINGS, LLC
326 MAIN STREET, UNIT 11
FREMONT, NH 03044
BK 5059, PG 1628

TOTAL LOT AREA 233,197 SQ. FT. 5.35 ACRES

APPROVED — FREMONT, NH PLANNING BOARD

DATE:

Design: BWG Draft: DFP Date: 10/6/2021
Checked: BWG Scale: AS SHOWN Project No.: 20631
Drawing Name: 20631-PLAN.dwg
THIS PLAN SHALL NOT BE MODIFIED WITHOUT WRITTEN
PERMISSION FROM JONES & BEACH ENGINEERS, INC. (JBE).

ANY ALTERATIONS, AUTHORIZED OR OTHERWISE, SHALL BE

AT THE USER'S SOLE RISK AND WITHOUT LIABILITY TO JBE.

	G.				
0	10/6/21		ISSUED FOR REVIEW	1 18 7 1 1 V	BWG
REV.	DATE	8	REVISION		BY

Designed and Produced in NH

Jones & Beach Engineers, Inc.

85 Portsmouth Ave. Civil Engineering Services
PO Box 219
Stratham, NH 03885

Designed and Produced in NH

603-772-4746
FAX: 603-772-0227
E-MAIL: JBE@JONESANDBEACH.COM

Plan Name:

COVER SHEET

Project:

PPM TOWNHOMES
SPAULDING ROAD, FREMONT, NH

Owner of Record:


PPM FREMONT HOLDING, LLC
326 MAIN STREET FREMONT, NH 03044

DRAWING No.

CS

SHEET 1 OF 11

JBE PROJECT NO. 20631

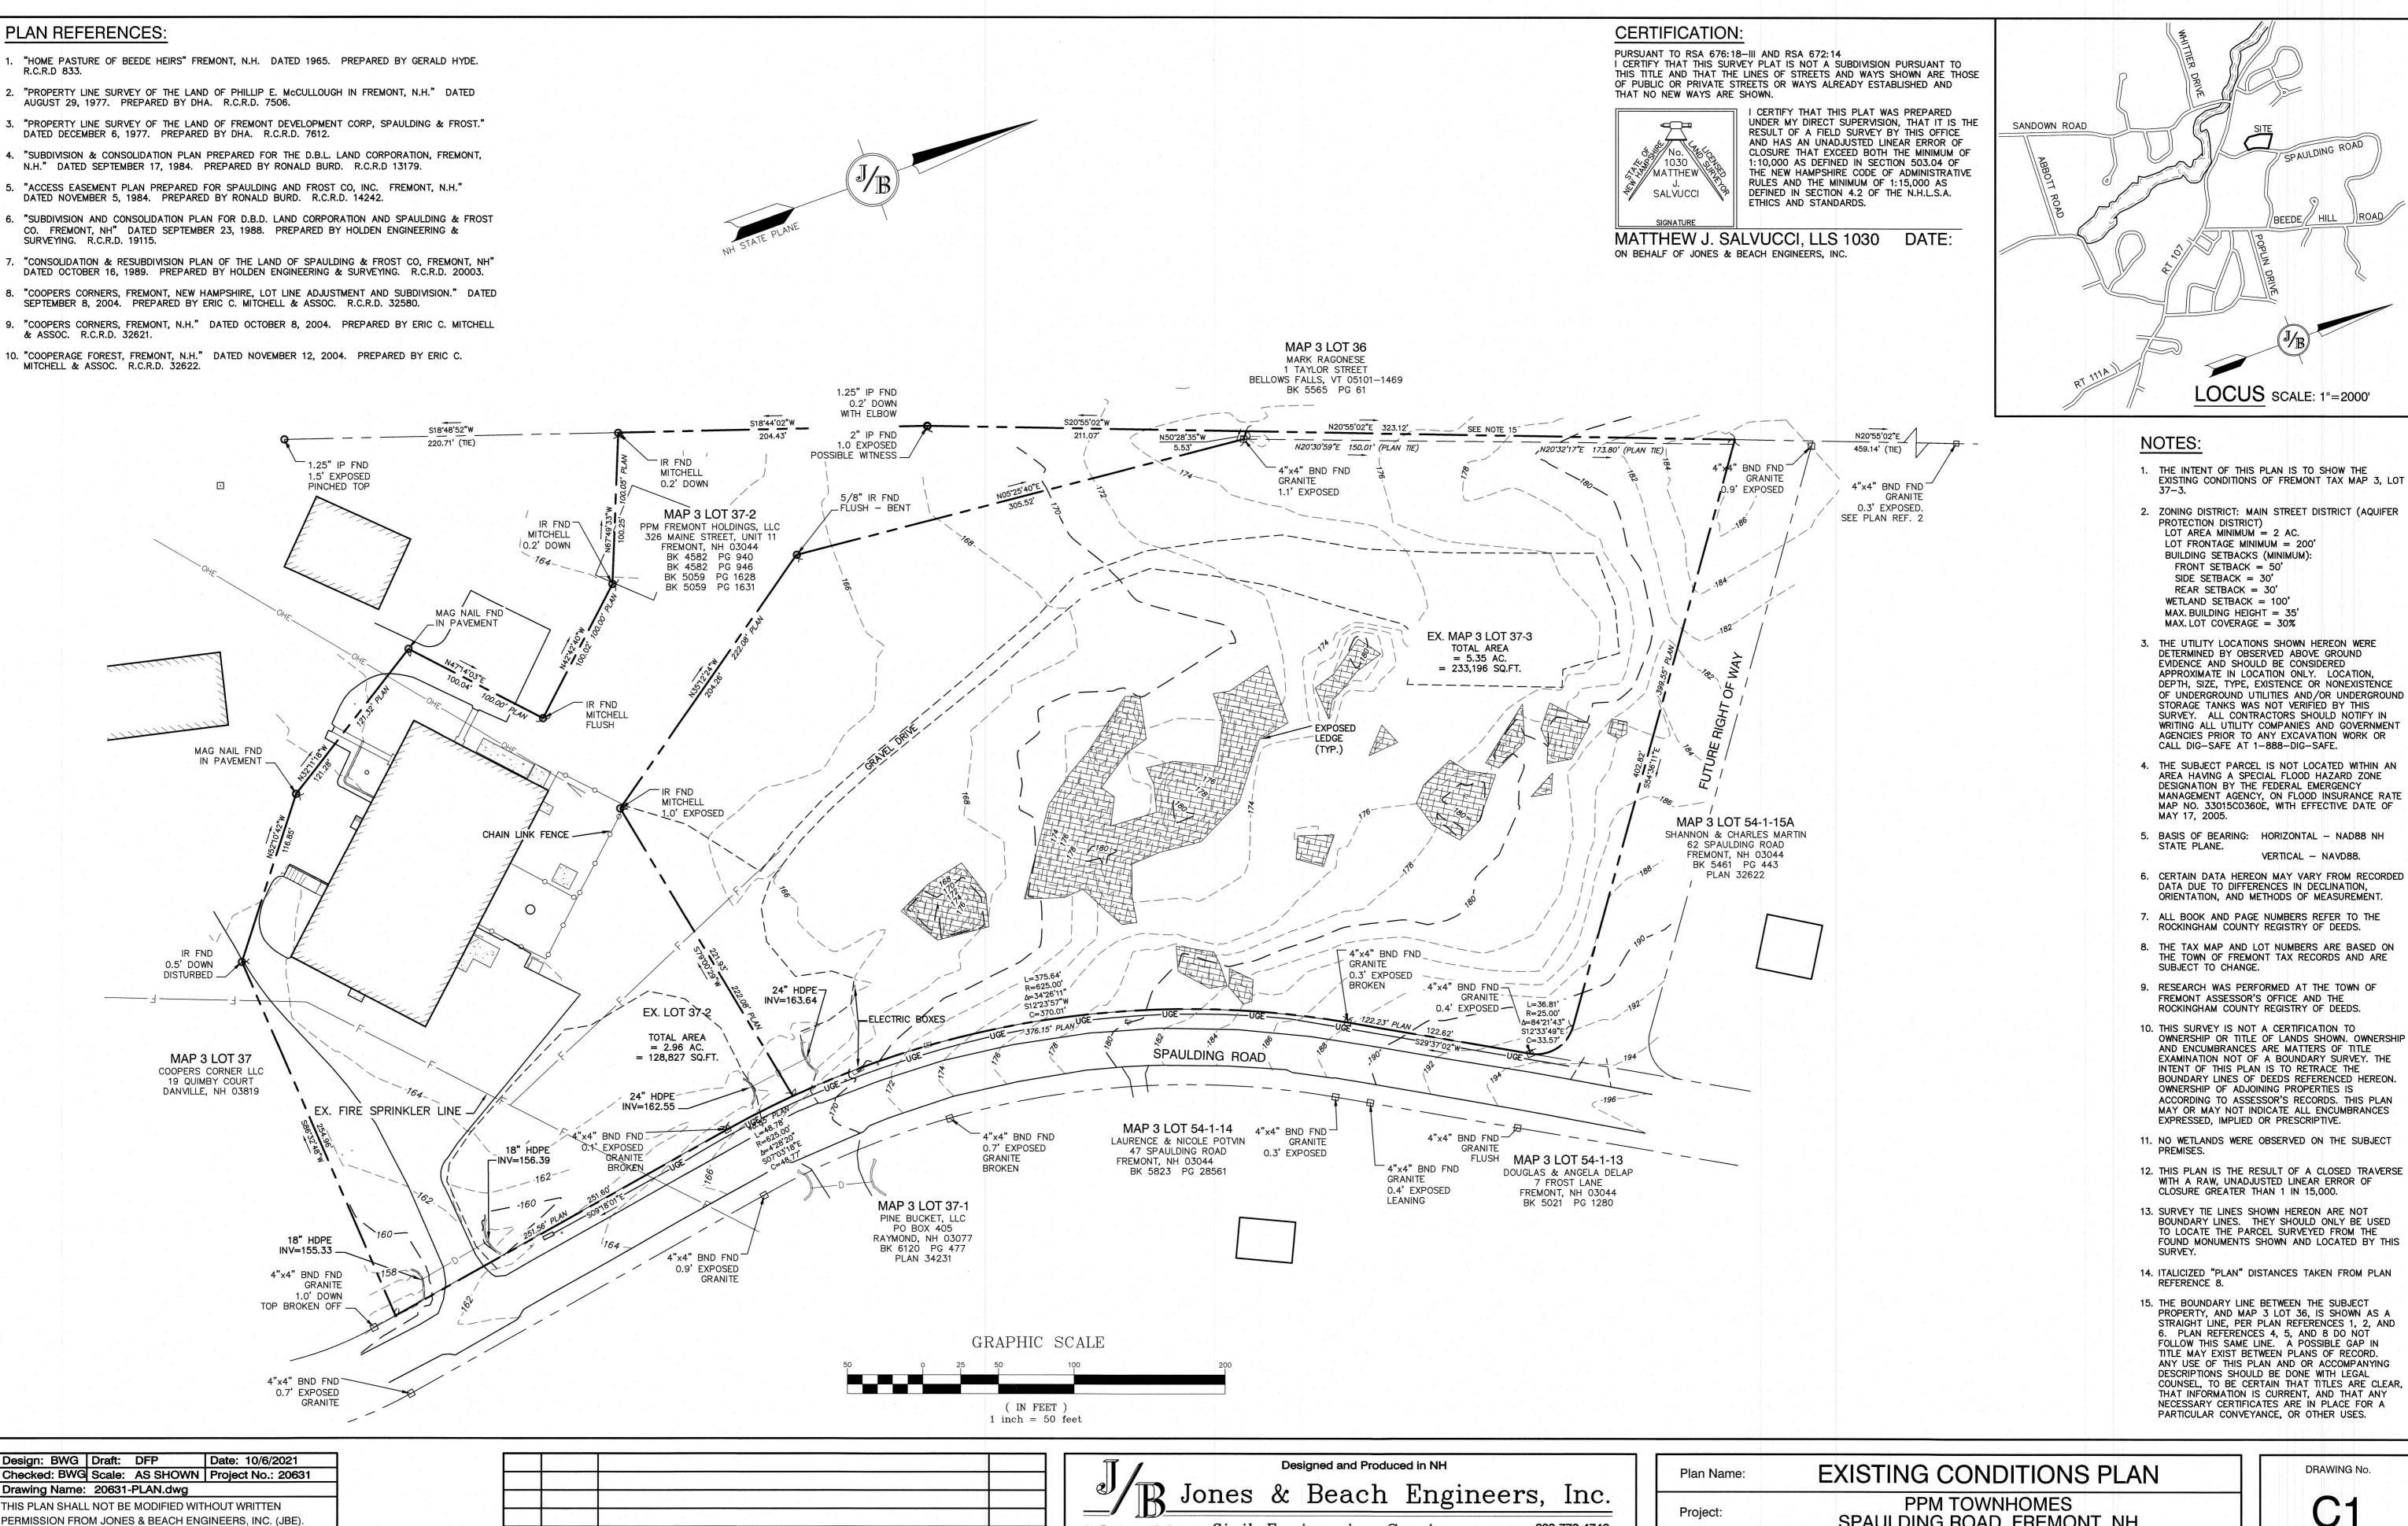

Stratham, NH 03885

PERMISSION FROM JONES & BEACH ENGINEERS, INC. (JBE). ANY ALTERATIONS, AUTHORIZED OR OTHERWISE, SHALL BE AT THE USER'S SOLE RISK AND WITHOUT LIABILITY TO JBE

ISSUED FOR REVIEW 0 10/6/21 **BWG** REV. DATE **REVISION** BY

85 Portsmouth Ave. Civil Engineering Services PO Box 219

603-772-4746 FAX: 603-772-0227 E-MAIL: JBE@JONESANDBEACH.COM

Owner of Record:


SPAULDING ROAD, FREMONT, NH PPM FREMONT HOLDING, LLC


326 MAIN STREET FREMONT, NH 03044

BEEDE / HILL

SHEET 2 OF 11 JBE PROJECT NO. 20631

DRAWING No.

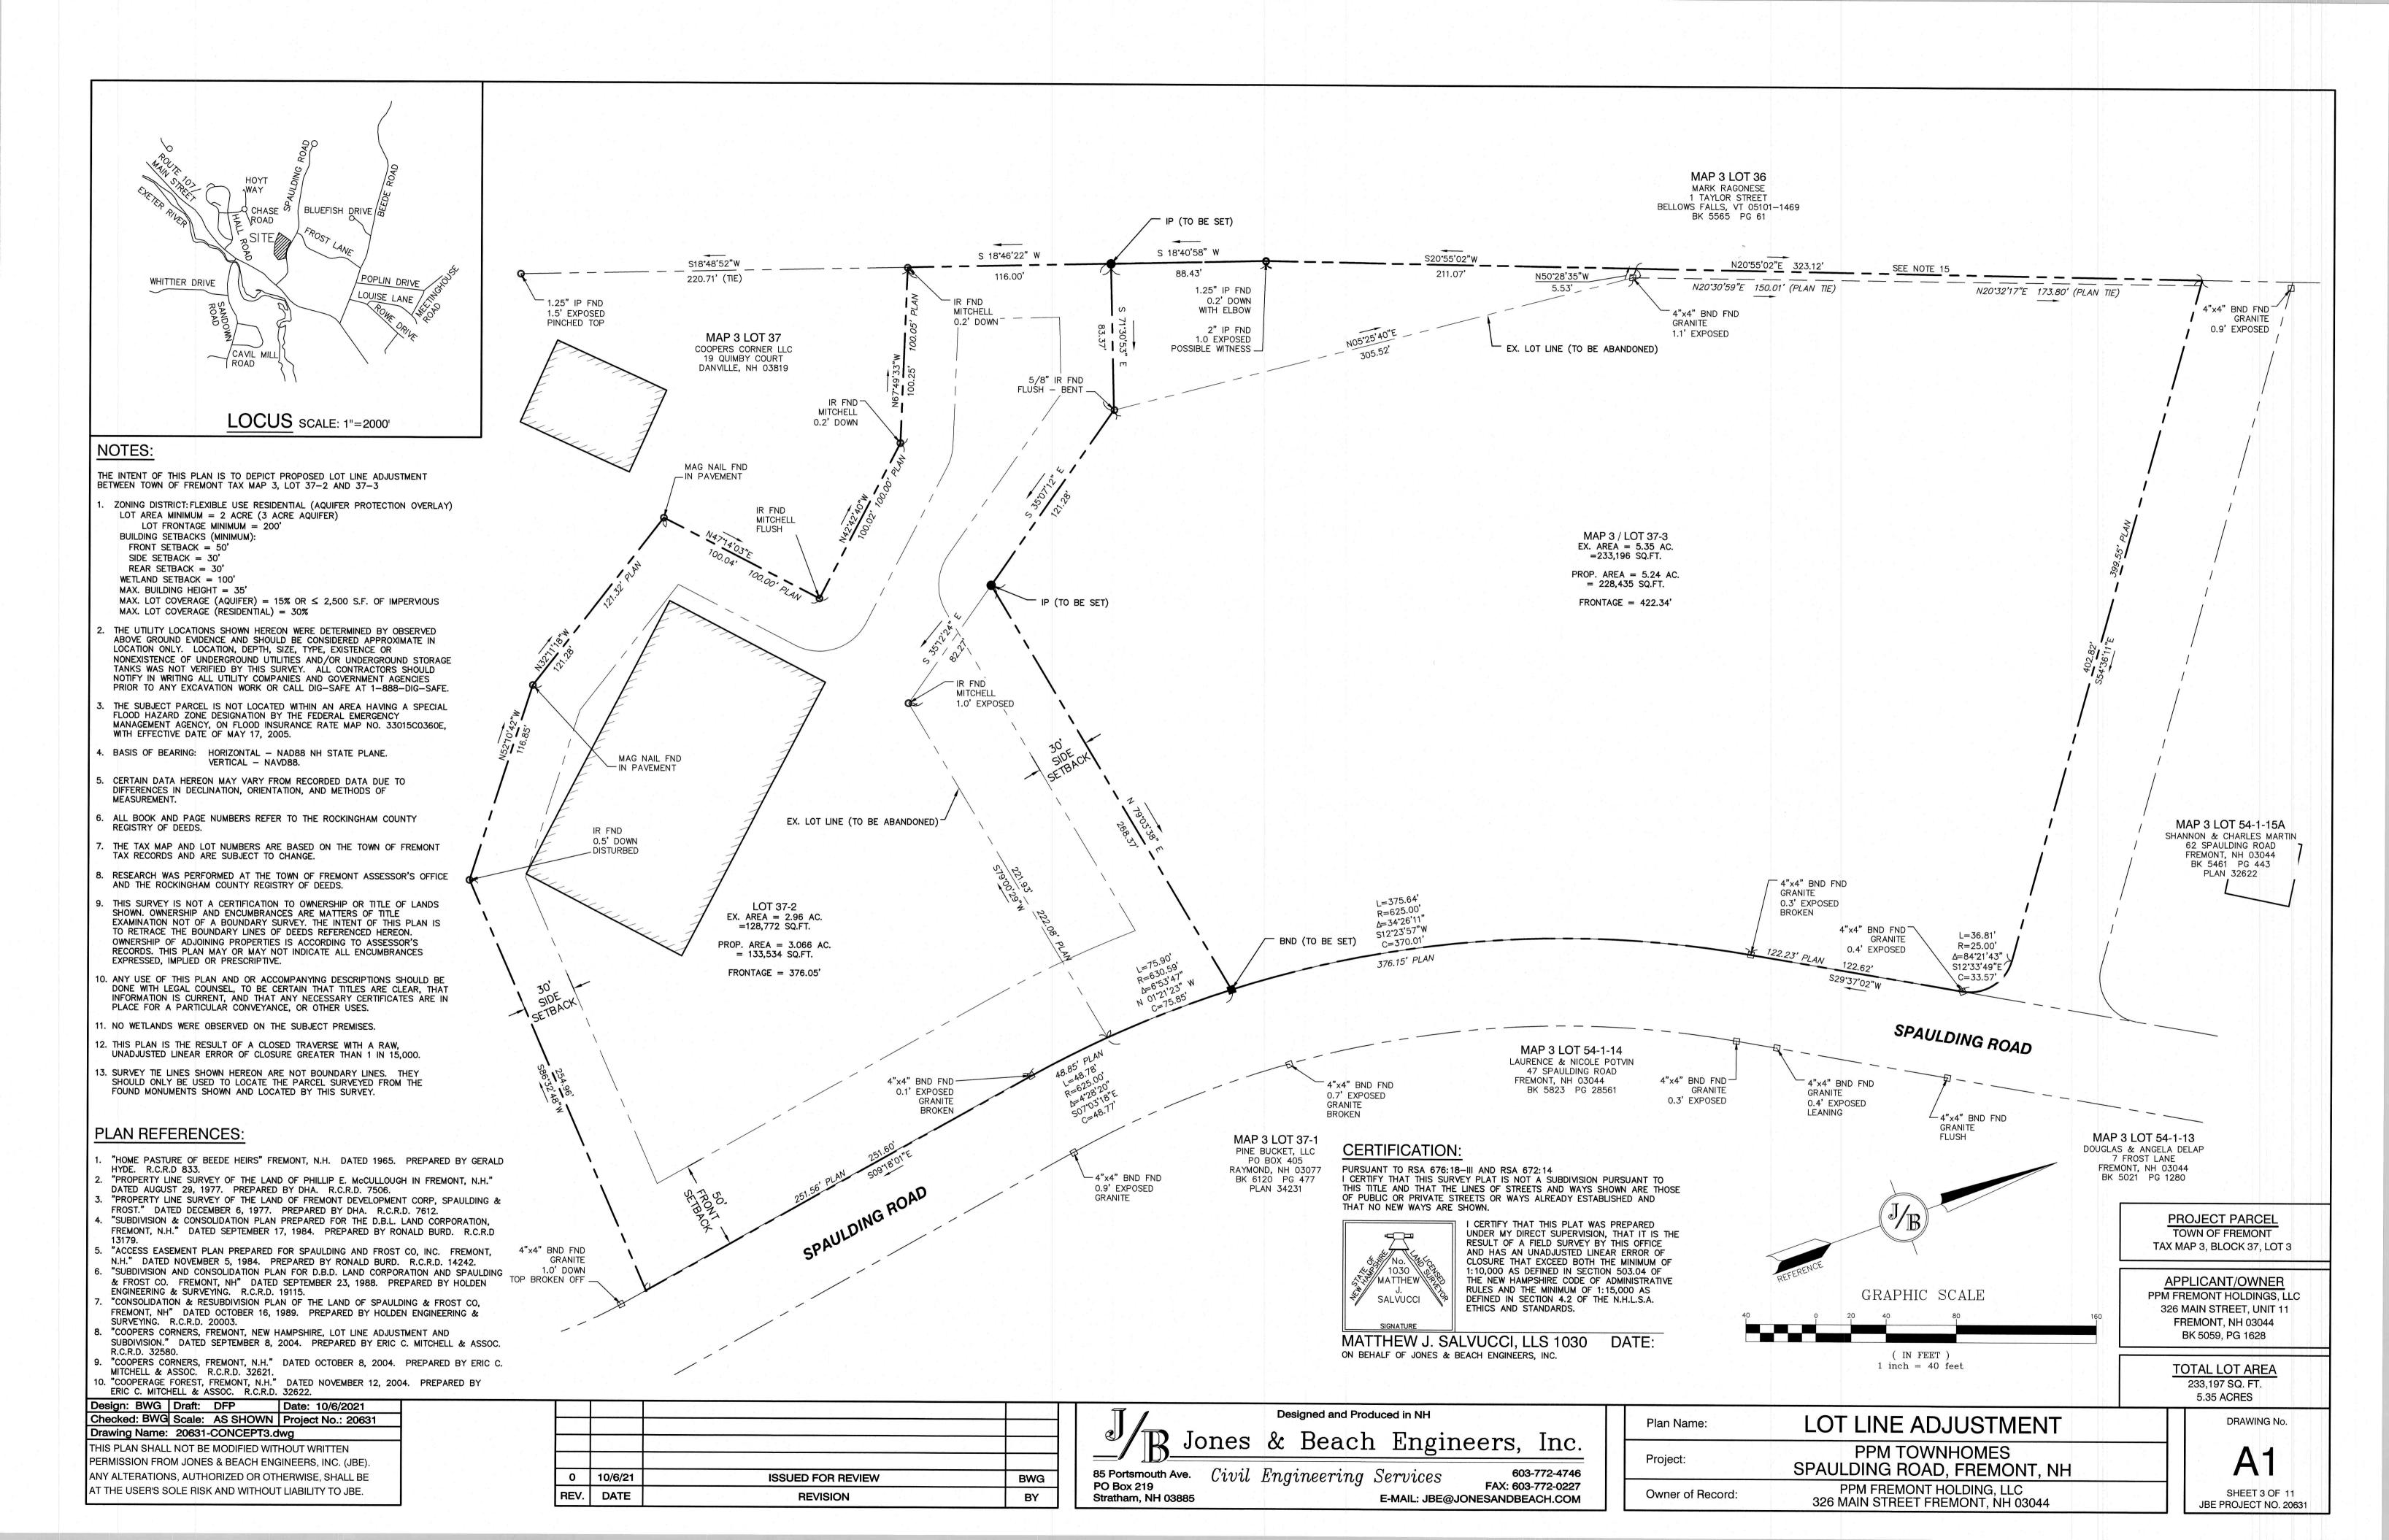

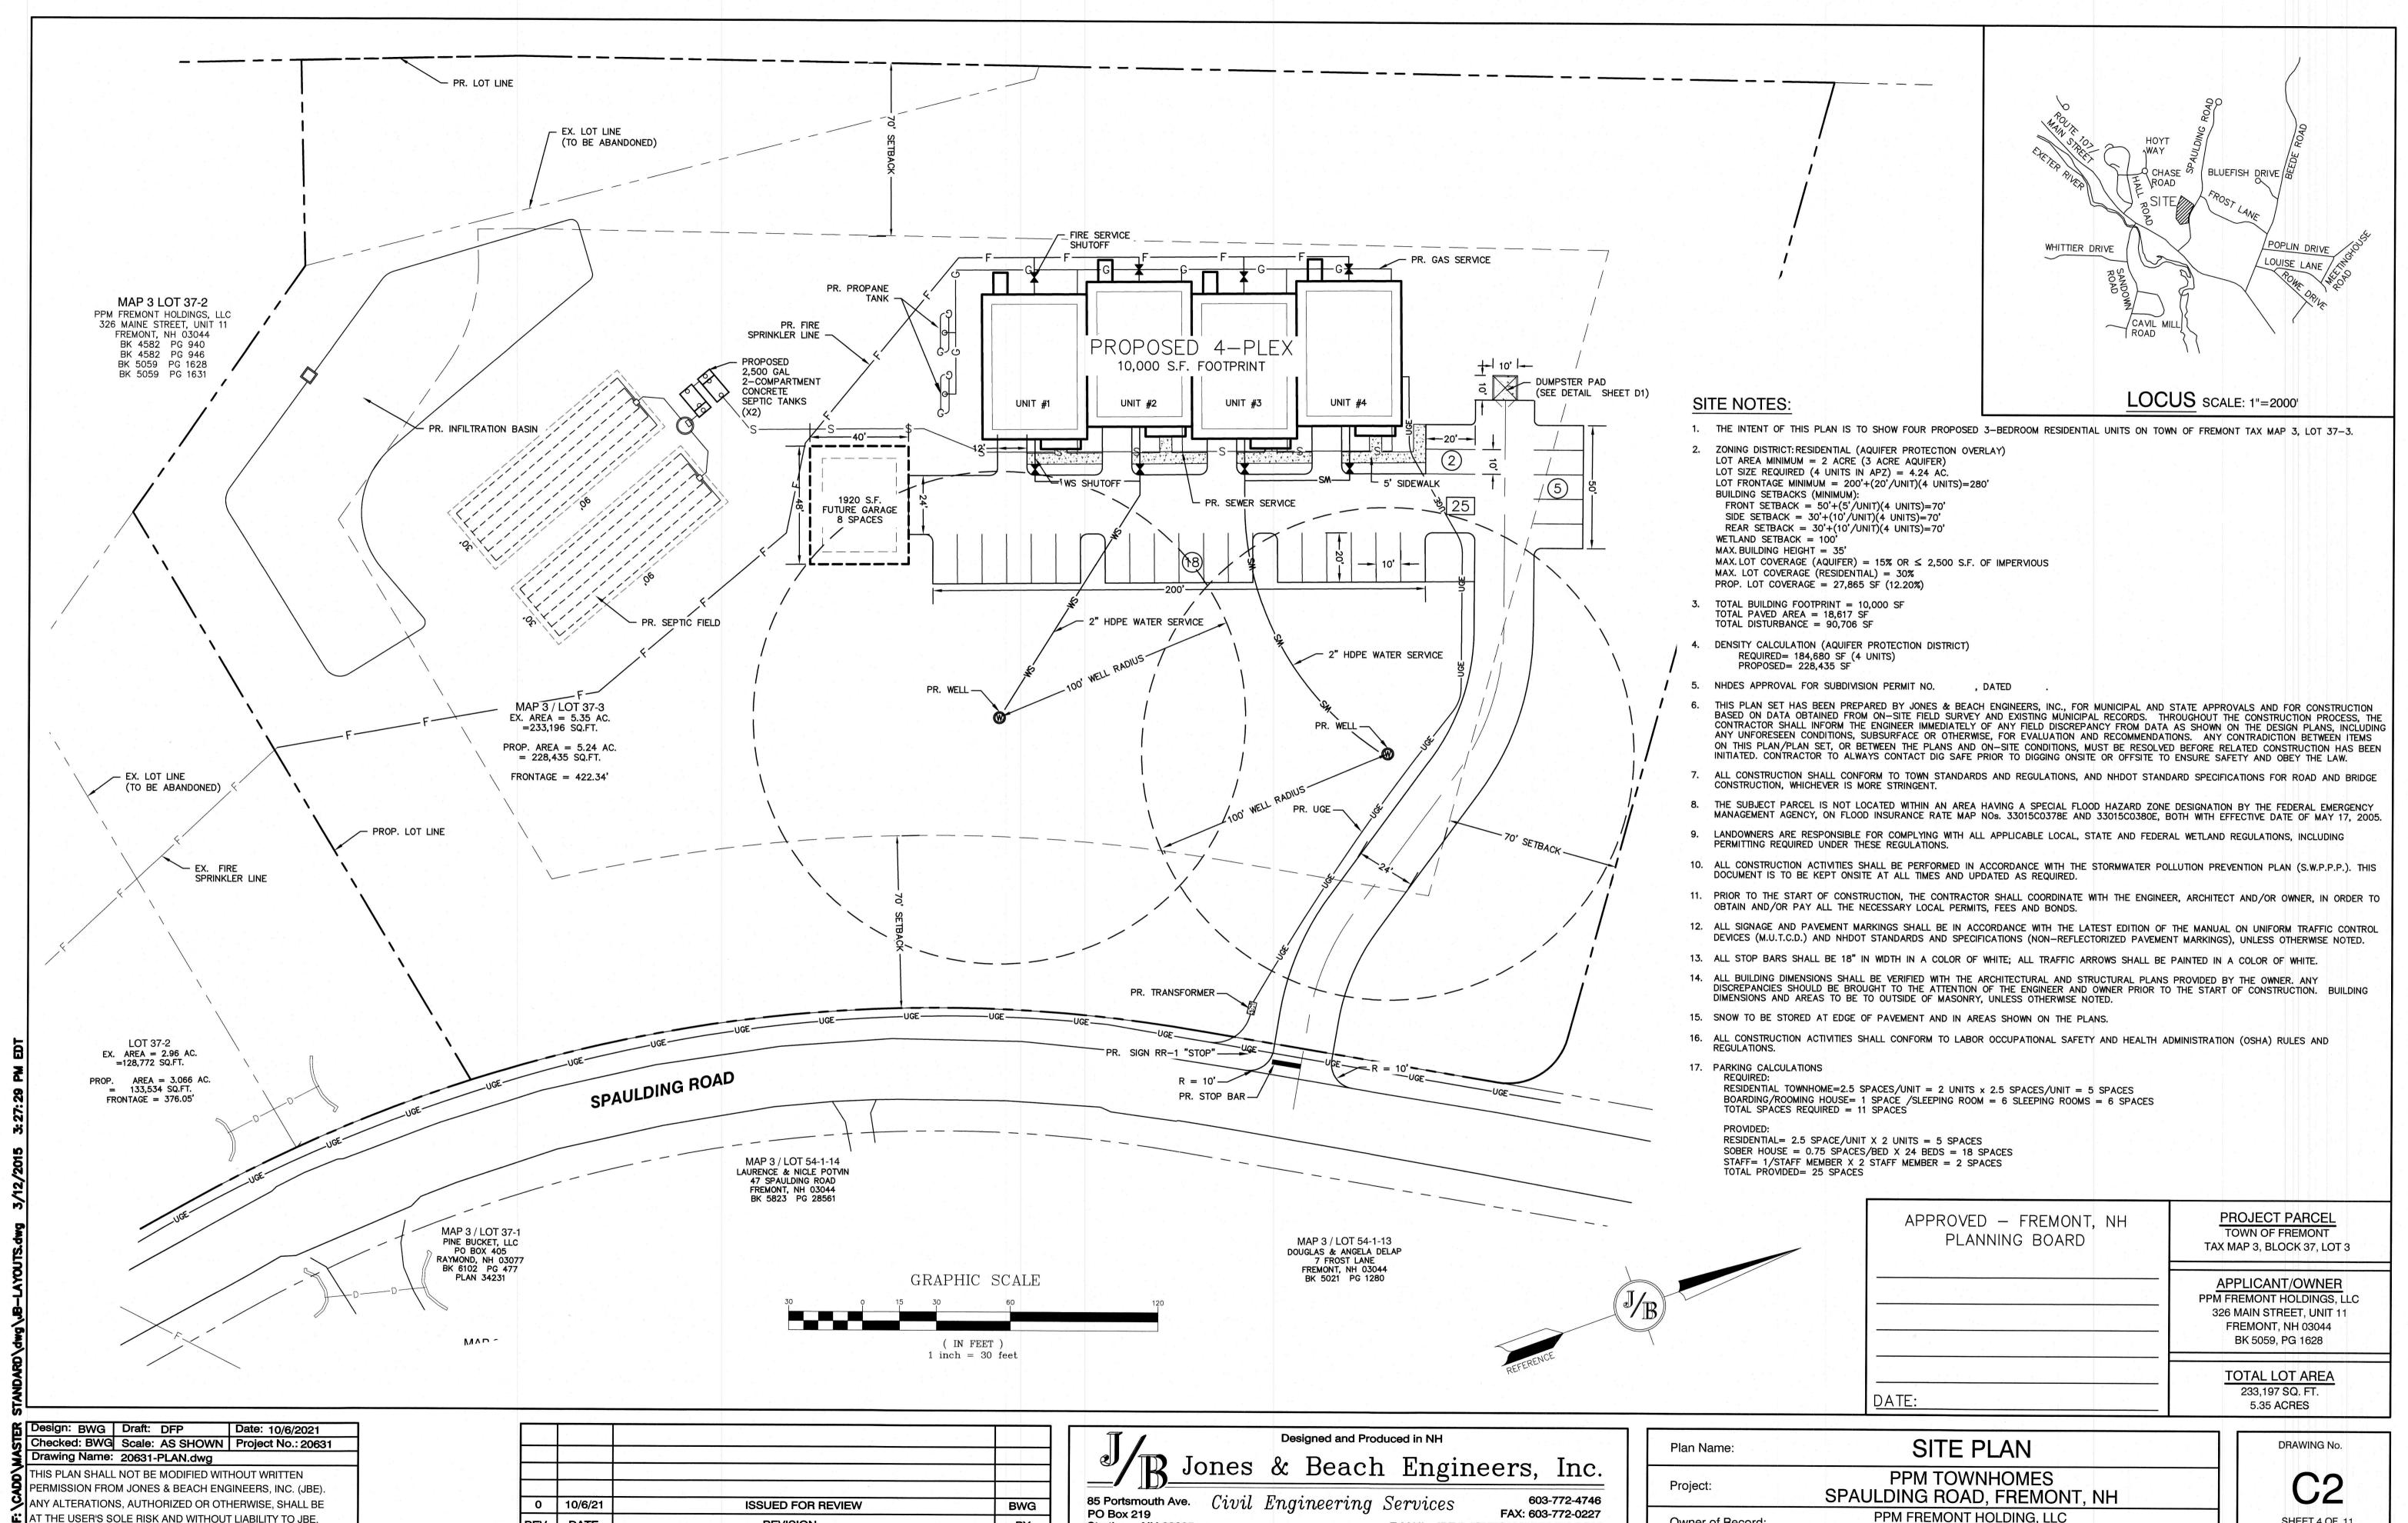

AT THE USER'S SOLE RISK AND WITHOUT LIABILITY TO JBE.

DATE

REVISION

BY


Stratham, NH 03885


SHEET 4 OF 11 JBE PROJECT NO. 20631


Owner of Record:

326 MAIN STREET FREMONT, NH 03044

E-MAIL: JBE@JONESANDBEACH.COM

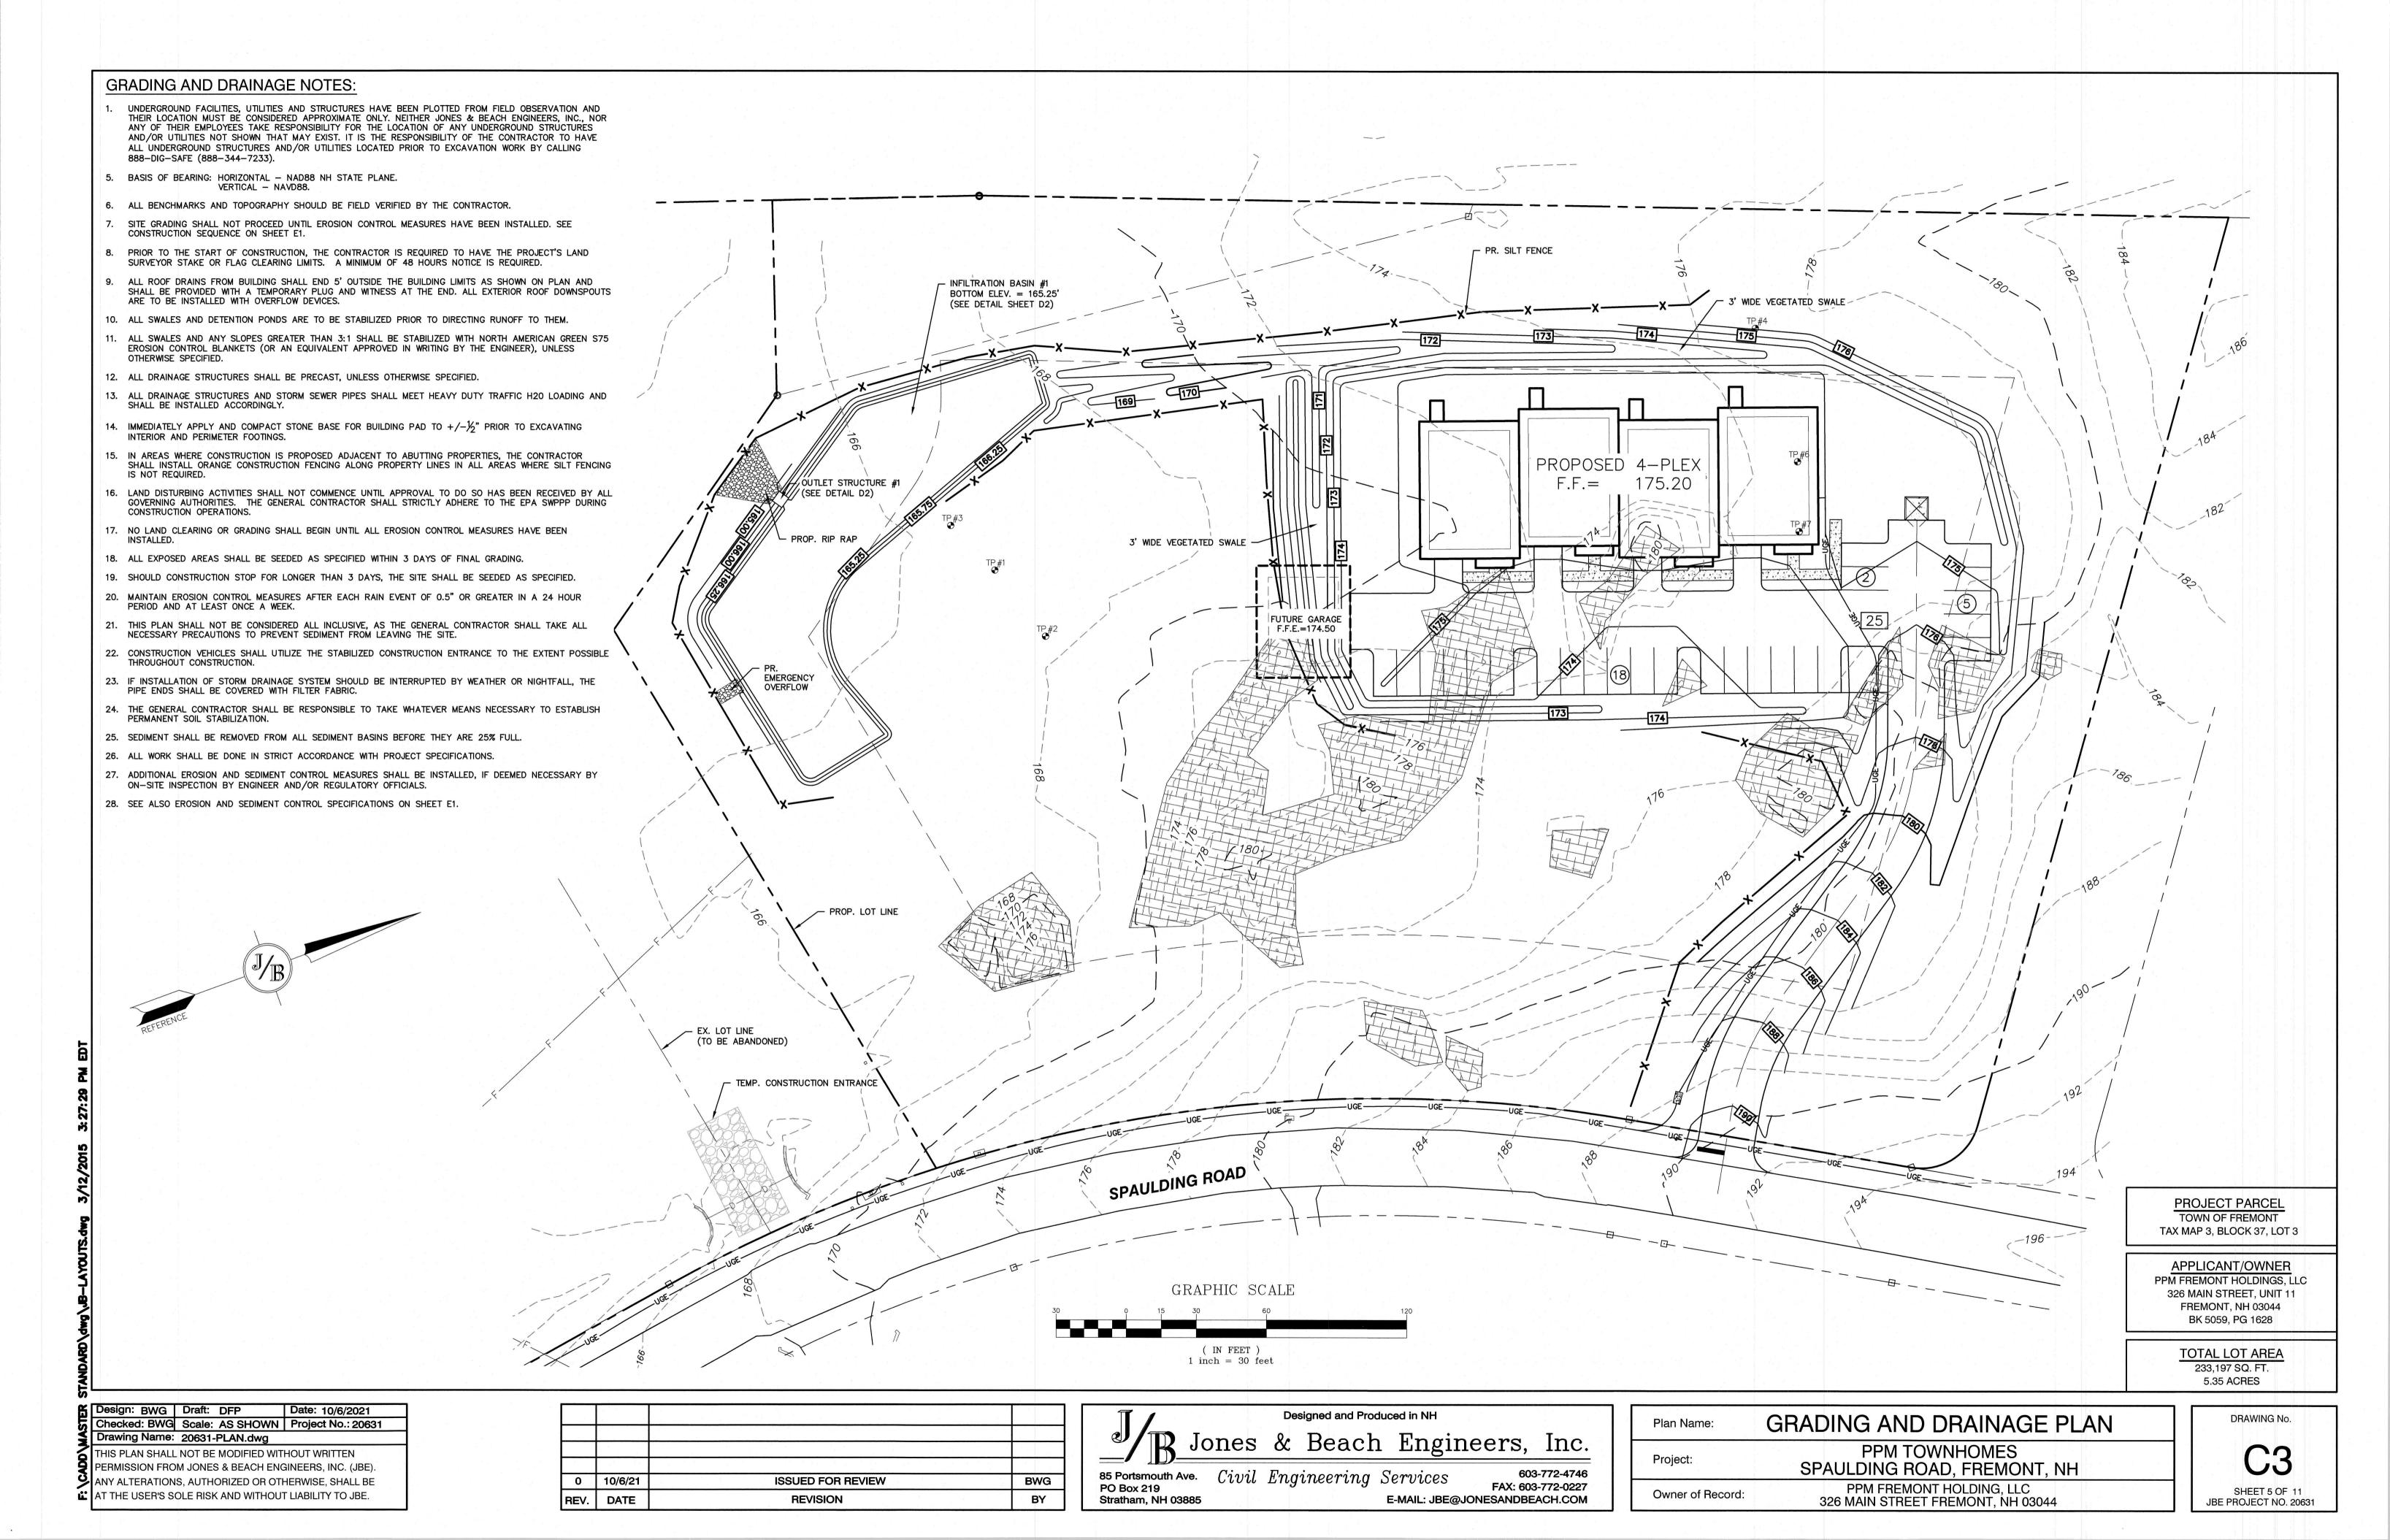

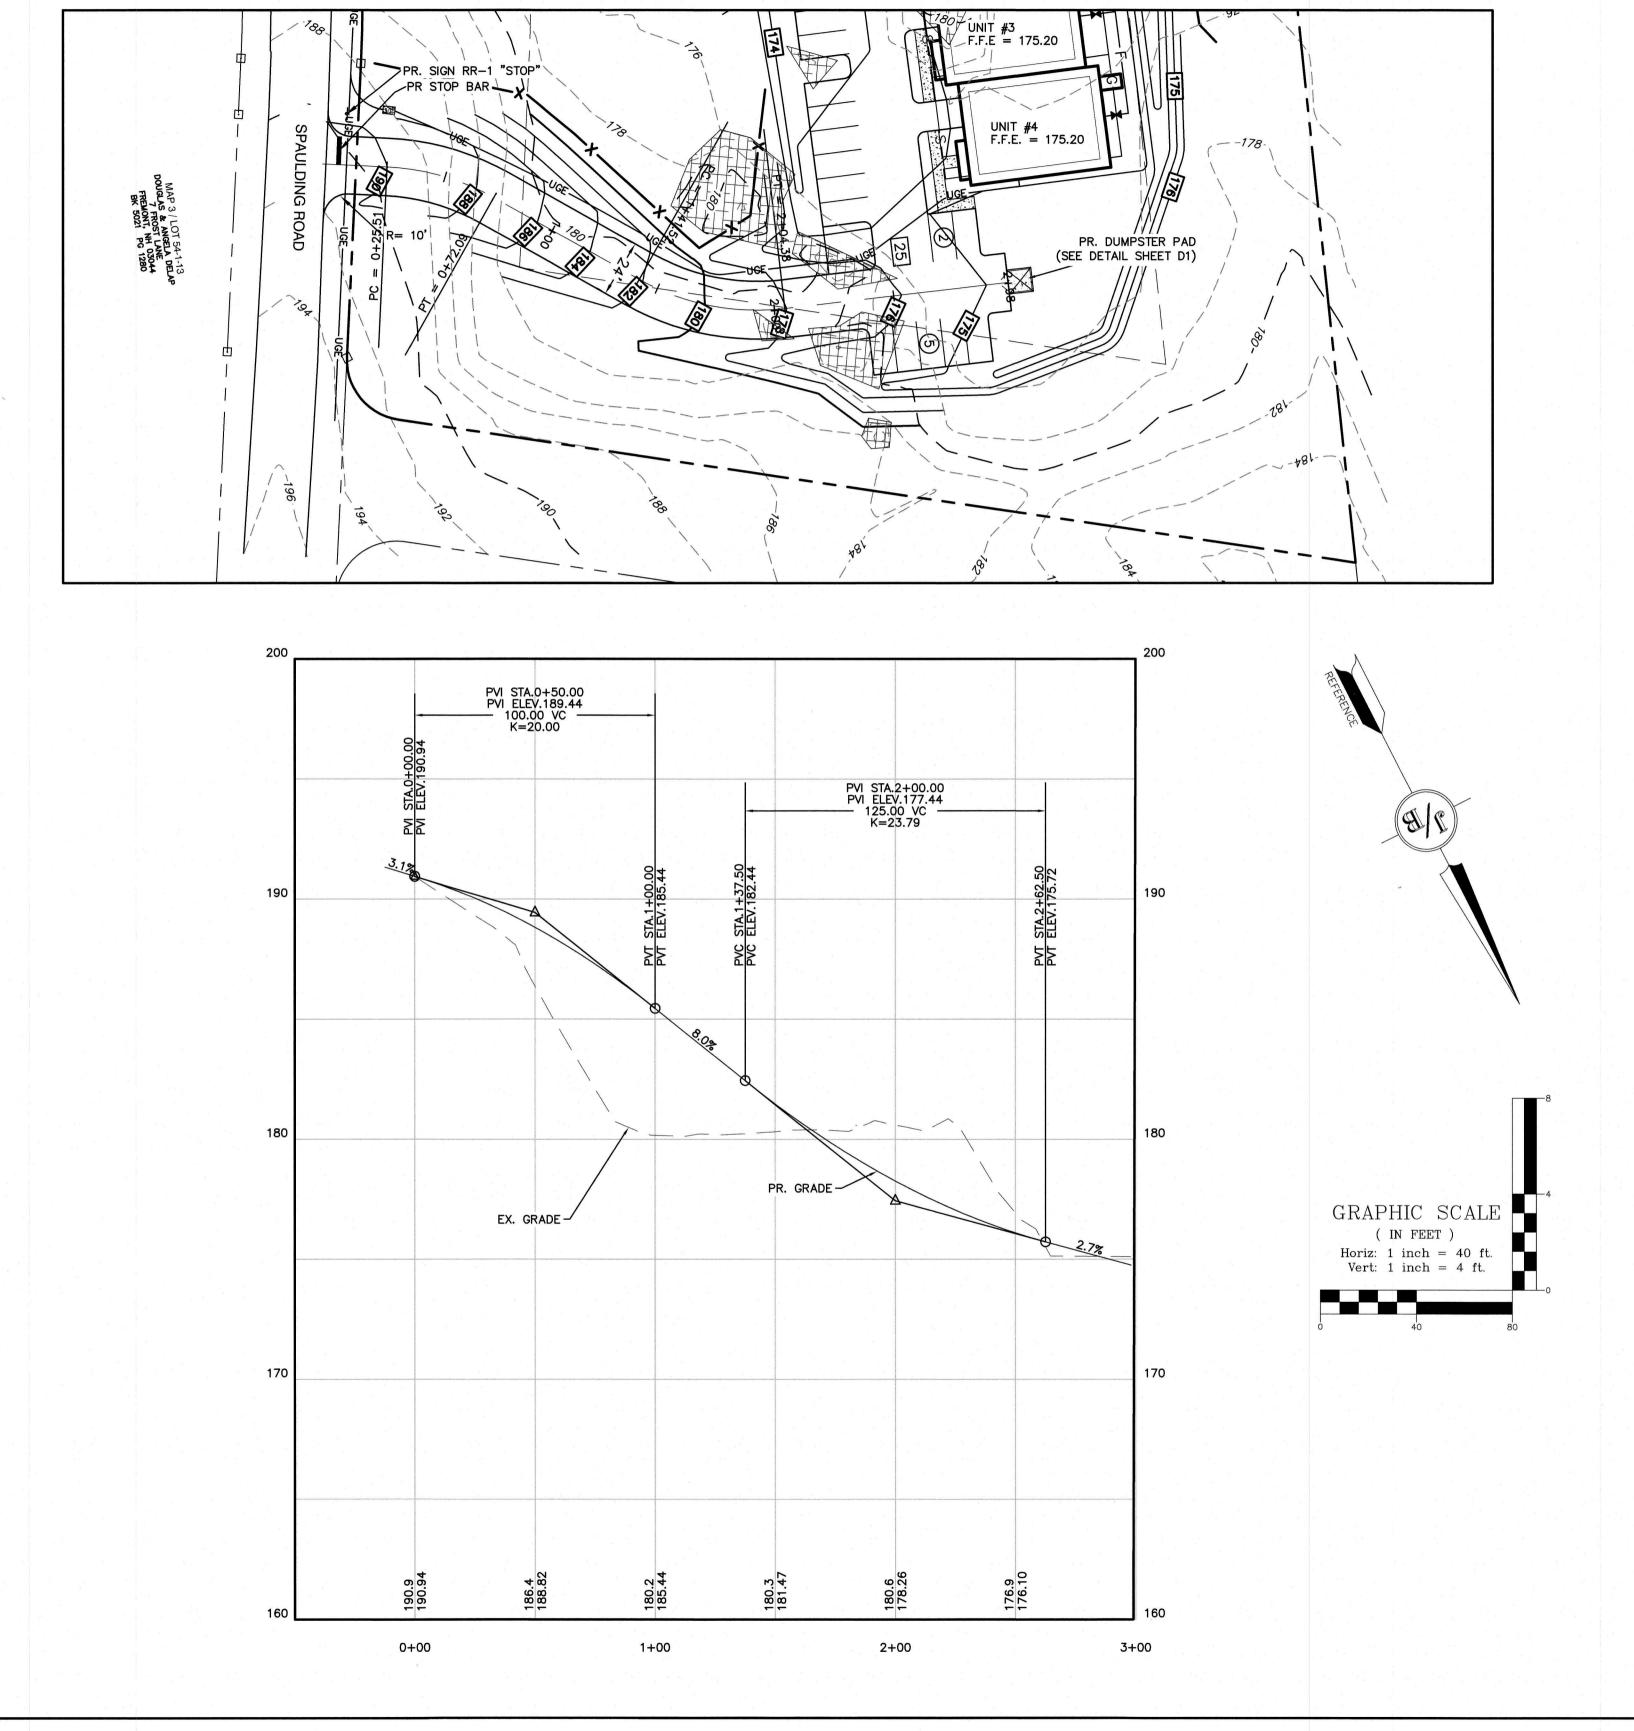

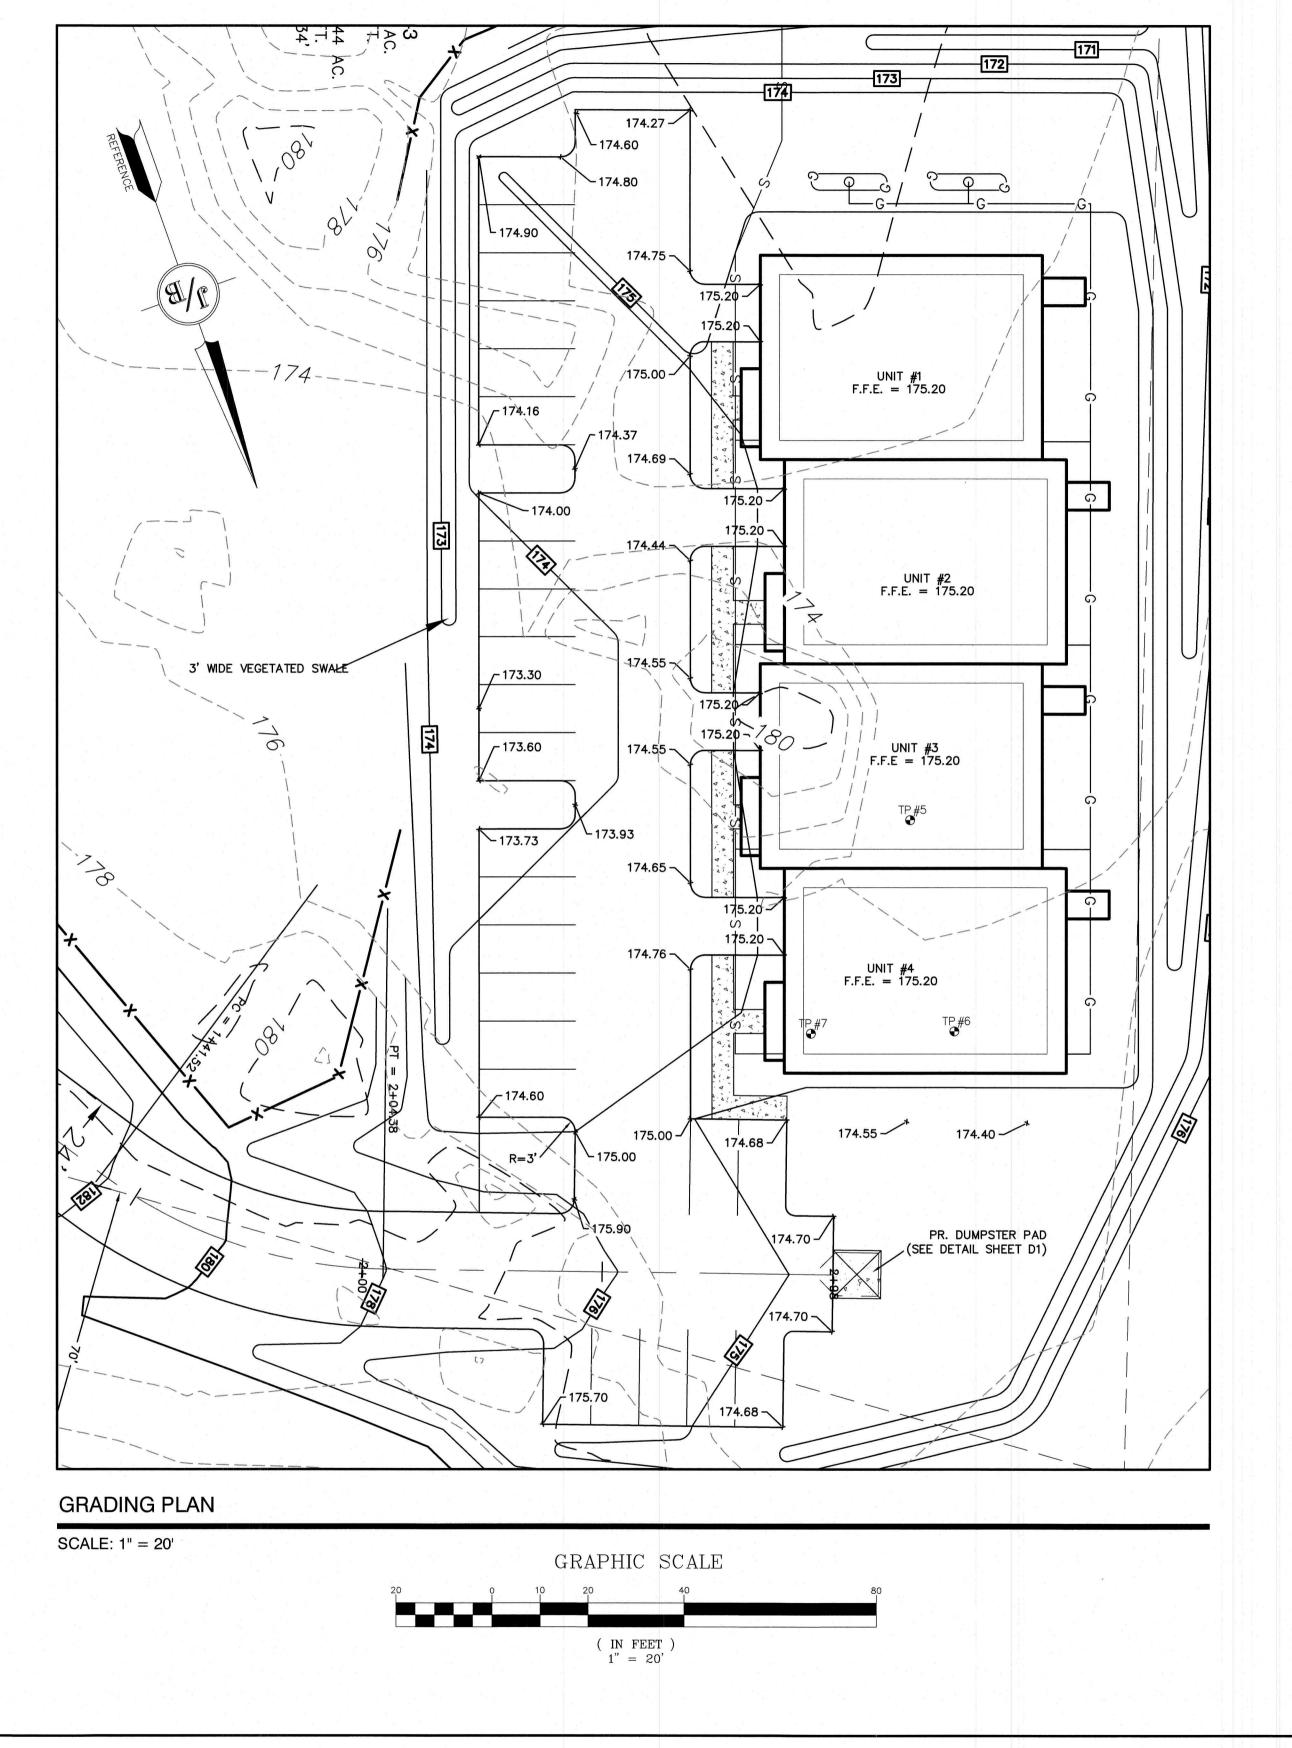

Design: BWG Draft: DFP Date: 10/6/2021
Checked: BWG Scale: AS SHOWN Project No.: 20631 Drawing Name: 20631-PLAN.dwg

THIS PLAN SHALL NOT BE MODIFIED WITHOUT WRITTEN PERMISSION FROM JONES & BEACH ENGINEERS, INC. (JBE). ANY ALTERATIONS, AUTHORIZED OR OTHERWISE, SHALL BE AT THE USER'S SOLE RISK AND WITHOUT LIABILITY TO JBE.

			190
1 11			
0	10/6/21	ISSUED FOR REVIEW	BWG
REV.	DATE	REVISION	BY


Designed and Produced in NH Pones & Beach Engineers, Inc. 85 Portsmouth Ave. Civil Engineering Services
PO Box 219
Stratham, NH 03885


Civil Engineering Services
E-MAIL: JBE@ 603-772-4746 FAX: 603-772-0227

E-MAIL: JBE@JONESANDBEACH.COM


Plan Name:	PLAN AND PROFILE	
Project:	PPM TOWNHOMES SPAULDING ROAD, FREMONT, NH	
Owner of Record:	PPM FREMONT HOLDING, LLC 326 MAIN STREET FREMONT, NH 03044	

DRAWING No. SHEET 6 OF 11 JBE PROJECT NO. 20631

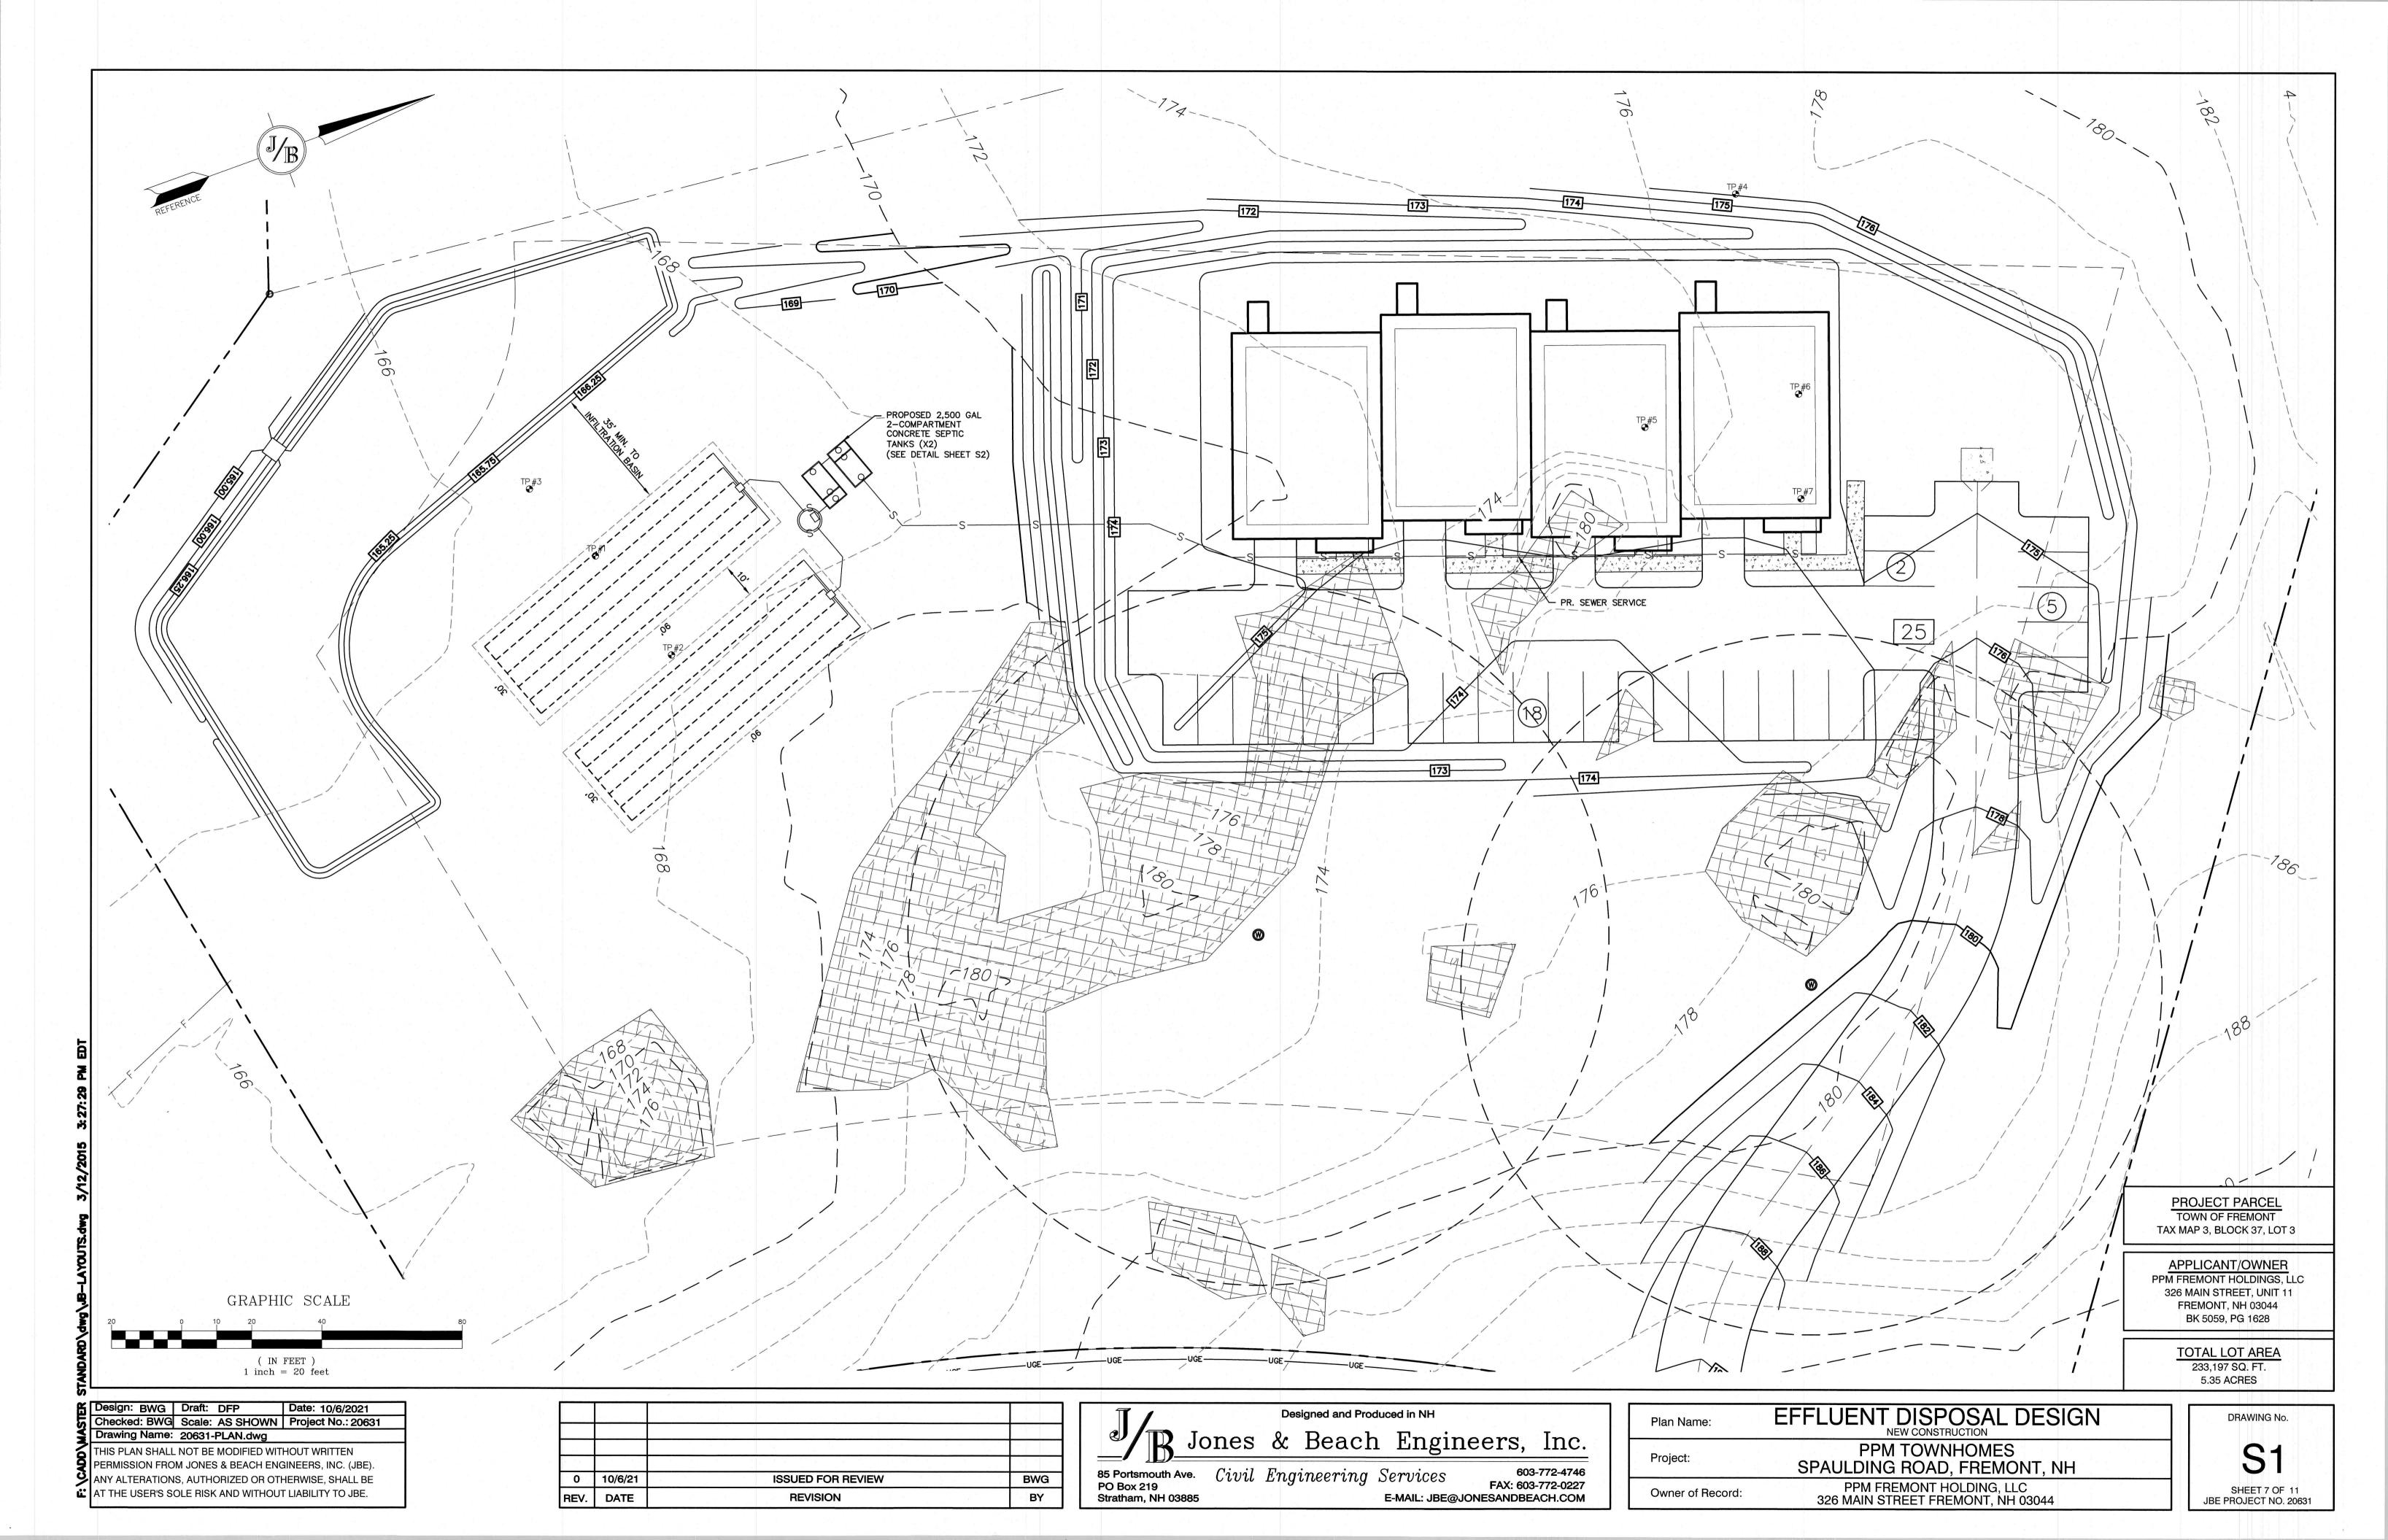

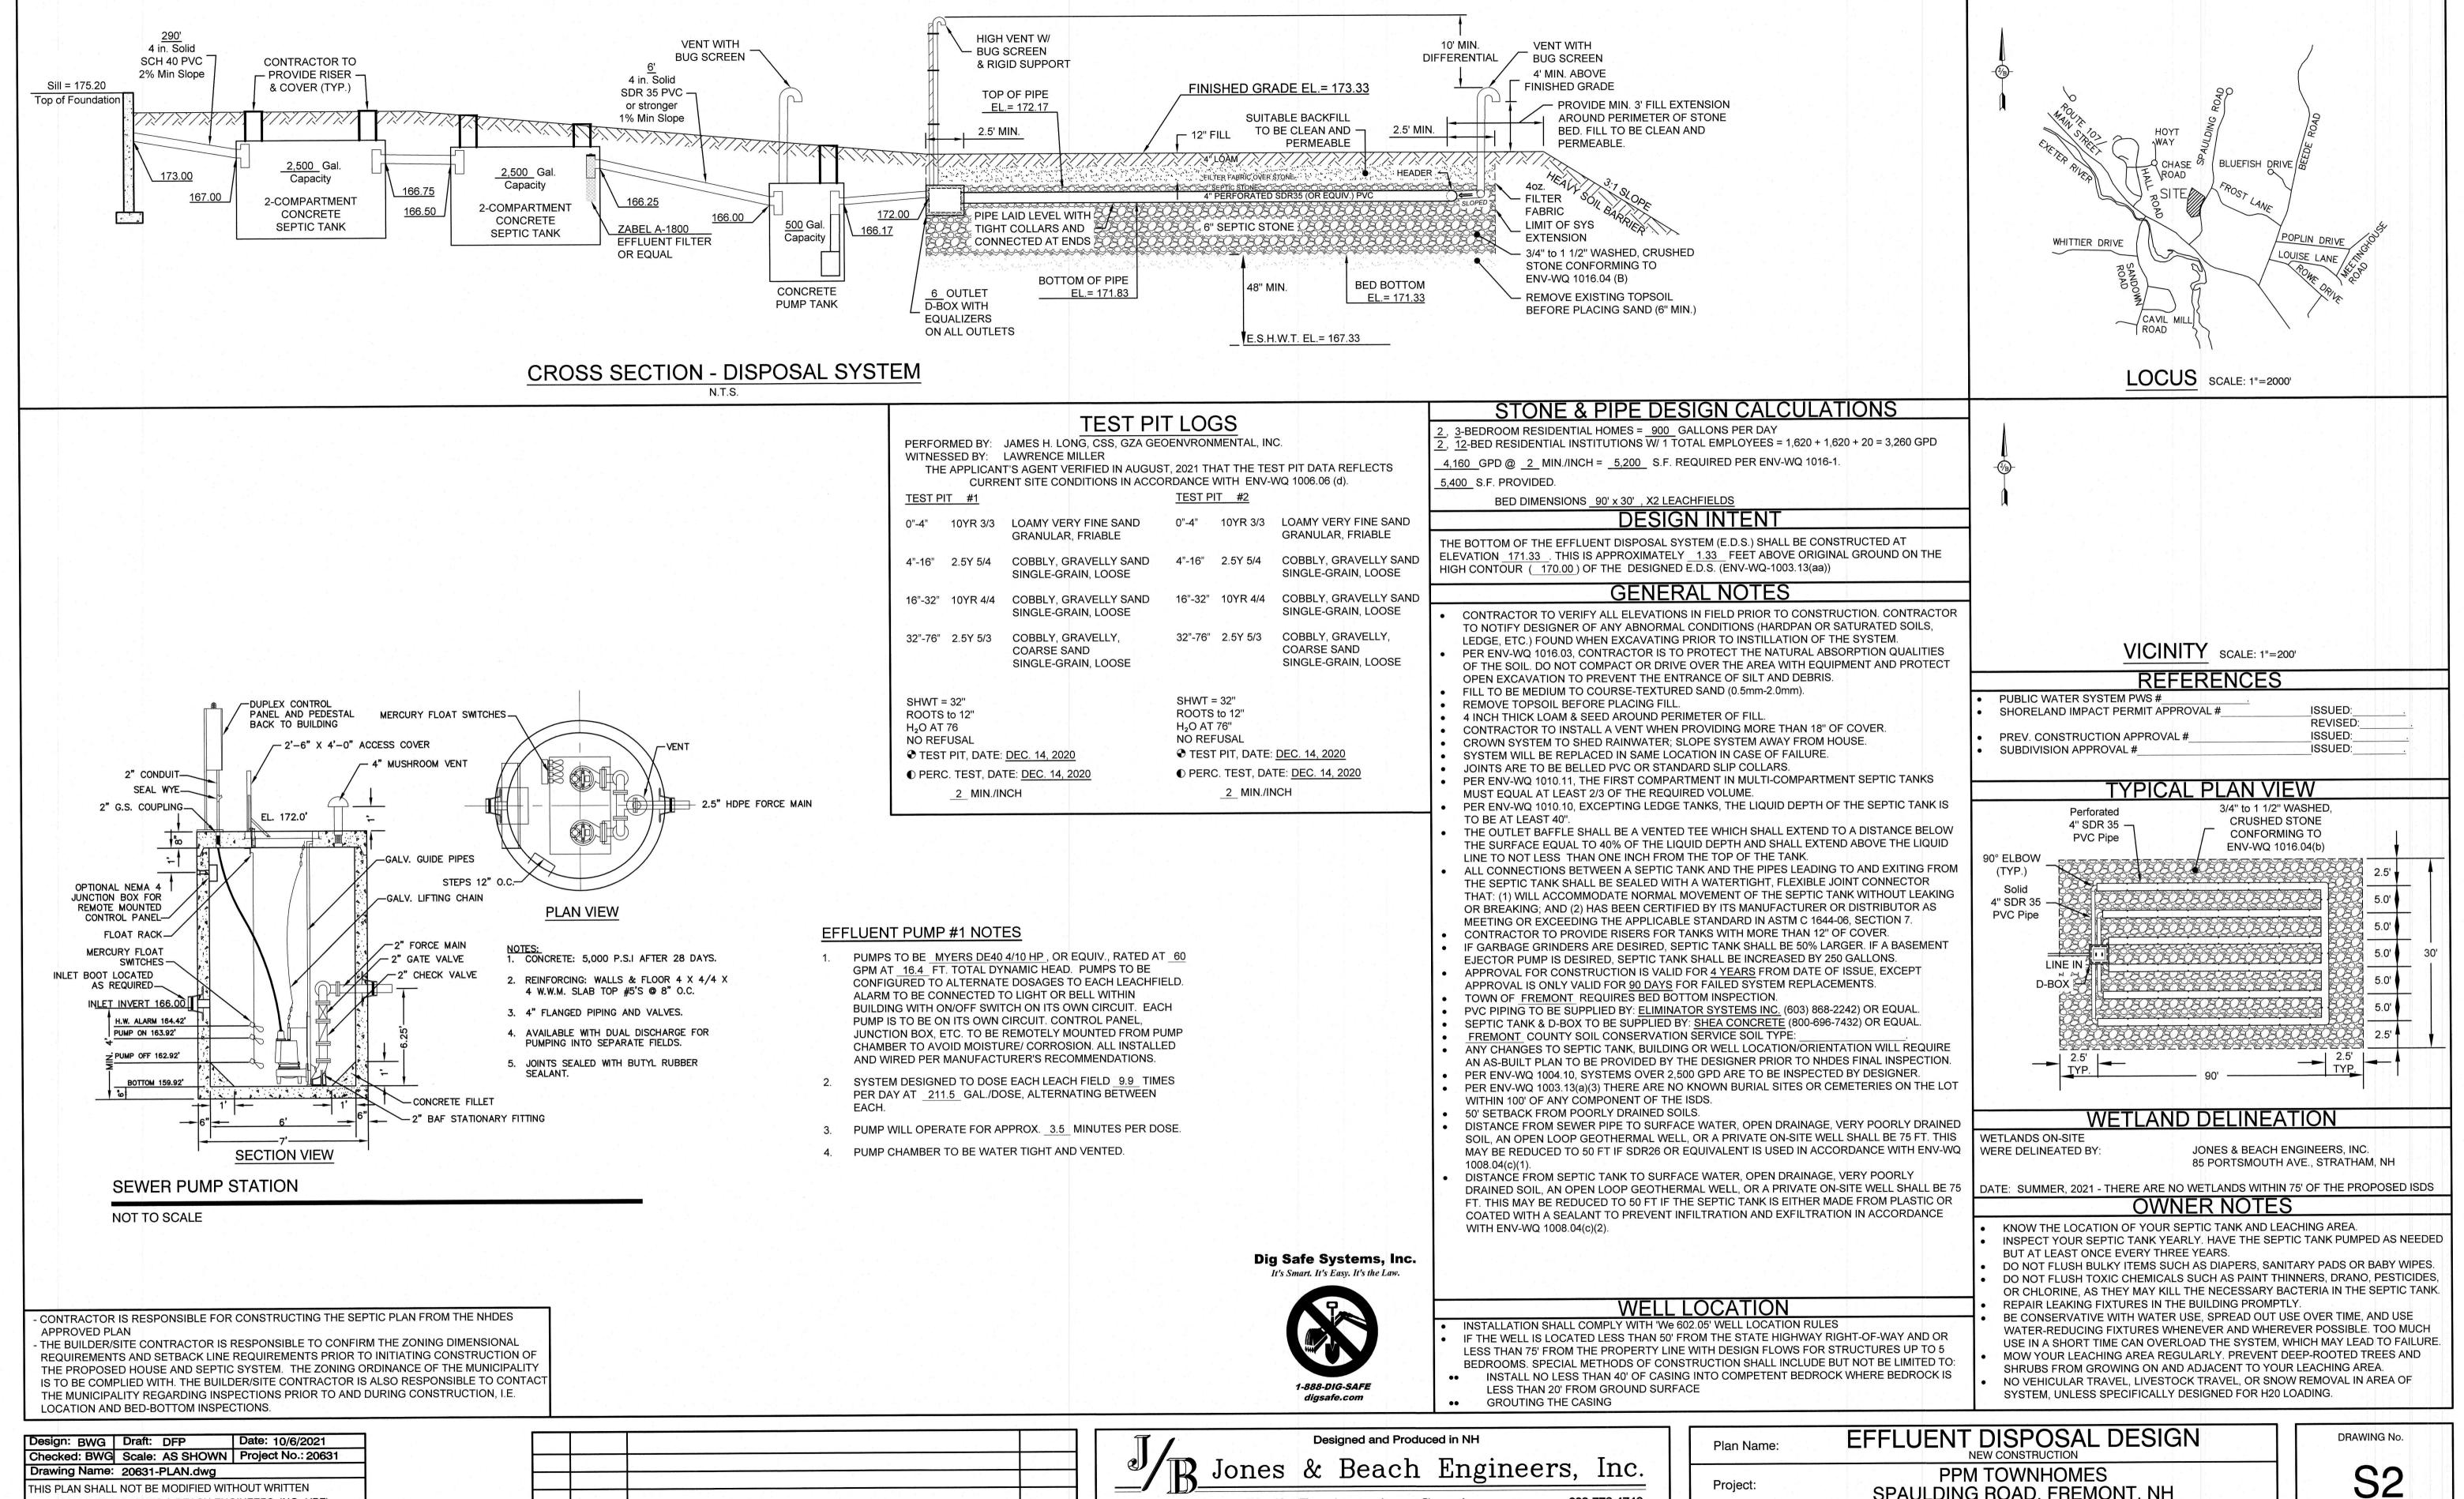

THIS PLAN SHALL NOT BE MODIFIED WITHOUT WRITTEN PERMISSION FROM JONES & BEACH ENGINEERS, INC. (JBE). ANY ALTERATIONS, AUTHORIZED OR OTHERWISE, SHALL BE AT THE USER'S SOLE RISK AND WITHOUT LIABILITY TO JBE.

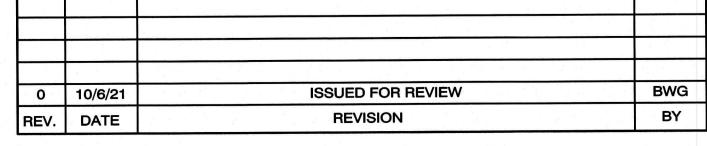


603-772-4746

85 Portsmouth Ave. Civil Engineering Services FAX: 603-772-0227 PO Box 219 E-MAIL: JBE@JONESANDBEACH.COM Stratham, NH 03885

SPAULDING ROAD, FREMONT, NH PPM FREMONT HOLDING, LLC 326 MAIN STREET FREMONT, NH 03044

Owner of Record:

SHEET 8 OF 11 JBE PROJECT NO. 20631

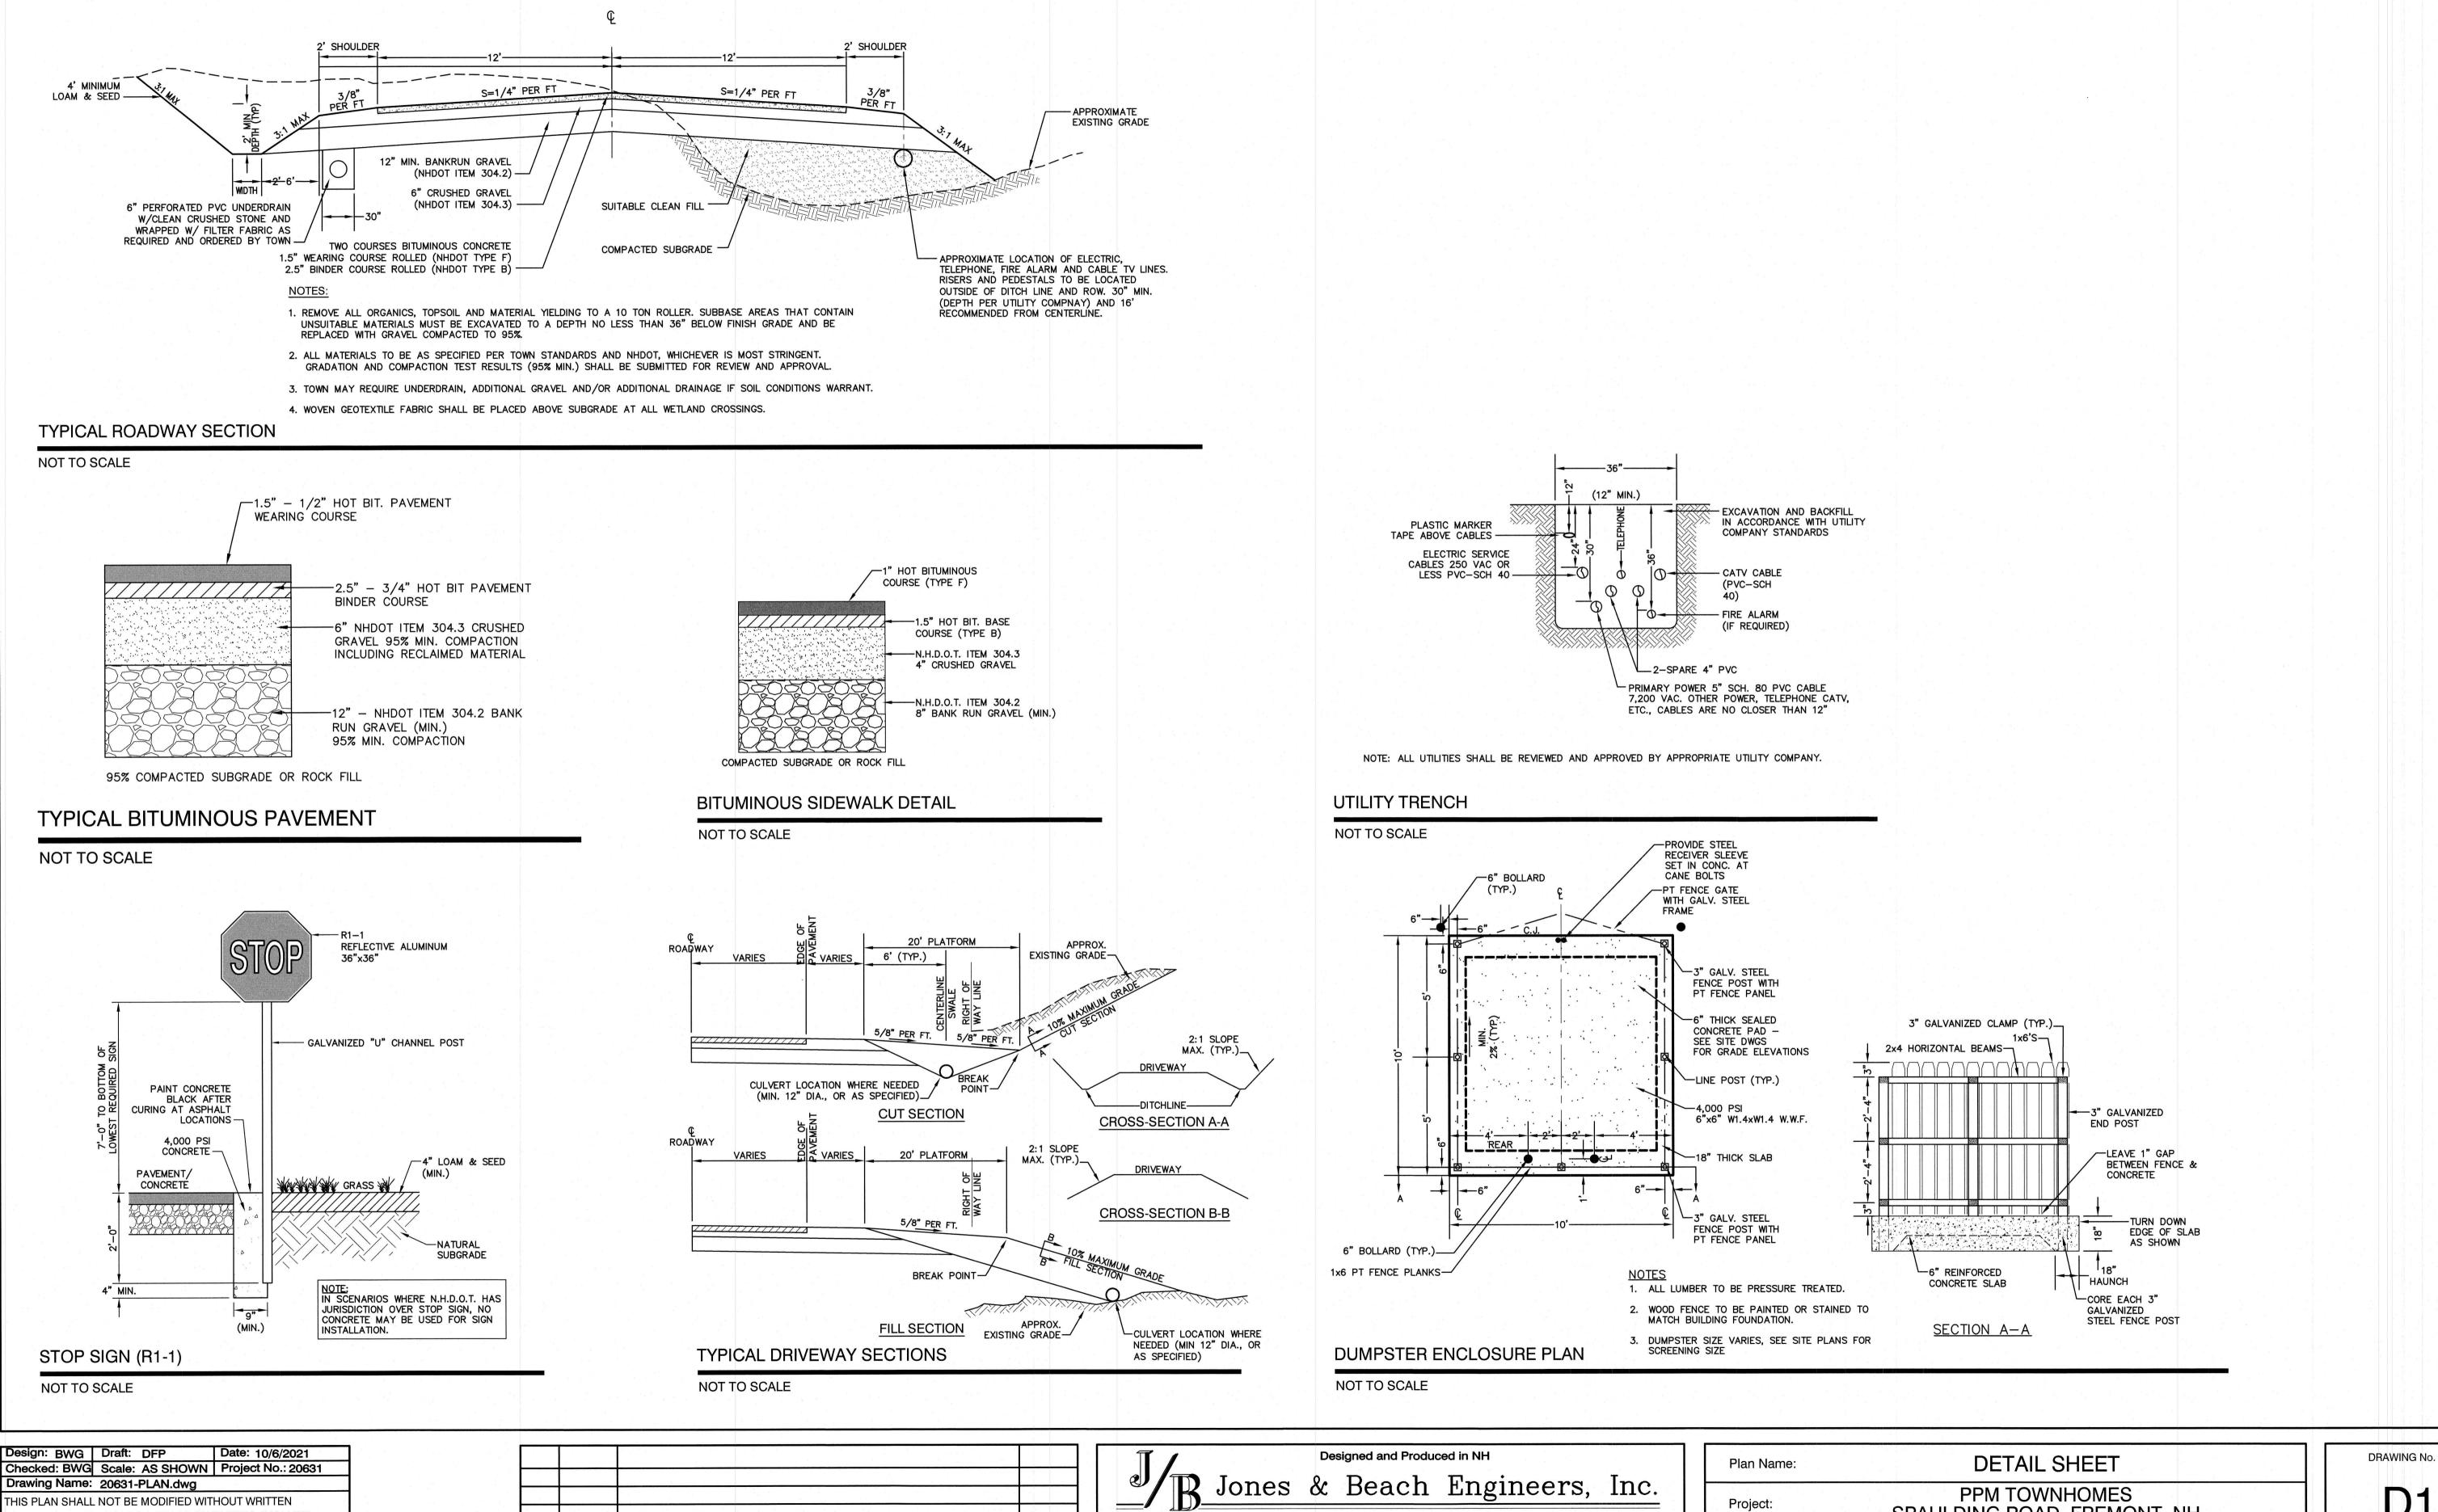

85 Portsmouth Ave. Civil Engineering Services

603-772-4746

Owner of Record:

FAX: 603-772-0227

E-MAIL: JBE@JONESANDBEACH.COM

PERMISSION FROM JONES & BEACH ENGINEERS, INC. (JBE).

ANY ALTERATIONS, AUTHORIZED OR OTHERWISE, SHALL BE

AT THE USER'S SOLE RISK AND WITHOUT LIABILITY TO JBE

10/6/21

DATE

REV.

ISSUED FOR REVIEW

REVISION

BWG

BY


PO Box 219

Stratham, NH 03885

SHEET 9 OF 11
JBE PROJECT NO. 20631

SPAULDING ROAD, FREMONT, NH

PPM FREMONT HOLDING, LLC 326 MAIN STREET FREMONT, NH 03044

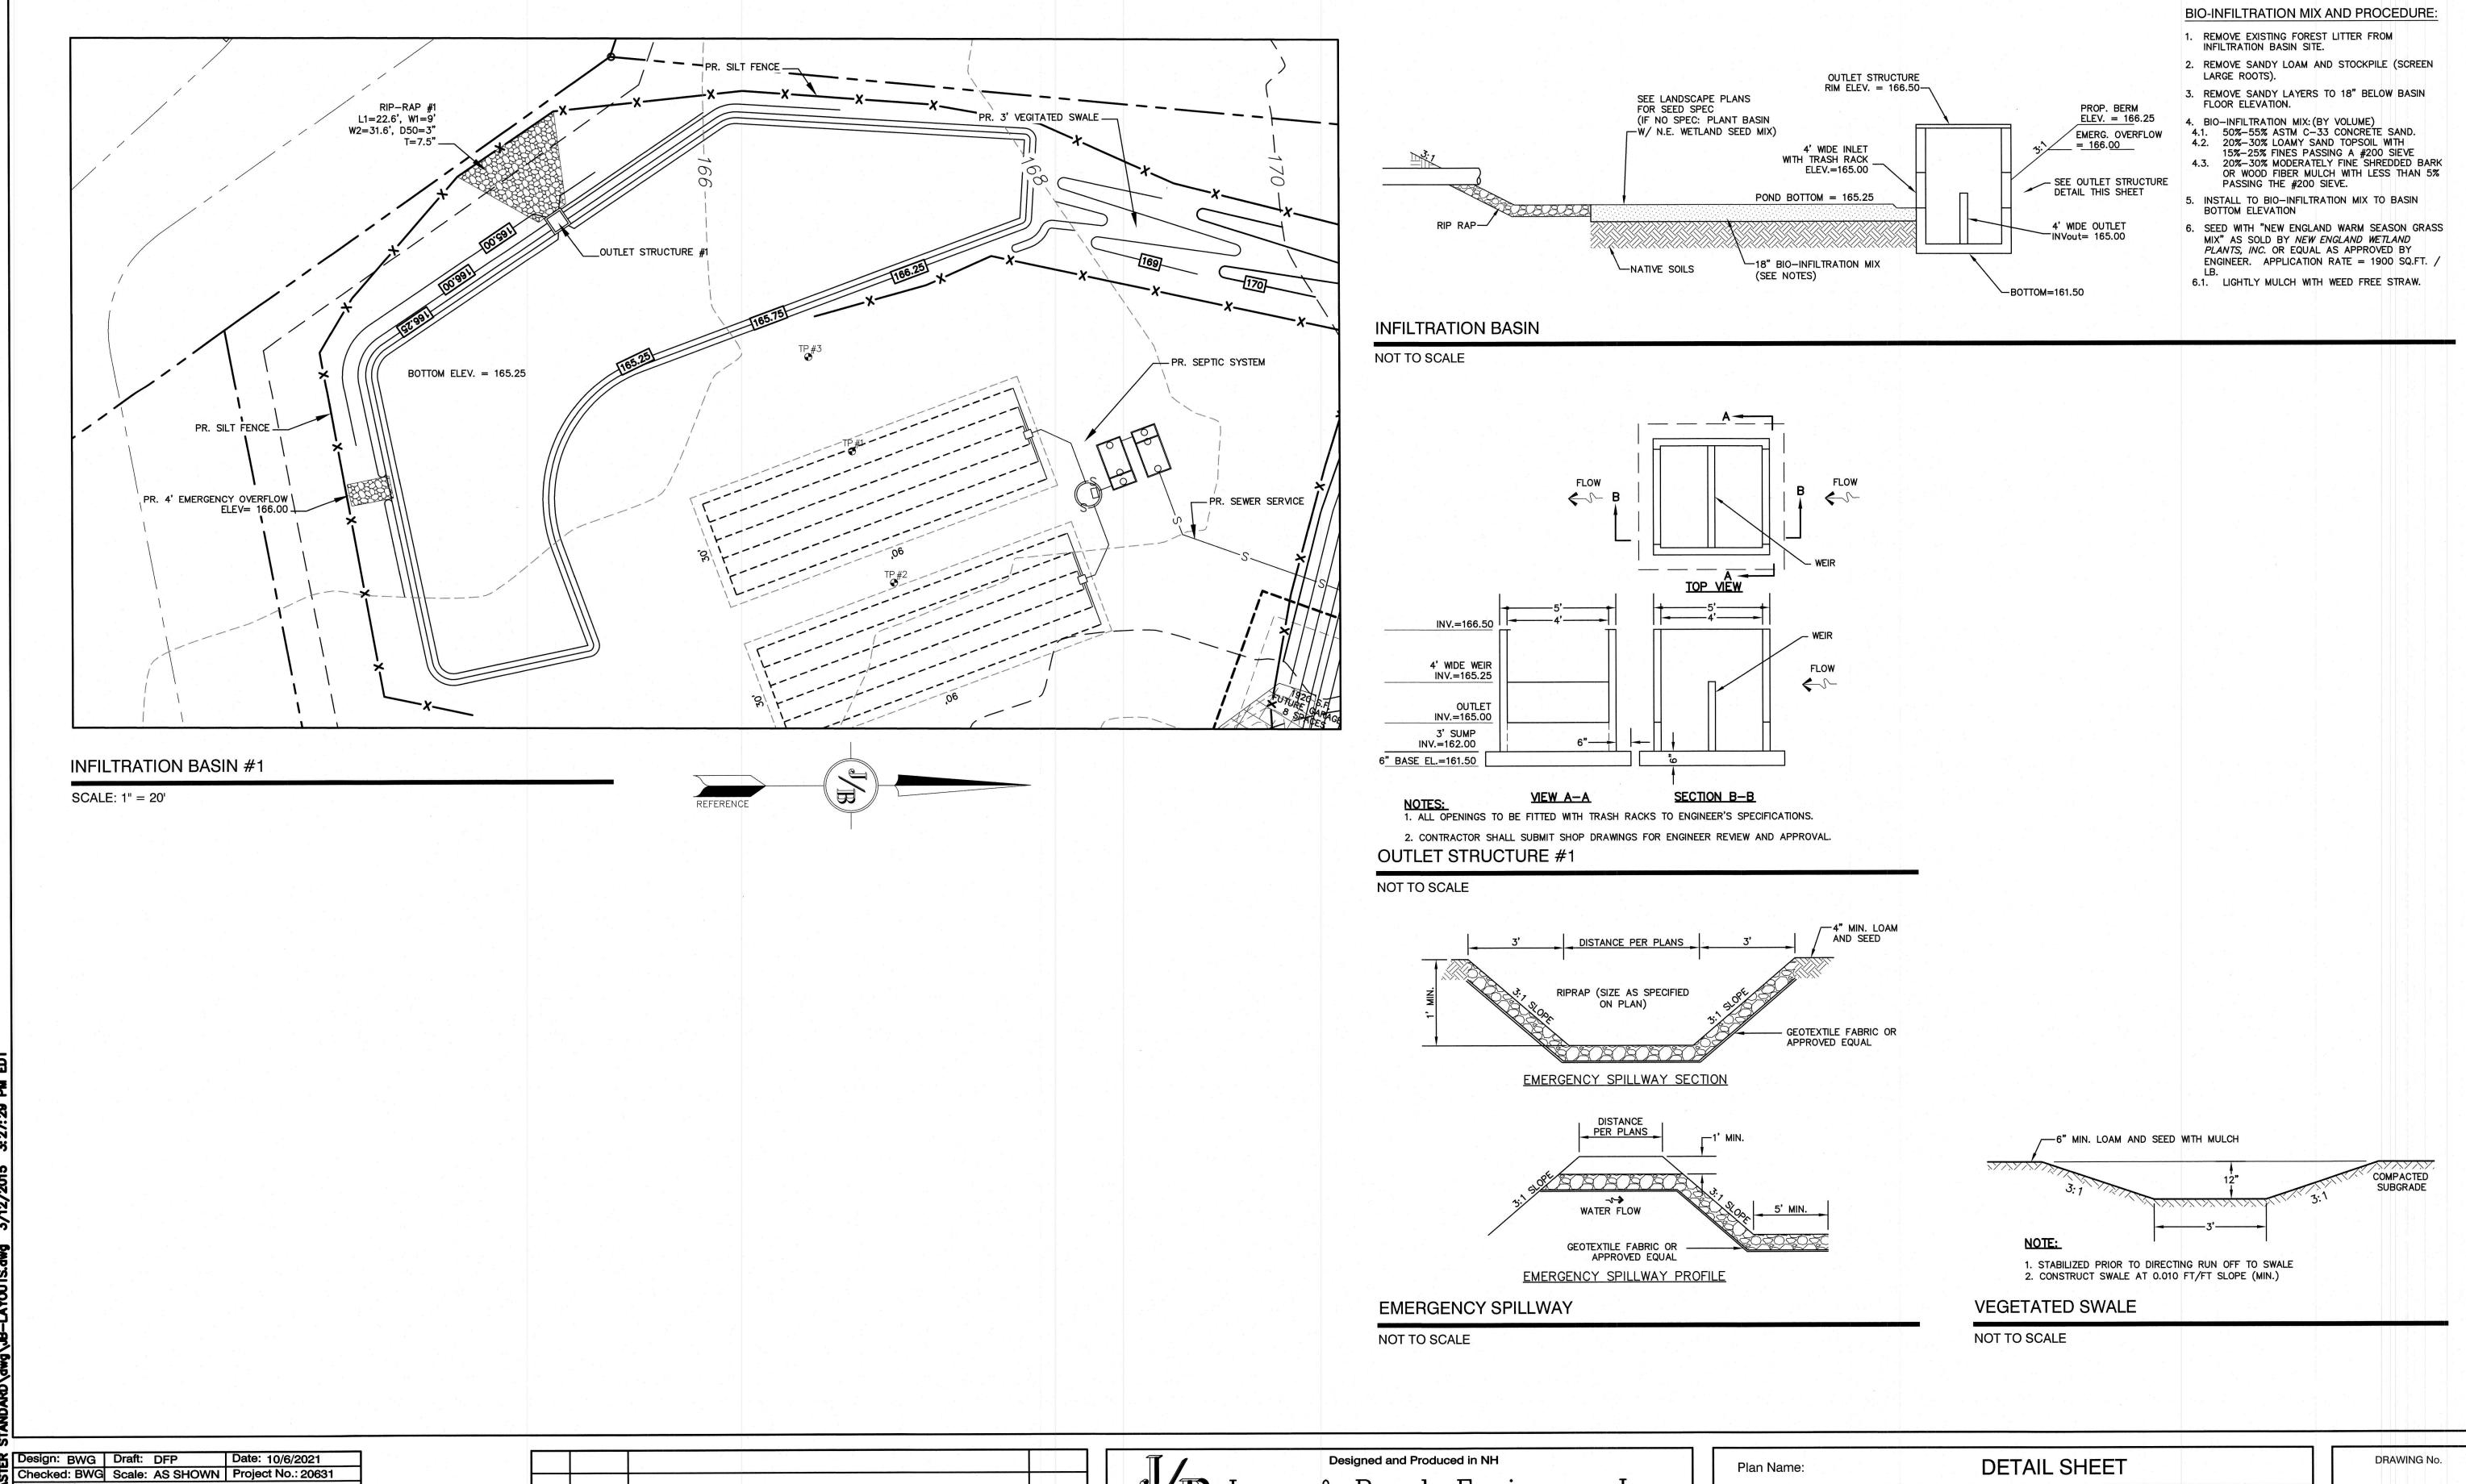

Drawing Name: 20631-PLAN.dwg

THIS PLAN SHALL NOT BE MODIFIED WITHOUT WRITTEN PERMISSION FROM JONES & BEACH ENGINEERS, INC. (JBE). ANY ALTERATIONS, AUTHORIZED OR OTHERWISE, SHALL BE AT THE USER'S SOLE RISK AND WITHOUT LIABILITY TO JBE.

0 10/6/21 ISSUED FOR REVIEW BWG
REV. DATE REVISION BY

B Jones & Beach Engineers, Inc.

85 Portsmouth Ave. Civil Engineering Services
PO Box 219
Stratham, NH 03885

Civil Engineering Services
FAX: 603-772-4746
FAX: 603-772-0227
E-MAIL: JBE@JONESANDBEACH.COM


Plan Name:	DETAIL SHEET	
Project:	PPM TOWNHOMES SPAULDING ROAD, FREMONT, NH	
Owner of Record:	PPM FREMONT HOLDING, LLC 326 MAIN STREET FREMONT, NH 03044	

D2SHEET 10 OF 11

JBE PROJECT NO. 20631

TEMPORARY EROSION CONTROL NOTES

- 1. THE SMALLEST PRACTICAL AREA OF LAND SHALL BE EXPOSED AT ANY ONE TIME. AT NO TIME SHALL AN AREA IN EXCESS OF 5 ACRES BE EXPOSED AT ANY ONE TIME BEFORE DISTURBED AREAS ARE STABILIZED.
- EROSION. SEDIMENT AND DETENTION MEASURES SHALL BE INSTALLED AS SHOWN ON THE PLANS AND AT LOCATIONS AS REQUIRED, DIRECTED BY THE ENGINEER.
- 3. ALL DISTURBED AREAS (INCLUDING POND AREAS BELOW THE PROPOSED WATERLINE) SHALL BE RETURNED TO PROPOSED GRADES AND ELEVATIONS. DISTURBED AREAS SHALL BE LOAMED WITH A MINIMUM OF 6" OF SCREENED ORGANIC LOAM AND SEEDED WITH SEED MIXTURE 'C' AT A RATE NOT LESS THAN 1.10 POUNDS OF SEED PER 1,000 S.F. OF AREA (48 LBS. / ACRE).
- SILT FENCES AND OTHER BARRIERS SHALL BE INSPECTED EVERY SEVEN CALENDAR DAYS AND WITHIN 24 HOURS OF A RAINFALL OF 0.5" OR GREATER. ALL DAMAGED AREAS SHALL BE REPAIRED, AND SEDIMENT DEPOSITS SHALL PERIODICALLY BE REMOVED
- AFTER ALL DISTURBED AREAS HAVE BEEN STABILIZED, THE TEMPORARY EROSION CONTROL MEASURES SHALL BE REMOVED AND THE AREA DISTURBED BY THE REMOVAL SMOOTHED AND RE-VEGETATED.
- AREAS MUST BE SEEDED AND MULCHED OR OTHERWISE PERMANENTLY STABILIZED WITHIN 3 DAYS OF FINAL GRADING, OR TEMPORARILY STABILIZED WITHIN 14 DAYS OF THE INITIAL DISTURBANCE OF SOIL. ALL AREAS SHALL BE STABILIZED WITHIN 45 DAYS OF INITIAL DISTURBANCE.
- ALL PROPOSED VEGETATED AREAS THAT DO NOT EXHIBIT A MINIMUM OF 85 PERCENT VEGETATIVE GROWTH BY OCTOBER 15, OR WHICH ARE DISTURBED AFTER OCTOBER 15, SHALL BE STABILIZED BY SEEDING AND INSTALLING NORTH AMERICAN GREEN S75 EROSION CONTROL BLANKETS (OR AN EQUIVALENT APPROVED IN WRITING BY THE ENGINEER) ON SLOPES GREATER THAN 3:1. AND SEEDING AND PLACING 3 TO 4 TONS OF MULCH PER ACRE, SECURED WITH ANCHORED NETTING, ELSEWHERE. THE INSTALLATION OF EROSION CONTROL BLANKETS OR MULCH AND NETTING SHALL NOT OCCUR OVER ACCUMULATED SNOW OR ON FROZEN GROUND AND SHALL BE COMPLETED IN ADVANCE OF THAW OR SPRING MELT EVENTS.
- ALL DITCHES OR SWALES WHICH DO NOT EXHIBIT A MINIMUM OF 85 PERCENT VEGETATIVE GROWTH BY OCTOBER 15, OR WHICH ARE DISTURBED AFTER OCTOBER 15, SHALL BE STABILIZED TEMPORARILY WITH STONE OR EROSION CONTROL BLANKETS APPROPRIATE FOR THE DESIGN FLOW CONDITIONS.
- AFTER OCTOBER 15th, INCOMPLETE ROAD OR PARKING SURFACES, WHERE WORK HAS STOPPED FOR THE WINTER SEASON, SHALL BE PROTECTED WITH A MINIMUM OF 3" OF CRUSHED GRAVEL PER NHDOT ITEM 304.3.
- 10. AN AREA SHALL BE CONSIDERED STABLE IF ONE OF THE FOLLOWING HAS OCCURRED:
 - a. BASE COURSE GRAVELS HAVE BEEN INSTALLED IN AREAS TO BE PAVED;
 - b. A MINIMUM OF 85% VEGETATED GROWTH HAS BEEN ESTABLISHED;
 - c. A MINIMUM OF 3" OF NON-EROSIVE MATERIAL SUCH STONE OR RIPRAP HAS BEEN INSTALLED; OR
 - d. EROSION CONTROL BLANKETS HAVE BEEN PROPERLY INSTALLED.
- 11. FUGITIVE DUST CONTROL IS REQUIRED TO BE CONTROLLED IN ACCORDANCE WITH ENV-A 1000, AND THE PROJECT IS TO MEET THE REQUIREMENTS AND INTENT OF RSA 430:53 AND AGR 3800 RELATIVE TO INVASIVE SPECIES.
- 12. PRIOR TO BEGINNING CONSTRUCTION, THE CONTRACTOR'S NAME, ADDRESS, AND PHONE NUMBER SHALL BE SUBMITTED TO DES
- 13. PRIOR TO CONSTRUCTION, A PHASING PLAN THAT DELINEATES EACH PHASE OF THE PROJECT SHALL BE SUBMITTED. ALL TEMPORARY SEDIMENT BASINS THAT WILL BE NEEDED FOR DEWATERING WORK AREAS SHALL BE LOCATED AND IDENTIFIED ON THIS
- 14. IN ORDER TO ENSURE THE STABILITY OF THE SITE AND EFFECTIVE IMPLEMENTATION OF THE SEDIMENT AND EROSION CONTROL MEASURES SPECIFIED IN THE PLANS FOR THE DURATION OF CONSTRUCTION, THE CONTRACTOR SHALL BE IN STRICT COMPLIANCE WITH THE FOLLOWING INSPECTION AND MAINTENANCE REQUIREMENTS IN ADDITION TO THOSE CALLED FOR IN THE SWPPP:
 - a. A CERTIFIED PROFESSIONAL IN EROSION AND SEDIMENT CONTROL OR A PROFESSIONAL ENGINEER LICENSED IN THE STATE OF NEW HAMPSHIRE ("MONITOR") SHALL BE EMPLOYED TO INSPECT THE SITE FROM THE START OF ALTERATION OF TERRAIN ACTIVITIES UNTIL THE SITE IS STABLE
 - b. DURING THIS PERIOD, THE MONITOR SHALL INSPECT THE SUBJECT SITE AT LEAST ONCE A WEEK, AND IF POSSIBLE, DURING ANY 1/2 INCH OR GREATER RAIN EVENT (I.E. 1/2 INCH OF PRECIPITATION OR MORE WITHIN A 24 HOUR PERIOD). IF UNABLE TO BE PRESENT DURING SUCH A STORM, THE MONITOR SHALL INSPECT THE SITE WITHIN 24 HOURS OF THIS
 - c. THE MONITOR SHALL PROVIDE TECHNICAL ASSISTANCE AND RECOMMENDATIONS TO THE CONTRACTOR ON THE APPROPRIATE BEST MANAGEMENT PRACTICES FOR EROSION AND SEDIMENT CONTROLS REQUIRED TO MEET THE REQUIREMENTS OF RSA 485 A:17 AND ALL APPLICABLE DES PERMIT CONDITIONS.

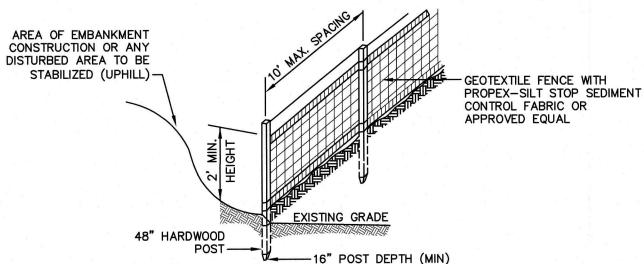

CONSTRUCTION SPECIFICATIONS:

- WOVEN FABRIC FENCE TO BE FASTENED SECURELY TO FENCE POSTS WITH WIRE TIES OR STAPLES. FILTER CLOTH SHALL BE FASTENED TO WOVEN WIRE EVERY 24" AT TOP, MID AND BOTTOM AND EMBEDDED IN THE GROUND A MINIMUM OF 8" AND THEN COVERED WITH SOIL.
- THE FENCE POSTS SHALL BE A MINIMUM OF 48" LONG, SPACED A MAXIMUM 10' APART, AND DRIVEN A MINIMUM OF 16" INTO THE GROUND.
- . WHEN TWO SECTIONS OF FILTER CLOTH ADJOIN EACH OTHER, THE ENDS OF THE FABRIC SHALL BE OVERLAPPED 6", FOLDED AND STAPLED TO PREVENT SEDIMENT FROM BY-PASSING.

. MAINTENANCE SHALL BE PERFORMED AS NEEDED AND SEDIMENT REMOVED AND PROPERLY DISPOSED OF

WHEN IT IS 6" DEEP OR VISIBLE 'BULGES' DEVELOP IN THE SILT FENCE.

Date: 10/6/2021

- 5. PLACE THE ENDS OF THE SILT FENCE UP CONTOUR TO PROVIDE FOR SEDIMENT STORAGE.
- 6. SILT FENCE SHALL REMAIN IN PLACE FOR 24 MONTHS.

Checked: BWG | Scale: AS SHOWN | Project No.: 20631

THIS PLAN SHALL NOT BE MODIFIED WITHOUT WRITTEN

PERMISSION FROM JONES & BEACH ENGINEERS, INC. (JBE).

SILT FENCE

NOT TO SCALE

Design: BWG | Draft: DFP

Drawing Name: 20631-PLAN.dwg

-MAXIMUM RECOMMENDED UNCONTROLLED SLOPE LENGTH - DISTURBED AREA (UPHILL) -CONTOUR LINES___ _____ 600' RECOMMENDED MAXIMUM FENCING IS TO RUN WITH THE CONTOURS ACROSS A SLOPE FLARE ENDS UPHILL TO PROVIDE TRAPPING CAPABILITY AND SEDIMENT STORAGE AREA

7. SILT FENCES SHALL BE REMOVED WHEN NO LONGER NEEDED AND THE SEDIMENT COLLECTED SHALL BE DISPOSED AS DIRECTED BY THE ENGINEER. THE AREA DISTURBED BY THE REMOVAL SHALL BE SMOOTHED AND REVEGETATED.

MAINTENANCE:

- 1. SILT FENCES SHALL BE INSPECTED IMMEDIATELY AFTER EACH RAINFALL AND AT LEAST DAILY DURING PROLONGED RAINFALL. ANY REPAIRS THAT ARE REQUIRED SHALL BE DONE IMMEDIATELY.
- 2. IF THE FABRIC ON A SILT FENCE SHOULD DECOMPOSE OR BECOME INEFFECTIVE DURING THE EXPECTED LIFE OF THE FENCE, THE FABRIC SHALL BE REPLACED PROMPTLY.
- 3. SEDIMENT DEPOSITS SHOULD BE INSPECTED AFTER EVERY STORM EVENT. THE DEPOSITS SHOULD BE REMOVED WHEN THEY REACH APPROXIMATELY ONE HALF THE HEIGHT OF THE BARRIER.
- 4. SEDIMENT DEPOSITS THAT ARE REMOVED, OR LEFT IN PLACE AFTER THE FABRIC HAS BEEN REMOVED, SHALL BE GRADED TO CONFORM WITH THE EXISTING TOPOGRAPHY AND VEGETATED.

SEEDING SPECIFICATIONS 1. GRADING AND SHAPING

- A. SLOPES SHALL NOT BE STEEPER THAN 2:1 WITHOUT APPROPRIATE EROSION CONTROL MEASURES AS SPECIFIED ON THE PLANS (3:1 SLOPES OR FLATTER ARE PREFERRED).
- B. WHERE MOWING WILL BE DONE, 3:1 SLOPES OR FLATTER ARE RECOMMENDED.

2. SEEDBED PREPARATION

- A. SURFACE AND SEEPAGE WATER SHOULD BE DRAINED OR DIVERTED FROM THE SITE TO PREVENT DROWNING 3. OR WINTER KILLING OF THE PLANTS.
- B. STONES LARGER THAN 4 INCHES AND TRASH SHOULD BE REMOVED BECAUSE THEY INTERFERE WITH SEEDING AND FUTURE MAINTENANCE OF THE AREA. WHERE FEASIBLE, THE SOIL SHOULD BE TILLED TO A DEPTH OF ABOUT 4 INCHES TO PREPARE A SEEDBED AND FERTILIZER AND LIME MIXED INTO THE SOIL. THE SEEDBED SHOULD BE LEFT IN A REASONABLY FIRM AND SMOOTH CONDITION. THE LAST TILLAGE OPERATION SHOULD BE PERFORMED ACROSS THE SLOPE WHEREVER PRACTICAL.

3. ESTABLISHING A STAND

ACRE OF 5-10-10.)

- A. LIME AND FERTILIZER SHOULD BE APPLIED PRIOR TO OR AT THE TIME OF SEEDING AND INCORPORATED INTO THE SOIL. TYPES AND AMOUNTS OF LIME AND FERTILIZER SHOULD BE BASED ON AN EVALUATION OF SOIL TESTS. WHEN A SOIL TEST IS NOT AVAILABLE, THE FOLLOWING MINIMUM AMOUNTS SHOULD BE
 - AGRICULTURAL LIMESTONE, 2 TONS PER ACRE OR 100 LBS. PER 1,000 SQ.FT. NITROGEN(N), 50 LBS. PER ACRE OR 1.1 LBS. PER 1,000 SQ.FT.
 - PHOSPHATE(P205), 100 LBS. PER ACRE OR 2.2 LBS. PER 1,000 SQ.FT. POTASH(K20), 100 LBS. PER ACRE OR 2.2 LBS. PER 1,000 SQ.FT. (NOTE: THIS IS THE EQUIVALENT OF 500 LBS. PER ACRE OF 10-20-20 FERTILIZER OR 1,000 LBS. PER
- B. SEED SHOULD BE SPREAD UNIFORMLY BY THE METHOD MOST APPROPRIATE FOR THE SITE. METHODS INCLUDE BROADCASTING, DRILLING AND HYDROSEEDING, WHERE BROADCASTING IS USED, COVER SEED WITH .25 INCH OF SOIL OR LESS, BY CULTIPACKING OR RAKING.
- C. REFER TO THE 'SEEDING GUIDE' AND 'SEEDING RATES' TABLES ON THIS SHEET FOR APPROPRIATE SEED MIXTURES AND RATES OF SEEDING. ALL LEGUMES (CROWNVETCH, BIRDSFOOT, TREFOIL AND FLATPEA) MUST BE INOCULATED WITH THEIR SPECIFIC INOCULANT PRIOR TO THEIR INTRODUCTION TO THE SITE.
- D. WHEN SEEDED AREAS ARE MULCHED, PLANTINGS MAY BE MADE FROM EARLY SPRING TO EARLY OCTOBER. WHEN SEEDED AREAS ARE NOT MULCHED, PLANTINGS SHOULD BE MADE FROM EARLY SPRING TO MAY 20th OR FROM AUGUST 10th TO SEPTEMBER 1st.

A. HAY, STRAW, OR OTHER MULCH, WHEN NEEDED, SHOULD BE APPLIED IMMEDIATELY AFTER SEEDING. B. MULCH WILL BE HELD IN PLACE USING APPROPRIATE TECHNIQUES FROM THE BEST MANAGEMENT PRACTICE FOR MULCHING. HAY OR STRAW MULCH SHALL BE PLACED AT A RATE OF 90 LBS PER 1000 S.F.

5. MAINTENANCE TO ESTABLISH A STAND

- A. PLANTED AREAS SHOULD BE PROTECTED FROM DAMAGE BY FIRE, GRAZING, TRAFFIC, AND DENSE WEED
- B. FERTILIZATION NEEDS SHOULD BE DETERMINED BY ONSITE INSPECTIONS. SUPPLEMENTAL FERTILIZER IS USUALLY THE KEY TO FULLY COMPLETE THE ESTABLISHMENT OF THE STAND BECAUSE MOST PERENNIALS TAKE 2 TO 3 YEARS TO BECOME FULLY ESTABLISHED.
- C. IN WATERWAYS, CHANNELS, OR SWALES WHERE UNIFORM FLOW CONDITIONS ARE ANTICIPATED, ANNUAL MOWING MAY BE NECESSARY TO CONTROL GROWTH OF WOODY VEGETATION.

USE	SEEDING MIXTURE 1/	DROUGHTY	WELL DRAINED	MODERATELY WELL DRAINED	POORLY DRAINED
STEEP CUTS AND FILLS, BORROW AND DISPOSAL	A B C	FAIR POOR POOR	GOOD GOOD GOOD	GOOD FAIR EXCELLENT	FAIR FAIR GOOD
AREAS	D	FAIR	EXCELLENT	EXCELLENT	POOR
WATERWAYS, EMERGEN SPILLWAYS, AND OTHE CHANNELS WITH FLOWING WATER.		GOOD GOOD	GOOD EXCELLENT	GOOD EXCELLENT	FAIR FAIR
LIGHTLY USED PARKING LOTS, ODD AREAS, UNUSED LANDS, AND LOW INTENSITY USE RECREATION SITES.	G A B C	GOOD GOOD GOOD	GOOD GOOD EXCELLENT	GOOD FAIR EXCELLENT	FAIR POOR FAIR
PLAY AREAS AND ATHLETIC FIELDS. (TOPSOIL IS ESSENTIAL FOR GOOD TURF.)	E F	FAIR FAIR	EXCELLENT EXCELLENT	EXCELLENT EXCELLENT	<u>2/</u> 2/

GRAVEL PIT, SEE NH-PM-24 IN APPENDIX FOR RECOMMENDATION REGARDING RECLAMATION OF SAND AND GRAVEL PITS.

/ REFER TO SEEDING MIXTURES AND RATES IN TABLE BELOW. POORLY DRAINED SOILS ARE NOT DESIRABLE FOR USE AS PLAYING AREA AND ATHLETIC FIELDS.

NOTE: TEMPORARY SEED MIX FOR STABILIZATION OF TURF SHALL BE WINTER RYE OR OATS AT A RATE OF 2.5 LBS. PER 1000 S.F. AND SHALL BE PLACED PRIOR TO OCTOBER 15th, IF PERMANENT SEEDING NOT

SEEDING GUIDE

ML	XTURE_	POUNDS PER ACRE	POUNDS PER 1.000 Sq. Ft.
A.	TALL FESCUE CREEPING RED FESCUE RED TOP TOTAL	20 20 2 42	0.45 0.45 <u>0.05</u> 0.95
В.	TALL FESCUE CREEPING RED FESCUE CROWN VETCH OR	15 10 15	0.35 0.25 0.35
	FLAT PEA TOTAL	30 40 OR 55	0.75 0.95 OR 1.35
C.	TALL FESCUE CREEPING RED FESCUE BIRDS FOOT TREFOIL TOTAL	20 20 <u>8</u> 48	0.45 0.45 <u>0.20</u> 1.10
D.	TALL FESCUE FLAT PEA TOTAL	20 30 50	0.45 <u>0.75</u> 1.20
E.	CREEPING RED FESCUE 1/ KENTUCKY BLUEGRASS 1/ TOTAL	50 50 100	1.15 1.15 2.30
F.	TALL FESCUE 1	150	3.60
NE	/ FOR HEAVY USE ATHLETIC FIELD EW HAMPSHIRE COOPERATIVE EXTE JRRENT VARIETIES AND SEEDING R	NSION TURF SPE	

CONSTRUCTION SEQUENCE

- 1. PRIOR TO THE START OF ANY ACTIVITY, IT IS THE RESPONSIBILITY OF THE SITE'S SITE DEVELOPER (OR OWNER) TO FILE A NOTICE OF INTENT (NOI) FORM WITH THE ENVIRONMENTAL PROTECTION AGENCY (EPA) IN ORDER TO GAIN COVERAGE UNDER THE NPDES GENERAL PERMIT FOR STORM WATER DISCHARGES FROM CONSTRUCTION ACTIVITIES. A PRE CONSTRUCTION MEETING IS TO BE HELD WITH ALL DEPARTMENT HEADS PRIOR TO THE START OF CONSTRUCTION.
- 2. CUT AND REMOVE TREES IN CONSTRUCTION AREA AS REQUIRED OR DIRECTED.
- INSTALL SILT FENCING, HAY BALES AND CONSTRUCTION ENTRANCES PRIOR TO THE START OF CONSTRUCTION. THESE ARE TO BE MAINTAINED UNTIL THE FINAL PAVEMENT SURFACING AND LANDSCAPING AREAS ARE ESTABLISHED.
- CLEAR, CUT, GRUB AND DISPOSE OF DEBRIS IN APPROVED FACILITIES. THIS INCLUDES ANY REQUIRED DEMOLITION OF EXISTING STRUCTURES, UTILITIES, ETC.
- CONSTRUCT AND/OR INSTALL TEMPORARY OR PERMANENT SEDIMENT AND/OR DETENTION BASIN(S) AS REQUIRED. THESE FACILITIES SHALL BE INSTALLED AND STABILIZED PRIOR TO DIRECTING RUN-OFF TO THEM.
- STRIP LOAM AND PAVEMENT, OR RECLAIM EXISTING PAVEMENT WITHIN LIMITS OF WORK PER THE RECOMMENDATIONS OF THE PROJECT ENGINEER AND STOCKPILE EXCESS MATERIAL. STABILIZE STOCKPILE AS NECESSARY.
- PERFORM PRELIMINARY SITE GRADING IN ACCORDANCE WITH THE PLANS, INCLUDING THE CONSTRUCTION OF ANY RETAINING WALLS AND SOUND WALLS.
- 8. PREPARE BUILDING PAD(S) TO ENABLE BUILDING CONSTRUCTION TO BEGIN.
- INSTALL THE SEWER AND DRAINAGE SYSTEMS FIRST, THEN ANY OTHER UTILITIES IN ACCORDANCE WITH THE PLAN AND DETAILS. ANY CONFLICTS BETWEEN UTILITIES ARE TO BE RESOLVED WITH THE INVOLVEMENT AND APPROVAL OF THE ENGINEER.
- 10. ALL SWALES AND DRAINAGE STRUCTURES ARE TO BE CONSTRUCTED AND STABILIZED PRIOR TO HAVING RUN-OFF DIRECTED TO THEM.
- 11. DAILY, OR AS REQUIRED, CONSTRUCT TEMPORARY BERMS, DRAINAGE DITCHES, CHECK DAMS, SEDIMENT TRAPS, ETC., TO PREVENT
- 12. PERFORM FINAL FINE GRADING, INCLUDING PLACEMENT OF 'SELECT' SUBGRADE MATERIALS.
- 13. PAVE ALL PARKING LOTS AND ROADWAYS WITH INITIAL 'BASE COURSE'.
- 14. PERFORM ALL REMAINING SITE CONSTRUCTION (i.e. BUILDING, CURBING, UTILITY CONNECTIONS, ETC.).

EROSION ON THE SITE AND PREVENT ANY SILTATION OF ABUTTING WATERS AND/OR PROPERTY.

- 15. LOAM AND SEED ALL DISTURBED AREAS AND INSTALL ANY REQUIRED SEDIMENT AND EROSION CONTROL FACILITIES (i.e. RIP RAP, EROSION CONTROL BLANKETS, ETC.).
- 16. FINISH PAVING ALL ROADWAYS AND PARKING AREAS WITH 'FINISH' COURSE.
- 17. ALL ROADWAYS AND PARKING LOTS SHALL BE STABILIZED WITHIN 72 HOURS OF ACHIEVING FINISHED GRADE.
- 18. ALL CUT AND FILL SLOPES SHALL BE SEEDED/LOAMED WITHIN 72 HOURS OF ACHIEVING FINISHED GRADE.
- COMPLETE PERMANENT SEEDING AND LANDSCAPING.
- 20. REMOVE TEMPORARY EROSION CONTROL MEASURES AFTER SEEDING AREAS HAVE BEEN 75%-85% ESTABLISHED AND SITE IMPROVEMENTS ARE COMPLETE. SMOOTH AND RE-VEGETATE ALL DISTURBED AREAS.
- 21. CLEAN SITE AND ALL DRAINAGE STRUCTURES, PIPES AND SUMPS OF ALL SILT AND DEBRIS.
- 22. INSTALL ALL PAINTED PAVEMENT MARKINGS AND SIGNAGE PER THE PLANS AND DETAILS.
- 23. ALL EROSION CONTROLS SHALL BE INSPECTED WEEKLY AND AFTER EVERY HALF-INCH OF RAINFALL.
- 24. UPON COMPLETION OF CONSTRUCTION, IT IS THE RESPONSIBILITY OF THE CONTRACTOR TO NOTIFY ANY RELEVANT PERMITTING AGENCIES THAT THE CONSTRUCTION HAS BEEN FINISHED IN A SATISFACTORY MANNER.

SEEDING RATES

Designed and Produced in NH

PO Box 219 Stratham, NH 03885

603-772-4746 85 Portsmouth Ave. Civil Engineering Services FAX: 603-772-0227 E-MAIL: JBE@JONESANDBEACH.COM

Plan Name: EROSION AND SEDIMENT CONTROL DETAILS

Project: PPM FREMONT HOLDING, LLC

Owner of Record:

DRAWING No.

ANY ALTERATIONS, AUTHORIZED OR OTHERWISE, SHALL BE AT THE USER'S SOLE RISK AND WITHOUT LIABILITY TO JBE.

ISSUED FOR REVIEW **BWG** 0 | 10/6/21 BY **REVISION** REV. DATE

PPM TOWNHOMES SPAULDING ROAD, FREMONT, NH

326 MAIN STREET FREMONT, NH 03044

SHEET 11 OF 11 JBE PROJECT NO. 20631

