SITE PLAN & LOT LINE ADJUSTMENT PPM TOWNHOMES

TAX MAP 3 LOT 37-3 & 37-2 SPAULDING ROAD, FREMONT, NH

SHEET INDEX

COVER SHEET CS

C1 **EXISTING CONDITIONS PLAN**

LOT LINE ADJUSTMENT

C2 OVERALL SITE PLAN

GRADING AND DRAINAGE PLAN

PLAN AND PROFILE


SEPTIC DETAIL SHEETS

LIGHTING AND LANDSCAPING PLAN

DETAIL SHEETS

DETAIL SHEETS

EROSION AND SEDIMENT CONTROL DETAILS

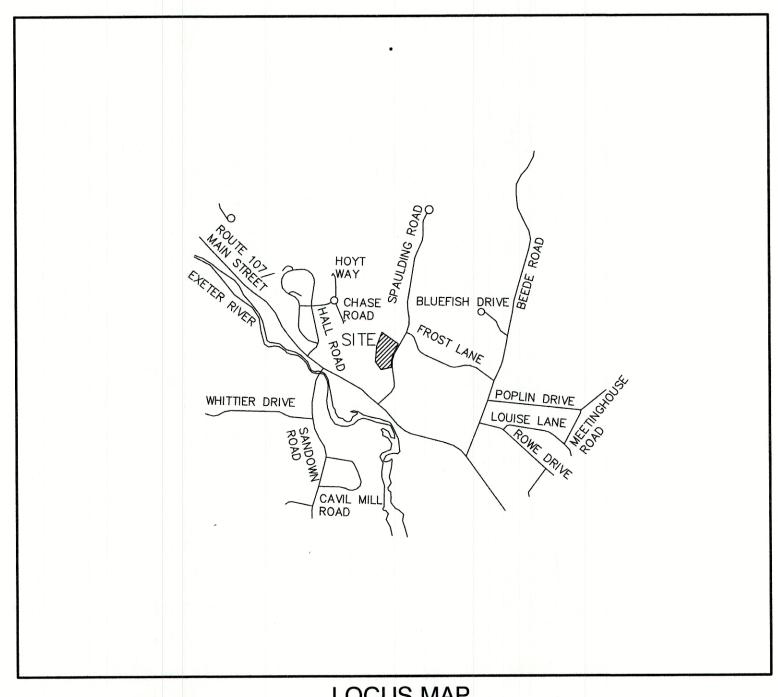

LOCUS MAP SCALE 1" = 2000'

PO Box 219

Stratham, NH 03885

APPLICANT / DEVELOPER

PPM FREMONT HOLDING, LLC 326 MAIN STREET FREMONT, NH 03044 **CONTACT: TOM NISBET**

CIVIL ENGINEER / SURVEYOR

JONES & BEACH ENGINEERS, INC. 85 PORTSMOUTH AVENUE PO BOX 219 STRATHAM, NH 03885 (603) 772-4746 **CONTACT: BARRY GIER** EMAIL: BGIER@JONESANDBEACH.COM OWNER OF RECORD PPM FREMONT HOLDING, LLC 326 MAIN STREET FREMONT, NH 03044 CONTACT: TOM NISBET

WETLAND CONSULTANT

GZA GEOENVIRONMENTAL INC. 5 COMMERCE PARK NORTH, SUITE 201 BEDFORD, NH 03110 (603) 430-9282

ELECTRIC

EVERSOURCE 740 N COMMERCIAL ST PO BOX 330 MANCHESTER, NH 03105-0330 (800) 662-7764

TELEPHONE

CONSOLIDATED COMMUNICATIONS 100 TRI CITY ROAD SOMERWORTH, NH 03878 ATTN: DAVE KESTNER (603) 743-1114

CABLE TV

COMCAST COMMUNICATION CORPORATION 334-B CALEF HIGHWAY EPPING, NH 03042-2325 (603) 679-5695

PERMITS

TYPE OF PERMIT STATUS SUBMITTED: **NEW HAMPSHIRE DEPARTMENT OF** PERMIT NO. **ENVIRONMENTAL SERVICES -**SUBSURFACE SYSTEMS BUREAU 29 HAZEN DRIVE, P.O. BOX 95 DATED: CONCORD, NEW HAMPSHIRE 03302-0095 **EXPIRATION:** RESPONSIBLE CONSULTANT: JONES & BEACH ENGINEERS, INC. NHDES INDIVIDUAL SEPTIC PERMIT **NEW HAMPSHIRE DEPARTMENT OF** PERMIT NO.

29 HAZEN DRIVE, P.O. BOX 95 DATED: CONCORD, NEW HAMPSHIRE 03302-0095 **EXPIRATION:** RESPONSIBLE CONSULTANT: JONES & BEACH ENGINEERS, INC. USEPA NPDES PHASE II CONSTRUCTION GENERAL PERMIT

NOTICE OF INTENT (NOI), AND NOTICE OF TERMINATION LOCAL REGULATIONS PRIOR TO AND FOLLOWING CONSTRUCTION: **EPA STORMWATER NOTICE PROCESSING CENTER** 1200 PENNSYLVANIA AVENUE, NW **WASHINGTON, DC 20460** RESPONSIBLE CONSULTANT: **JONES & BEACH ENGINEERS, INC.**

TYPE OF PERMIT

TOWN OF FREMONT SITE PLAN APPROVAL TOWN OF FREMONT PLANNING BOARD **295 MAIN STREET** FREMONT, NEW HAMPSHIRE 03044 (603) 895-2226 RESPONSIBLE CONSULTANT:

JONES & BEACH ENGINEERS, INC.

RESPONSIBLE CONSULTANT:

JONES & BEACH ENGINEERS, INC.

SUBMITTED: TOWN OF FREMONT DRIVEWAY PERMIT TOWN OF FREMONT PLANNING BOARD PERMIT NO. **295 MAIN STREET** FREMONT, NEW HAMPSHIRE 03044 DATED: (603) 895-2226

STATUS

SUBMITTED:

PERMIT NO.

EXPIRATION:

EXPIRATION:

DATED:

ADDITIONAL APPROVALS

SUBSURFACE SYSTEMS BUREAU

- 1. ON JUNE 3, 2021 THE TOWN OF FREEMONT PLANNING BOARD VOTED TO APPROVE A CONDITIONAL USE PERMIT TO ALLOW THE CONSTRUCTION OF ONE (1) BUILDING ON THE SITE WHICH WILL INCLUDE TWO (2) RESIDENTIAL TOWNHOUSES AND TWO (2) RESIDENTIAL BOARDING AND CARE FACILITIES CONSISTING OF A SOBER LIVING FACILITY OR "SOBER HOUSE".
- 2. ON NOVEMBER 3, 2021 THE TOWN OF FREEMONT PLANNING BOARD VOTED TO APPROVE A CONDITIONAL USE PERMIT, PER SECTION 1203.8.F(1)(D) OF THE ZONING ORDINANCE TO ALLOW A MULTI-FAMILY PROJECT IN THE AQUIFER ZONE.

PROJECT PARCEL TOWN OF FREMONT TAX MAP 3, BLOCK 37, LOT 3

APPLICANT/OWNER PPM FREMONT HOLDINGS, LLC 326 MAIN STREET, UNIT 11 FREMONT, NH 03044 BK 5059, PG 1628

> TOTAL LOT AREA 233,197 SQ. FT. 5.35 ACRES

APPROVED - FREMONT, NH PLANNING BOARD

DATE:

Design: BWG | Draft: DFP Checked: BWG Scale: AS SHOWN Project No.: 20631 Drawing Name: 20631-PLAN.dwg THIS PLAN SHALL NOT BE MODIFIED WITHOUT WRITTEN PERMISSION FROM JONES & BEACH ENGINEERS, INC. (JBE).

ANY ALTERATIONS, AUTHORIZED OR OTHERWISE, SHALL BE

AT THE USER'S SOLE RISK AND WITHOUT LIABILITY TO JBE.



-	1	11/15/21	REVISED PER PB COMMENTS	BWG
	0	10/6/21	ISSUED FOR REVIEW	BWG
	REV.	DATE	REVISION	BY

Designed and Produced in NH Jones & Beach Engineers, Inc. 603-772-4746 85 Portsmouth Ave. Civil Engineering Services


FAX: 603-772-0227

E-MAIL: JBE@JONESANDBEACH.COM

Plan Name:	COVER SHEET
Project:	PPM TOWNHOMES SPAULDING ROAD, FREMONT, NH
Owner of Record:	PPM FREMONT HOLDING, LLC 326 MAIN STREET FREMONT, NH 03044

DRAWING No. SHEET 1 OF 12 JBE PROJECT NO. 20631

PLAN REFERENCES: "HOME PASTURE OF BEEDE HEIRS" FREMONT, N.H. DATED 1965. PREPARED BY GERALD HYDE. "PROPERTY LINE SURVEY OF THE LAND OF PHILLIP E. McCULLOUGH IN FREMONT, N.H." DATED AUGUST 29, 1977. PREPARED BY DHA. R.C.R.D. 7506. "PROPERTY LINE SURVEY OF THE LAND OF FREMONT DEVELOPMENT CORP, SPAULDING & FROST." DATED DECEMBER 6, 1977. PREPARED BY DHA. R.C.R.D. 7612. "SUBDIVISION & CONSOLIDATION PLAN PREPARED FOR THE D.B.L. LAND CORPORATION, FREMONT, N.H." DATED SEPTEMBER 17, 1984. PREPARED BY RONALD BURD. R.C.R.D 13179. "ACCESS EASEMENT PLAN PREPARED FOR SPAULDING AND FROST CO, INC. FREMONT, N.H." DATED NOVEMBER 5, 1984. PREPARED BY RONALD BURD. R.C.R.D. 14242. "SUBDIVISION AND CONSOLIDATION PLAN FOR D.B.D. LAND CORPORATION AND SPAULDING & FROST CO. FREMONT, NH" DATED SEPTEMBER 23, 1988. PREPARED BY HOLDEN ENGINEERING & SURVEYING. R.C.R.D. 19115. "CONSOLIDATION & RESUBDIVISION PLAN OF THE LAND OF SPAULDING & FROST CO, FREMONT, NH" DATED OCTOBER 16, 1989. PREPARED BY HOLDEN ENGINEERING & SURVEYING. R.C.R.D. 20003. "COOPERS CORNERS, FREMONT, NEW HAMPSHIRE, LOT LINE ADJUSTMENT AND SUBDIVISION." DATED SEPTEMBER 8, 2004. PREPARED BY ERIC C. MITCHELL & ASSOC. R.C.R.D. 32580. "COOPERS CORNERS, FREMONT, N.H." DATED OCTOBER 8, 2004. PREPARED BY ERIC C. MITCHELL O. "COOPERAGE FOREST, FREMONT, N.H." DATED NOVEMBER 12, 2004. PREPARED BY ERIC C. MITCHELL & ASSOC. R.C.R.D. 32622. S18*48'52"W 220.71' (TIE) 1.5' EXPOSED PINCHED TOP MAG NAIL FND IN PAVEMENT MAG NAIL FND IN PAVEMENT

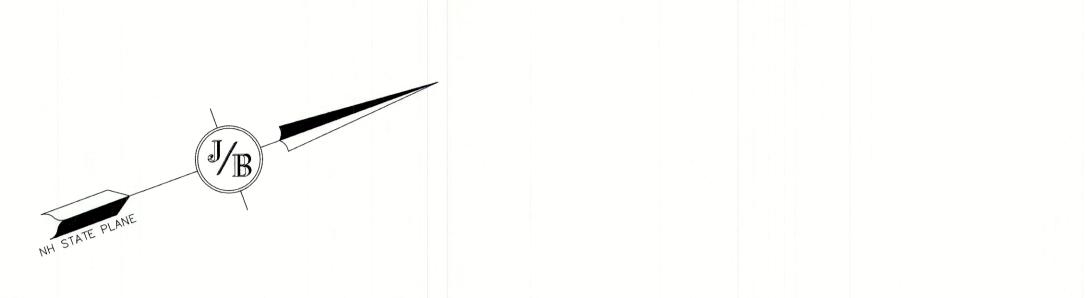

BROKEN

GRAPHIC SCALE

(IN FEET)

1 inch = 50 feet

MAP 3 LOT 37-1

PINE BUCKET, LLC

PO BOX 405

RAYMOND, NH 03077


BK 6120 PG 477

PLAN 34231


BK 5823 PG 28561

Stratham, NH 03885

CERTIFICATION: PURSUANT TO RSA 676:18-III AND RSA 672:14 I CERTIFY THAT THIS SURVEY PLAT IS NOT A SUBDIVISION PURSUANT TO THIS TITLE AND THAT THE LINES OF STREETS AND WAYS SHOWN ARE THOSE OF PUBLIC OR PRIVATE STREETS OR WAYS ALREADY ESTABLISHED AND THAT NO NEW WAYS ARE SHOWN.

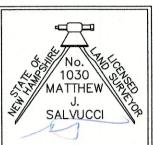


I CERTIFY THAT THIS PLAT WAS PREPARED UNDER MY DIRECT SUPERVISION, THAT IT IS THE RESULT OF A FIELD SURVEY BY THIS OFFICE AND HAS AN UNADJUSTED LINEAR ERROR OF CLOSURE THAT EXCEED BOTH THE MINIMUM OF 1:10,000 AS DEFINED IN SECTION 503.04 OF THE NEW HAMPSHIRE CODE OF ADMINISTRATIVE RULES AND THE MINIMUM OF 1:15,000 AS DEFINED IN SECTION 4.2 OF THE N.H.L.S.A. ETHICS AND STANDARDS.

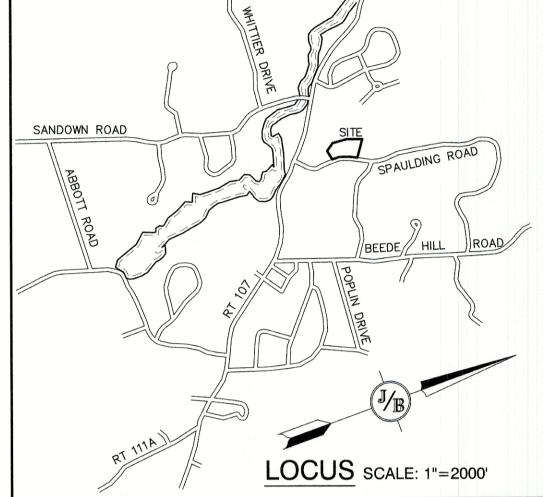

NOTES:

- 1. THE INTENT OF THIS PLAN IS TO SHOW THE EXISTING CONDITIONS OF FREMONT TAX MAP 3, LOT
- 2. ZONING DISTRICT: FLEXIBLE USE RESIDENTIAL (AQUIFER PROTECTION DISTRICT) LOT AREA MINIMUM = 2 AC. LOT FRONTAGE MINIMUM = 200' BUILDING SETBACKS (MINIMUM): FRONT SETBACK = 50' SIDE SETBACK = 30' REAR SETBACK = 30WETLAND SETBACK = 100' MAX. BUILDING HEIGHT = 35' MAX.LOT COVERAGE = 30%
- 3. THE UTILITY LOCATIONS SHOWN HEREON WERE DETERMINED BY OBSERVED ABOVE GROUND EVIDENCE AND SHOULD BE CONSIDERED APPROXIMATE IN LOCATION ONLY. LOCATION. DEPTH, SIZE, TYPE, EXISTENCE OR NONEXISTENCE OF UNDERGROUND UTILITIES AND/OR UNDERGROUND STORAGE TANKS WAS NOT VERIFIED BY THIS SURVEY. ALL CONTRACTORS SHOULD NOTIFY IN WRITING ALL UTILITY COMPANIES AND GOVERNMENT AGENCIES PRIOR TO ANY EXCAVATION WORK OR CALL DIG-SAFE AT 1-888-DIG-SAFE.
- 4. THE SUBJECT PARCEL IS NOT LOCATED WITHIN AN AREA HAVING A SPECIAL FLOOD HAZARD ZONE DESIGNATION BY THE FEDERAL EMERGENCY MANAGEMENT AGENCY. ON FLOOD INSURANCE RATE MAP NO. 33015C0360E, WITH EFFECTIVE DATE OF MAY 17, 2005.
- 5. BASIS OF BEARING: HORIZONTAL NAD88 NH STATE PLANE. VERTICAL - NAVD88.
- 6. CERTAIN DATA HEREON MAY VARY FROM RECORDED ORIENTATION, AND METHODS OF MEASUREMENT.
- 7. ALL BOOK AND PAGE NUMBERS REFER TO THE ROCKINGHAM COUNTY REGISTRY OF DEEDS.
- 8. THE TAX MAP AND LOT NUMBERS ARE BASED ON THE TOWN OF FREMONT TAX RECORDS AND ARE SUBJECT TO CHANGE.
- 9. RESEARCH WAS PERFORMED AT THE TOWN OF FREMONT ASSESSOR'S OFFICE AND THE ROCKINGHAM COUNTY REGISTRY OF DEEDS.
- 10. THIS SURVEY IS NOT A CERTIFICATION TO OWNERSHIP OR TITLE OF LANDS SHOWN. OWNERSHIP AND ENCUMBRANCES ARE MATTERS OF TITLE EXAMINATION NOT OF A BOUNDARY SURVEY. THE INTENT OF THIS PLAN IS TO RETRACE THE BOUNDARY LINES OF DEEDS REFERENCED HEREON. OWNERSHIP OF ADJOINING PROPERTIES IS ACCORDING TO ASSESSOR'S RECORDS. THIS PLAN MAY OR MAY NOT INDICATE ALL ENCUMBRANCES EXPRESSED, IMPLIED OR PRESCRIPTIVE.
- 11. NO WETLANDS WERE OBSERVED ON THE SUBJECT PREMISES.
- 12. THIS PLAN IS THE RESULT OF A CLOSED TRAVERSE WITH A RAW, UNADJUSTED LINEAR ERROR OF CLOSURE GREATER THAN 1 IN 15,000.
- 13. SURVEY TIE LINES SHOWN HEREON ARE NOT BOUNDARY LINES. THEY SHOULD ONLY BE USED TO LOCATE THE PARCEL SURVEYED FROM THE FOUND MONUMENTS SHOWN AND LOCATED BY THIS
- 14. ITALICIZED "PLAN" DISTANCES TAKEN FROM PLAN REFERENCE 8.
- 15. THE BOUNDARY LINE BETWEEN THE SUBJECT PROPERTY, AND MAP 3 LOT 36, IS SHOWN AS A STRAIGHT LINE, PER PLAN REFERENCES 1, 2, AND 6. PLAN REFERENCES 4, 5, AND 8 DO NOT FOLLOW THIS SAME LINE. A POSSIBLE GAP IN TITLE MAY EXIST BETWEEN PLANS OF RECORD. ANY USE OF THIS PLAN AND OR ACCOMPANYING DESCRIPTIONS SHOULD BE DONE WITH LEGAL COUNSEL, TO BE CERTAIN THAT TITLES ARE CLEAR. THAT INFORMATION IS CURRENT, AND THAT ANY NECESSARY CERTIFICATES ARE IN PLACE FOR A PARTICULAR CONVEYANCE, OR OTHER USES.

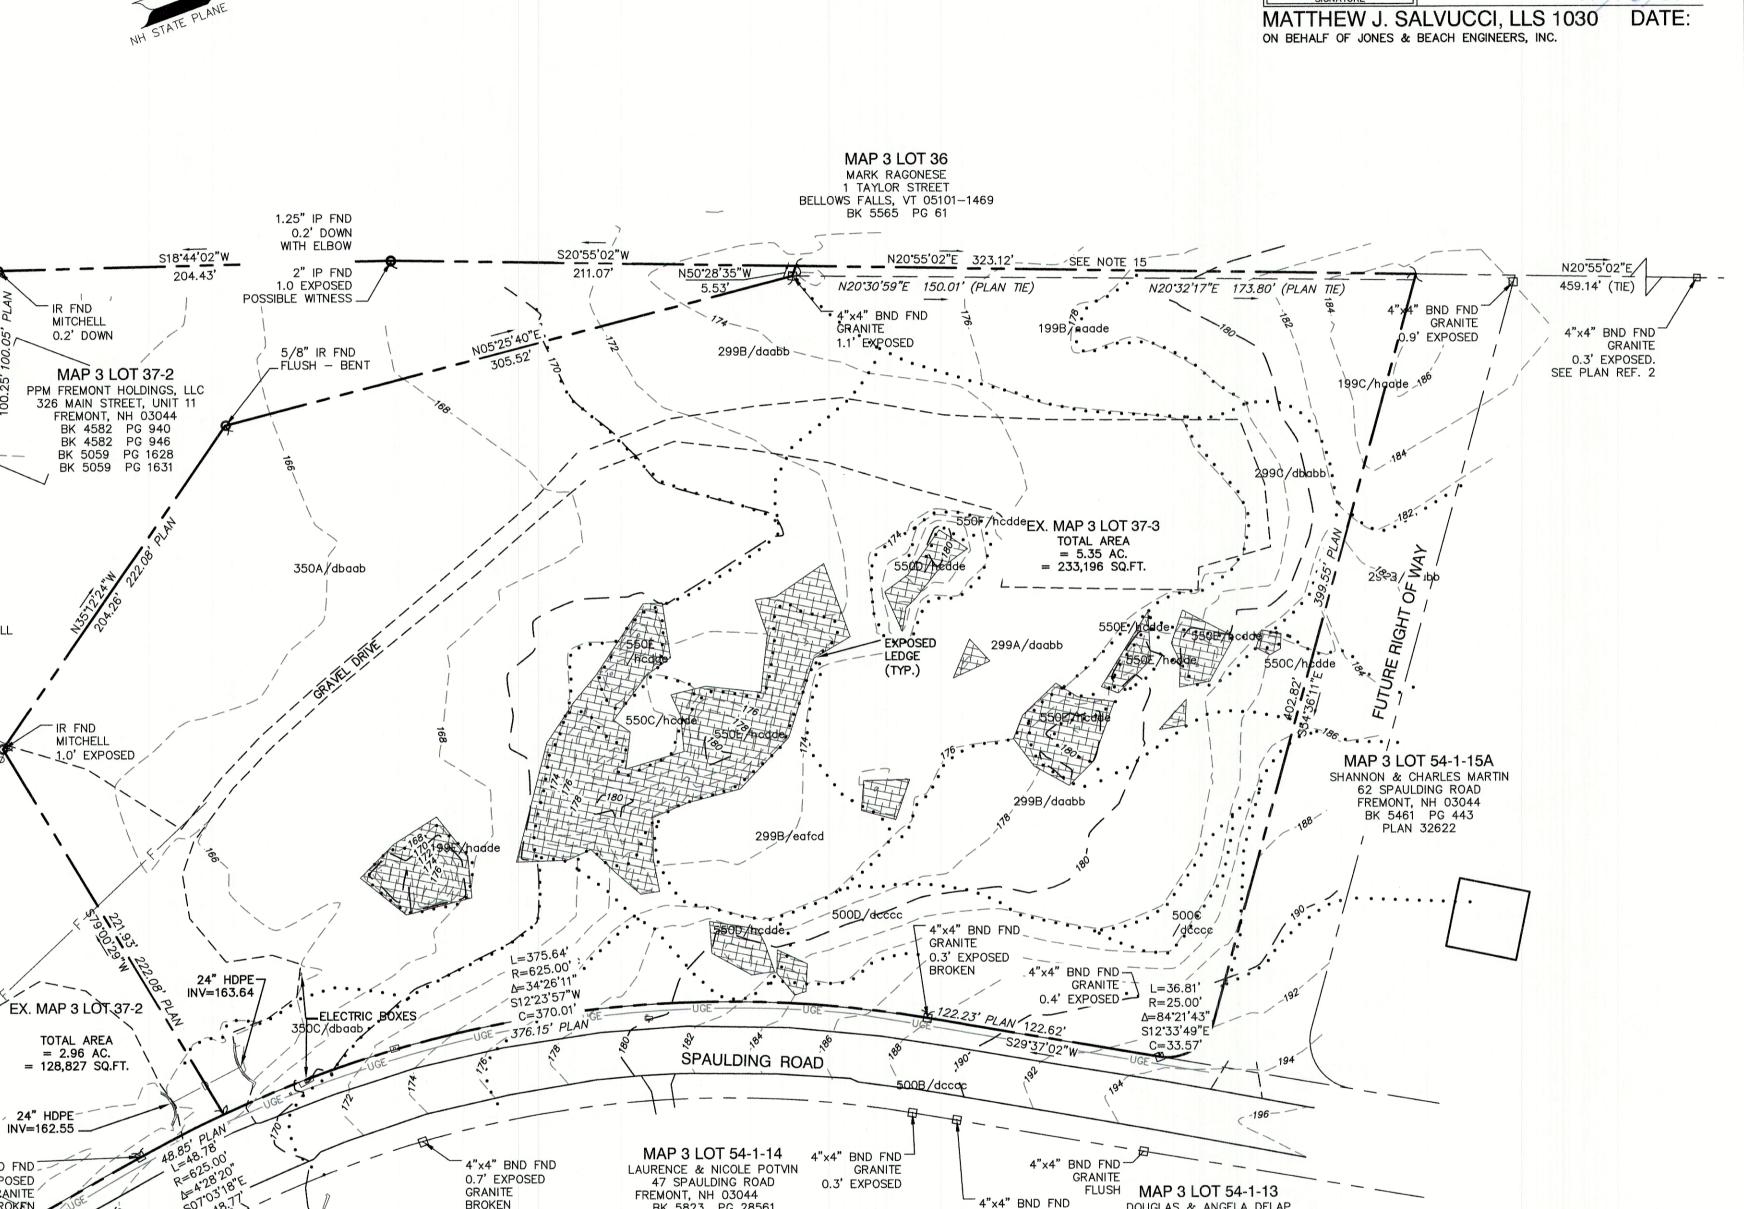

199B/haade 199C/haade 199E/haade FILL MATERIAL FILL MATERIAL FILL MATERIAL UDORTHENTS 299A/daabb 299B/daabb 299B/dbabb UDORTHENTS UDORTHENTS **UDORTHENTS**

SITE SPECIFIC SOIL TABLE:

299C/dbaab 350A/dbaab 350C/dbaab UDIPSAMMENTS UDIPSAMMENTS UDORTHENTS **UDORTHENTS** UDORTHENTS UDORTHENTS UDORTHENTS

Design: BWG Draft: DFP Checked: BWG Scale: AS SHOWN | Project No.: 20631 Drawing Name: 20631-PLAN.dwg THIS PLAN SHALL NOT BE MODIFIED WITHOUT WRITTEN

PERMISSION FROM JONES & BEACH ENGINEERS, INC. (JBE).

ANY ALTERATIONS, AUTHORIZED OR OTHERWISE, SHALL BE

AT THE USER'S SOLE RISK AND WITHOUT LIABILITY TO JBE.

IR FND

MAP 3 LOT 37

COOPERS CORNER LLC 19 QUIMBY COURT

DANVILLE, NH 03819

0.5' DOWN

DISTURBED

1	11/15/21	REVISED PER PB COMMENTS	BWG
0	10/6/21	ISSUED FOR REVIEW	BWG
REV.	DATE	REVISION	BY

4"x4" BND FND

0.9' EXPOSED

GRANITE

IR FND

MITCHELL

0.4' EXPOSED

GRANITE

BROKEN

FLUSH

MITCHELL

0.2' DOWN

CHAIN LINK FENCE -

18" HDPE

-INV=156.39

RIRE SPRINKLER LINE

18" HDPE

INV=155.33

4"x4" BND FND

TOP BROKEN OFF

4"x4" BND FND

0.7' EXPOSED

GRANITE

GRANITE

1.0' DOWN

Designed and Produced in NH Jones & Beach Engineers, Inc. 603-772-4746 85 Portsmouth Ave. Civil Engineering Services FAX: 603-772-0227 PO Box 219

GRANITE

LEANING

0.4' EXPOSED

DOUGLAS & ANGELA DELAP

7 FROST LANE

FREMONT, NH 03044

BK 5021 PG 1280

E-MAIL: JBE@JONESANDBEACH.COM


Project:

EXISTING CONDITIONS PLAN Plan Name: PPM TOWNHOMES

PPM FREMONT HOLDING, LLC Owner of Record: 326 MAIN STREET FREMONT, NH 03044 DRAWING No. SHEET 2 OF 12

JBE PROJECT NO. 20631

SPAULDING ROAD, FREMONT, NH

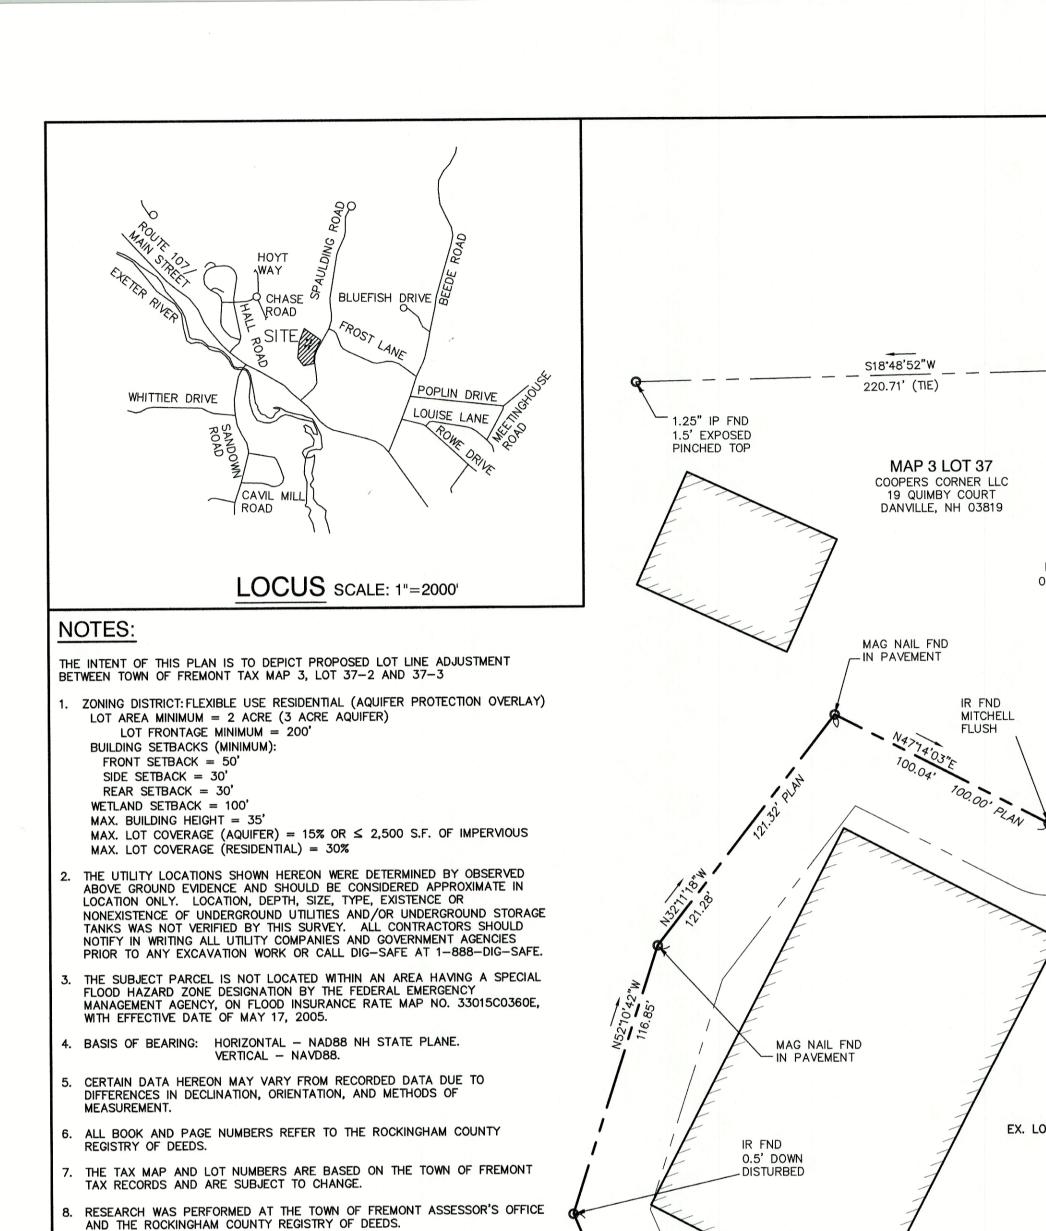

THIS SURVEY IS NOT A CERTIFICATION TO OWNERSHIP OR TITLE OF LANDS SHOWN. OWNERSHIP AND ENCUMBRANCES ARE MATTERS OF TITLE EXAMINATION NOT OF A BOUNDARY SURVEY. THE INTENT OF THIS PLAN IS TO RETRACE THE BOUNDARY LINES OF DEEDS REFERENCED HEREON. OWNERSHIP OF ADJOINING PROPERTIES IS ACCORDING TO ASSESSOR'S RECORDS. THIS PLAN MAY OR MAY NOT INDICATE ALL ENCUMBRANCES

10. ANY USE OF THIS PLAN AND OR ACCOMPANYING DESCRIPTIONS SHOULD BE DONE WITH LEGAL COUNSEL, TO BE CERTAIN THAT TITLES ARE CLEAR, THAT INFORMATION IS CURRENT, AND THAT ANY NECESSARY CERTIFICATES ARE IN PLACE FOR A PARTICULAR CONVEYANCE, OR OTHER USES.

1. NO WETLANDS WERE OBSERVED ON THE SUBJECT PREMISES.

EXPRESSED, IMPLIED OR PRESCRIPTIVE.

12. THIS PLAN IS THE RESULT OF A CLOSED TRAVERSE WITH A RAW, UNADJUSTED LINEAR ERROR OF CLOSURE GREATER THAN 1 IN 15,000.

13. SURVEY TIE LINES SHOWN HEREON ARE NOT BOUNDARY LINES. THEY SHOULD ONLY BE USED TO LOCATE THE PARCEL SURVEYED FROM THE FOUND MONUMENTS SHOWN AND LOCATED BY THIS SURVEY.

PLAN REFERENCES:

"HOME PASTURE OF BEEDE HEIRS" FREMONT, N.H. DATED 1965. PREPARED BY GERALD HYDE. R.C.R.D 833.

"PROPERTY LINE SURVEY OF THE LAND OF PHILLIP E. McCULLOUGH IN FREMONT, N.H." DATED AUGUST 29, 1977. PREPARED BY DHA. R.C.R.D. 7506.

"PROPERTY LINE SURVEY OF THE LAND OF FREMONT DEVELOPMENT CORP, SPAULDING & FROST." DATED DECEMBER 6, 1977. PREPARED BY DHA. R.C.R.D. 7612. "SUBDIVISION & CONSOLIDATION PLAN PREPARED FOR THE D.B.L. LAND CORPORATION, FREMONT, N.H." DATED SEPTEMBER 17, 1984. PREPARED BY RONALD BURD. R.C.R.D.

"ACCESS EASEMENT PLAN PREPARED FOR SPAULDING AND FROST CO, INC. FREMONT, N.H." DATED NOVEMBER 5, 1984. PREPARED BY RONALD BURD. R.C.R.D. 14242. "SUBDIVISION AND CONSOLIDATION PLAN FOR D.B.D. LAND CORPORATION AND SPAULDING & FROST CO. FREMONT, NH" DATED SEPTEMBER 23, 1988. PREPARED BY HOLDEN

ENGINEERING & SURVEYING. R.C.R.D. 19115. "CONSOLIDATION & RESUBDIVISION PLAN OF THE LAND OF SPAULDING & FROST CO, FREMONT, NH" DATED OCTOBER 16, 1989. PREPARED BY HOLDEN ENGINEERING &


SURVEYING. R.C.R.D. 20003. "COOPERS CORNERS, FREMONT, NEW HAMPSHIRE, LOT LINE ADJUSTMENT AND SUBDIVISION." DATED SEPTEMBER 8, 2004. PREPARED BY ERIC C. MITCHELL & ASSOC. R.C.R.D. 32580.

"COOPERS CORNERS, FREMONT, N.H." DATED OCTOBER 8, 2004. PREPARED BY ERIC C. MITCHELL & ASSOC. R.C.R.D. 32621. O. "COOPERAGE FOREST, FREMONT, N.H." DATED NOVEMBER 12, 2004. PREPARED BY

Date: 11/15/2021

Design: BWG Draft: DFP Checked: BWG Scale: AS SHOWN Project No.: 20631 Drawing Name: 20631-CONCEPT3.dwg THIS PLAN SHALL NOT BE MODIFIED WITHOUT WRITTEN PERMISSION FROM JONES & BEACH ENGINEERS, INC. (JBE). ANY ALTERATIONS, AUTHORIZED OR OTHERWISE, SHALL BE AT THE USER'S SOLE RISK AND WITHOUT LIABILITY TO JBE.

ERIC C. MITCHELL & ASSOC. R.C.R.D. 32622.

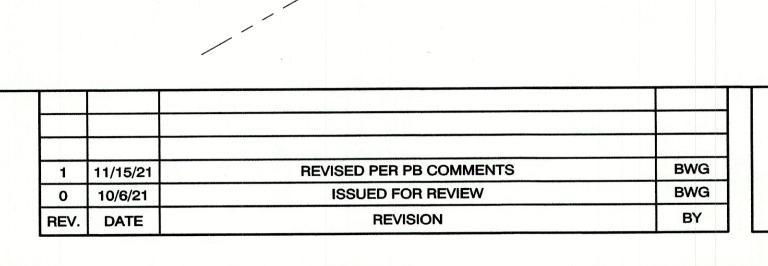





85 Portsmouth Ave. Civil Engineering Services FAX: 603-772-0227 PO Box 219 E-MAIL: JBE@JONESANDBEACH.COM Stratham, NH 03885

LOT LINE ADJUSTMENT Plan Name: PPM TOWNHOMES

Project: SPAULDING ROAD, FREMONT, NH PPM FREMONT HOLDING, LLC Owner of Record: 326 MAIN STREET FREMONT, NH 03044

SHEET 3 OF 12 JBE PROJECT NO. 20631

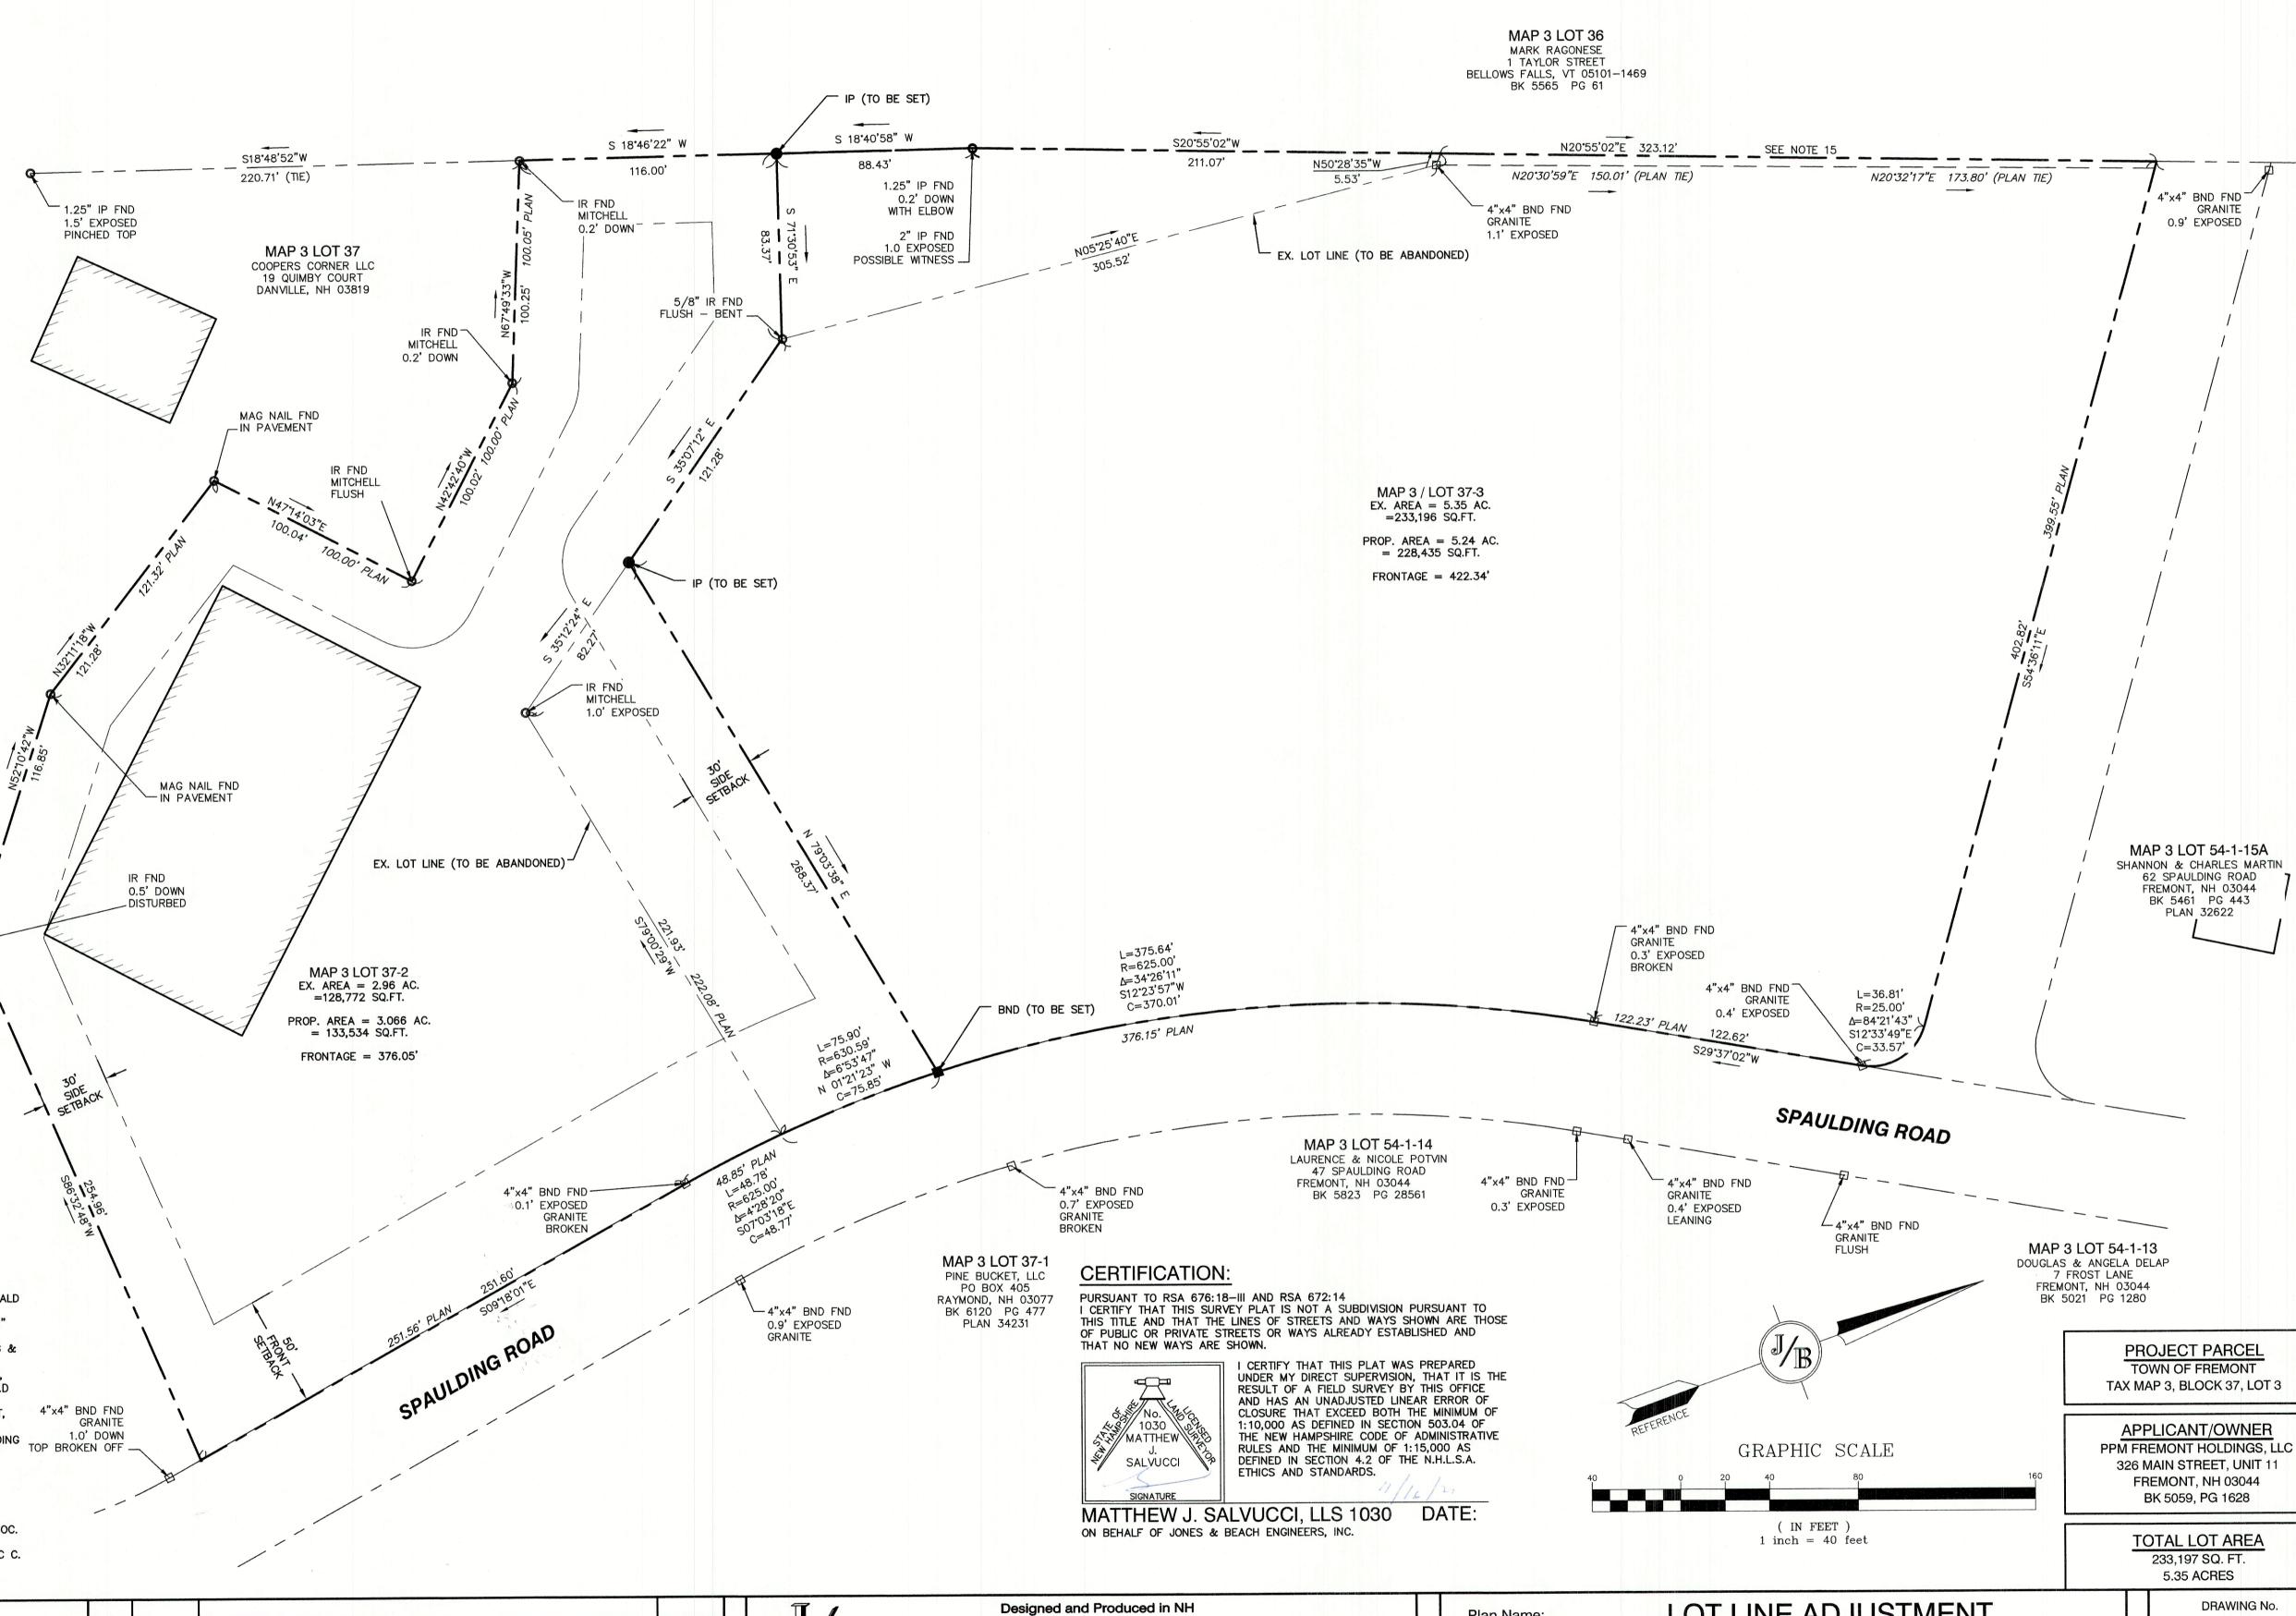

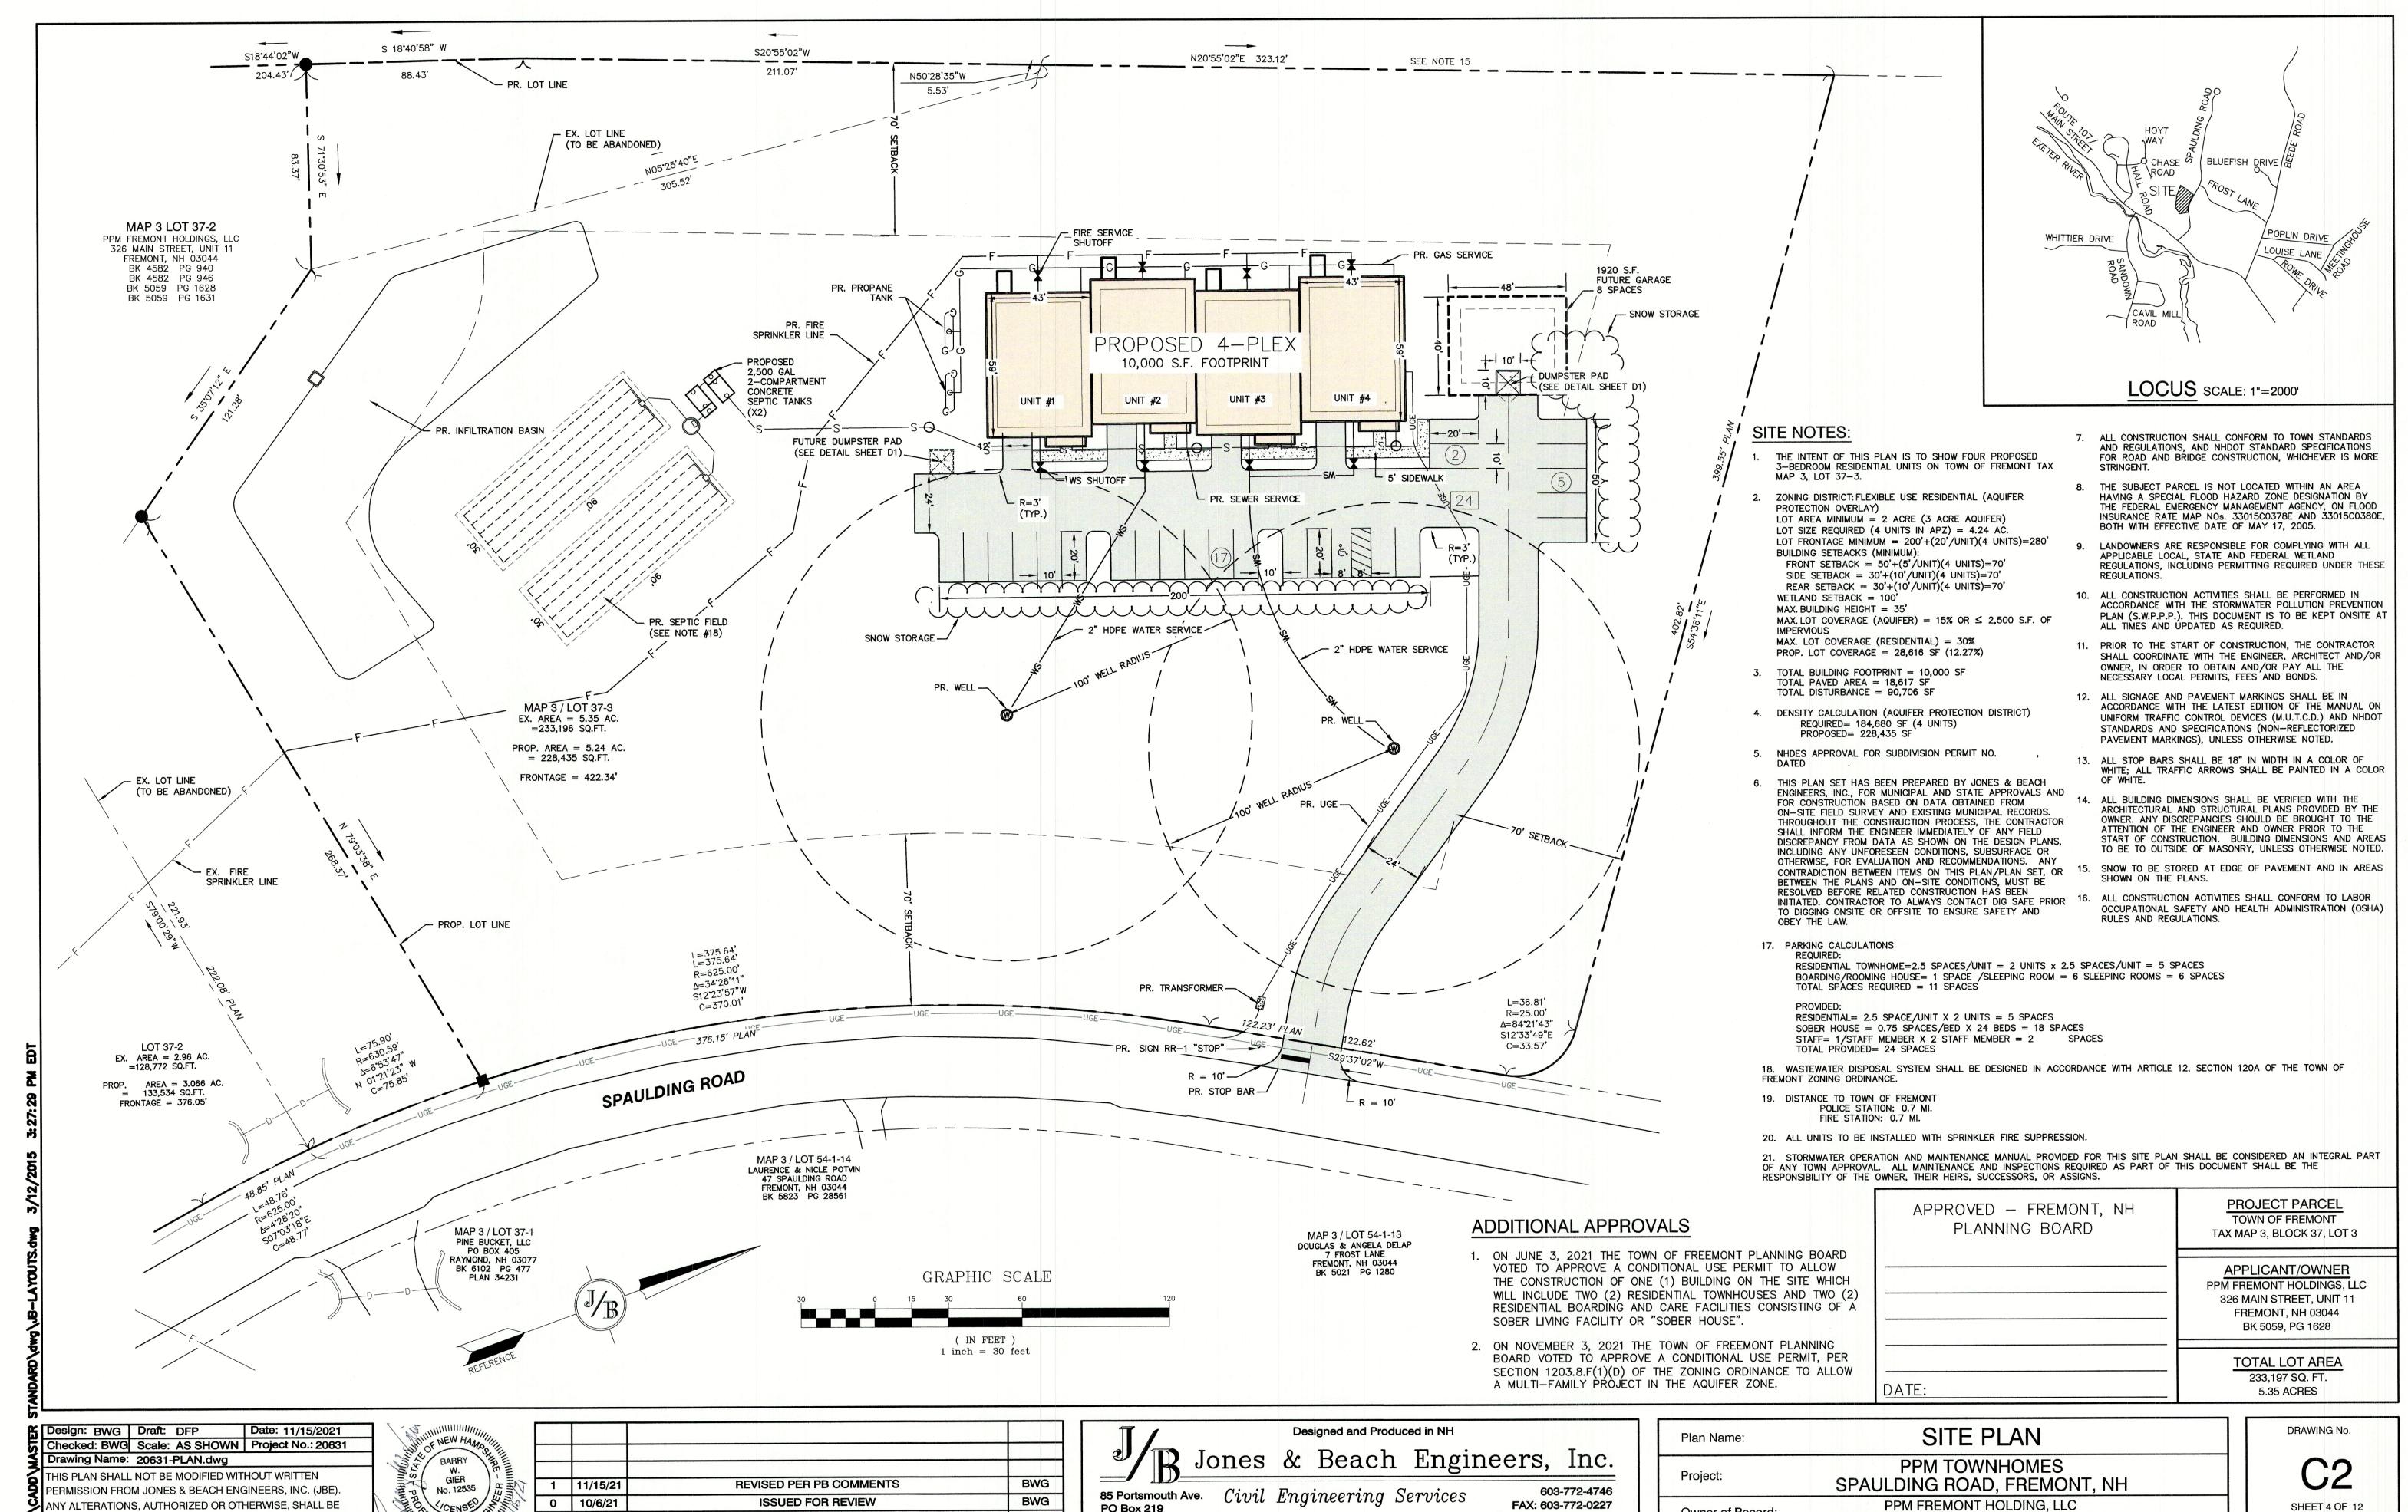

PO Box 219

Stratham, NH 03885

REVISION

REV. DATE


AT THE USER'S SOLE RISK AND WITHOUT LIABILITY TO JBE.

Owner of Record:

326 MAIN STREET FREMONT, NH 03044

E-MAIL: JBE@JONESANDBEACH.COM

SHEET 4 OF 12 JBE PROJECT NO. 20631

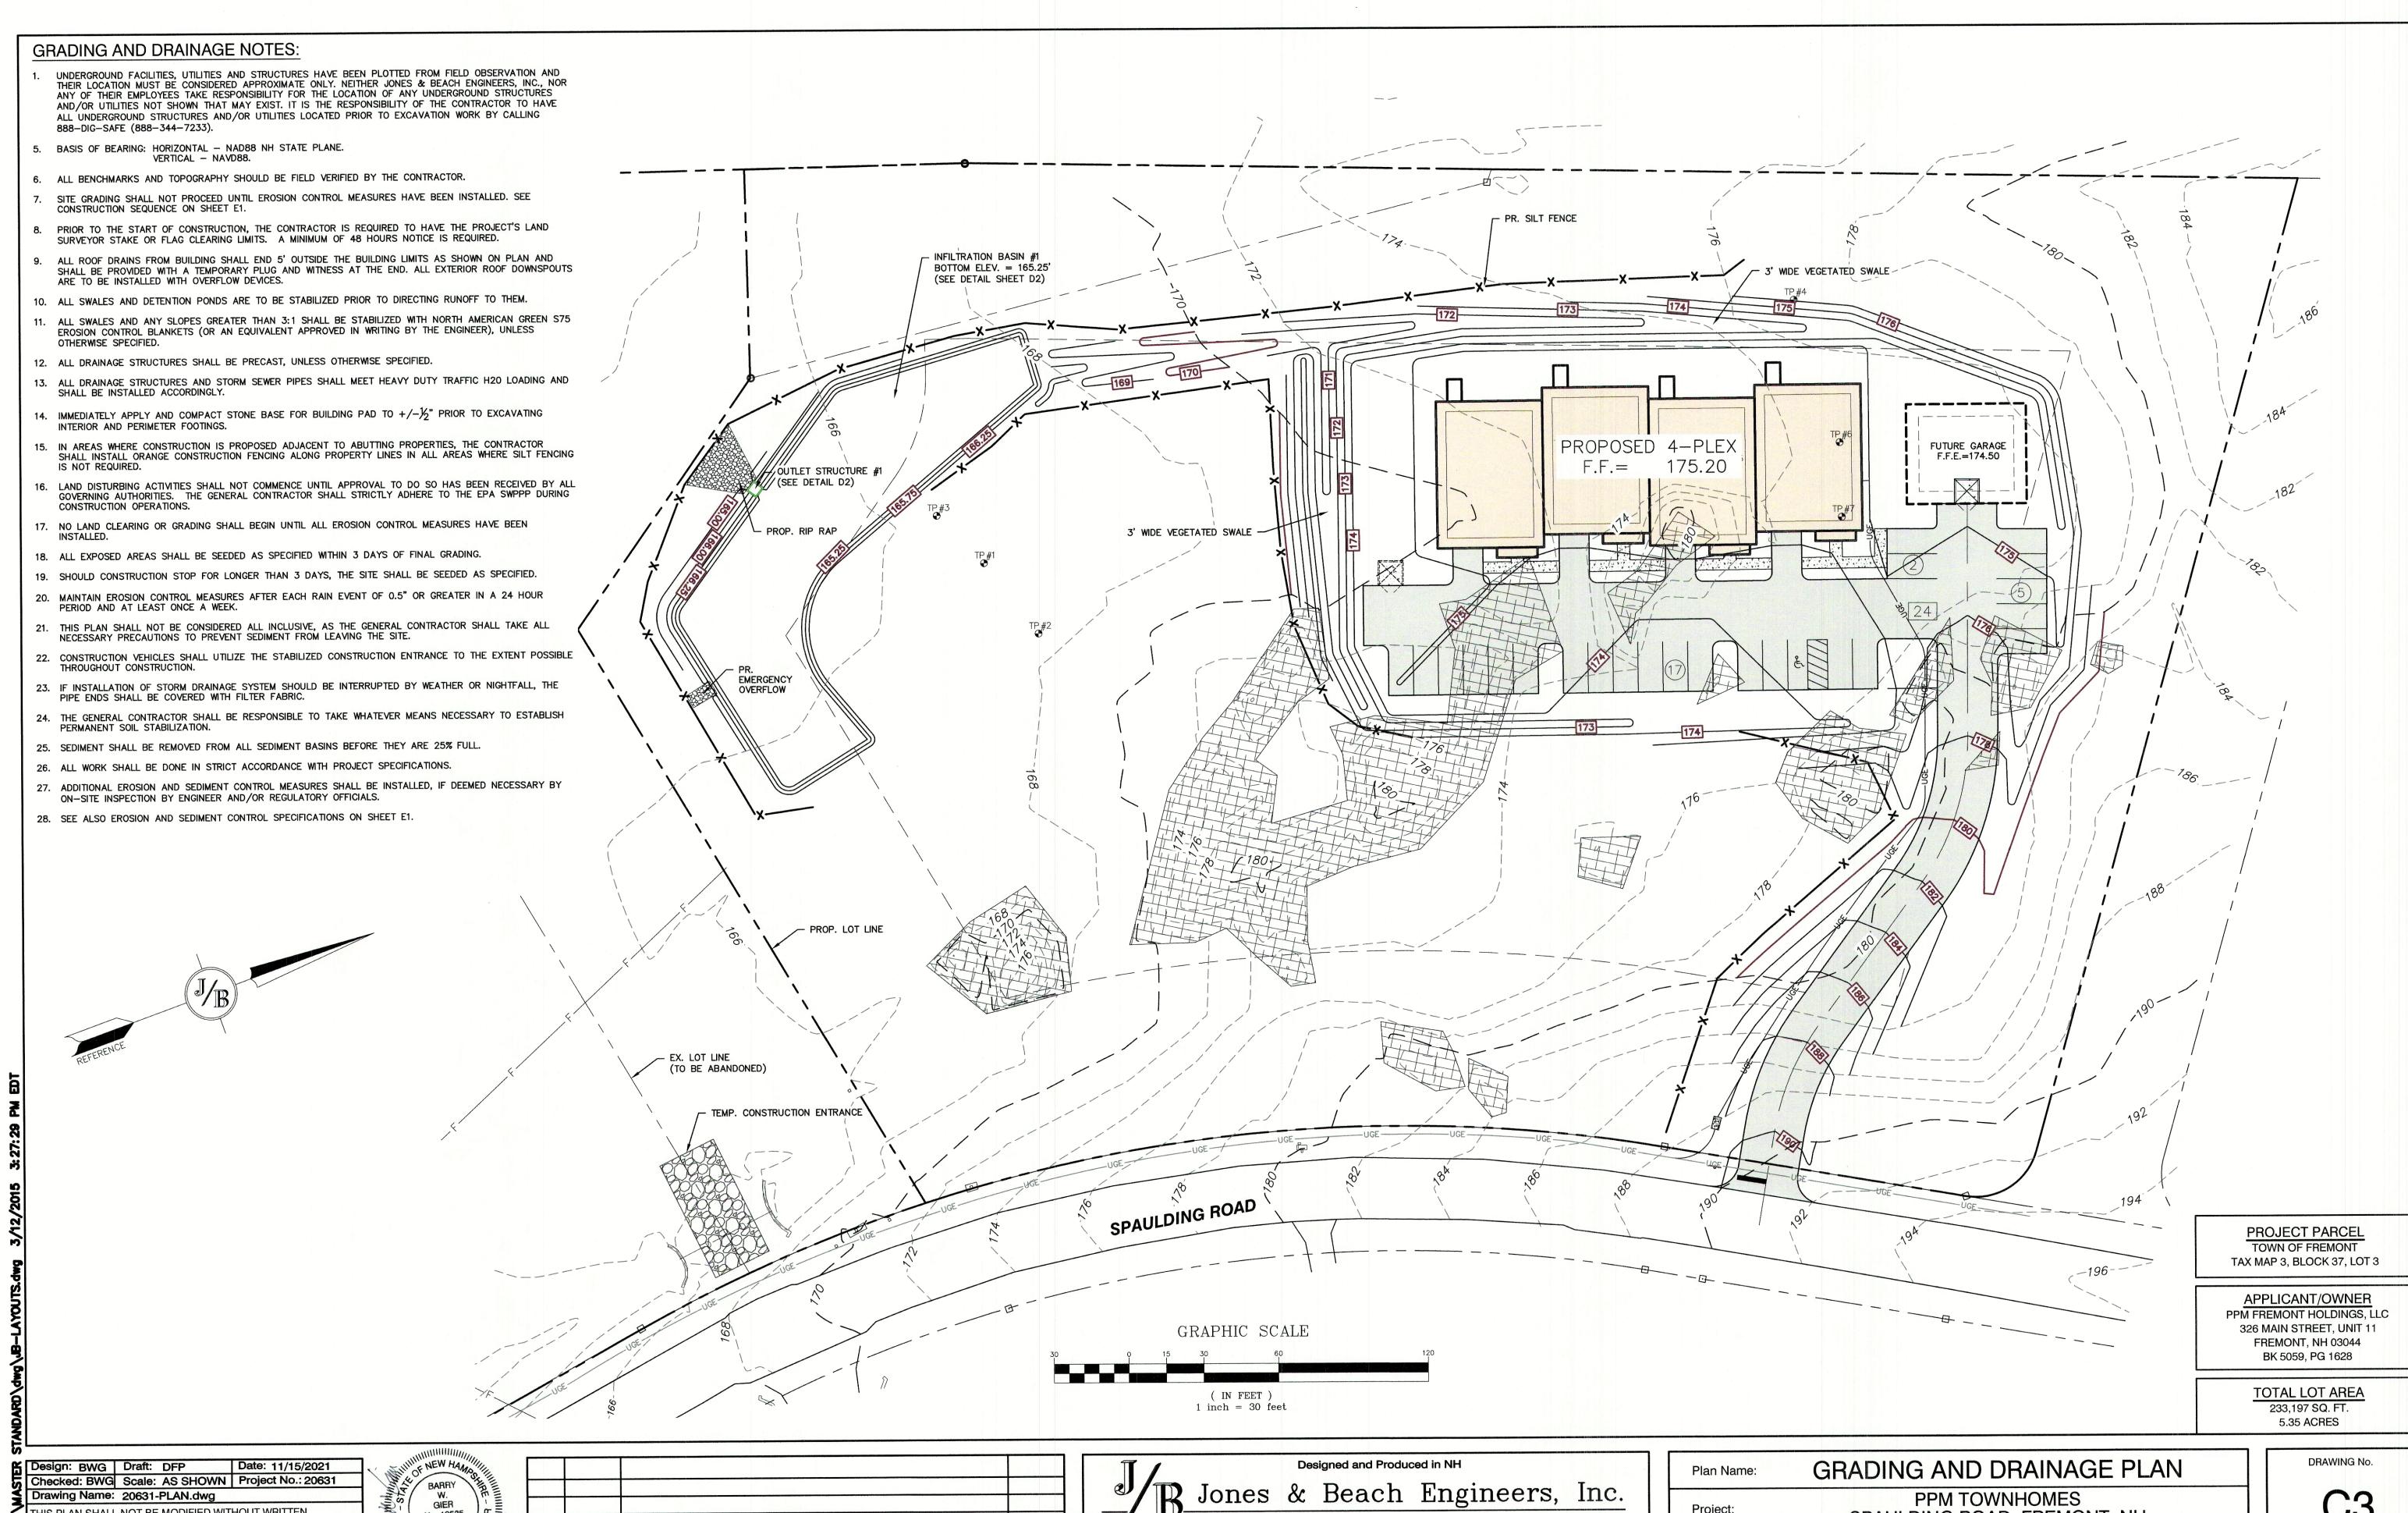

Stratham, NH 03885

THIS PLAN SHALL NOT BE MODIFIED WITHOUT WRITTEN PERMISSION FROM JONES & BEACH ENGINEERS, INC. (JBE). ANY ALTERATIONS, AUTHORIZED OR OTHERWISE, SHALL BE AT THE USER'S SOLE RISK AND WITHOUT LIABILITY TO JBE.



1	11/15/21	REVISED PER PB COMMENTS	BWG
0	10/6/21	ISSUED FOR REVIEW	BWG
REV.	DATE	REVISION	BY

85 Portsmouth Ave. Civil Engineering Services
PO Box 219 603-772-4746 FAX: 603-772-0227 E-MAIL: JBE@JONESANDBEACH.COM


GRADING AND DRAINAGE PL
PPM TOWNHOMES
SPAULDING ROAD, FREMONT, NH


Owner of Record:


PPM FREMONT HOLDING, LLC


326 MAIN STREET FREMONT, NH 03044

SHEET 5 OF 12 JBE PROJECT NO. 20631

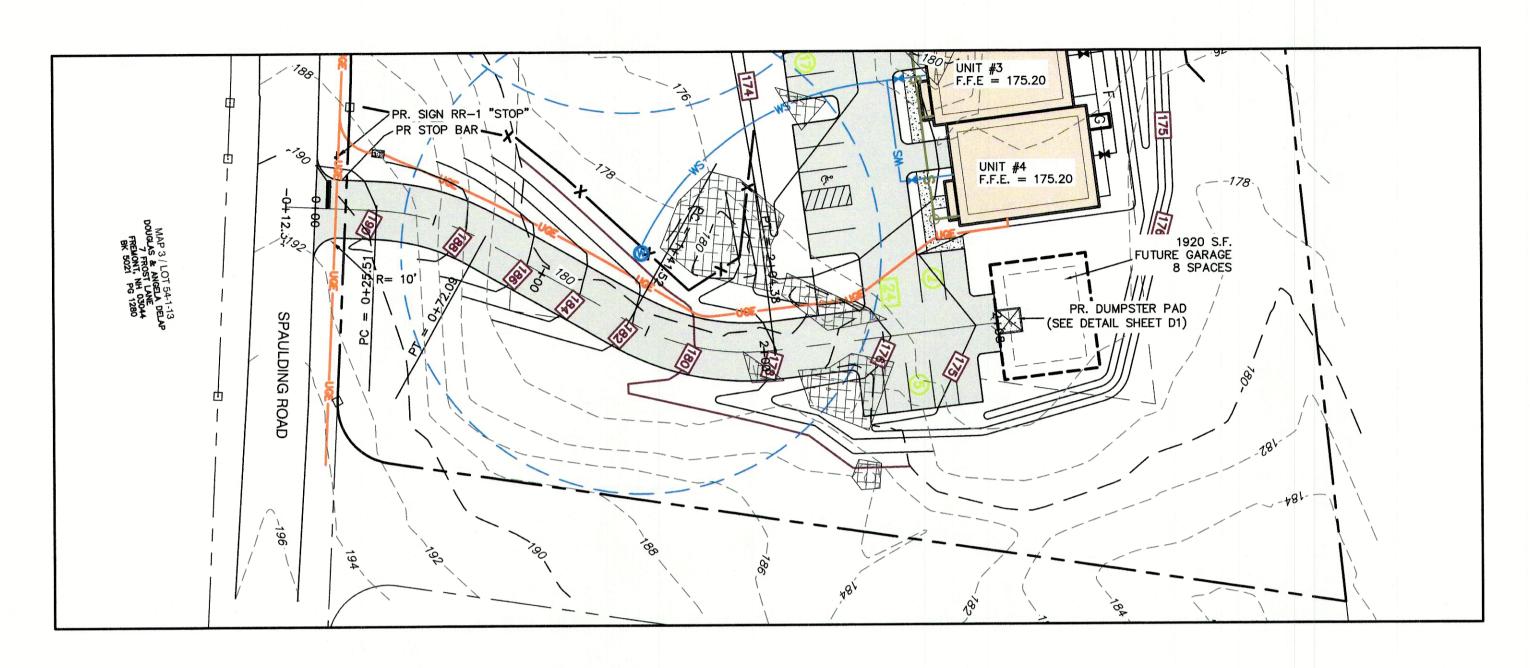

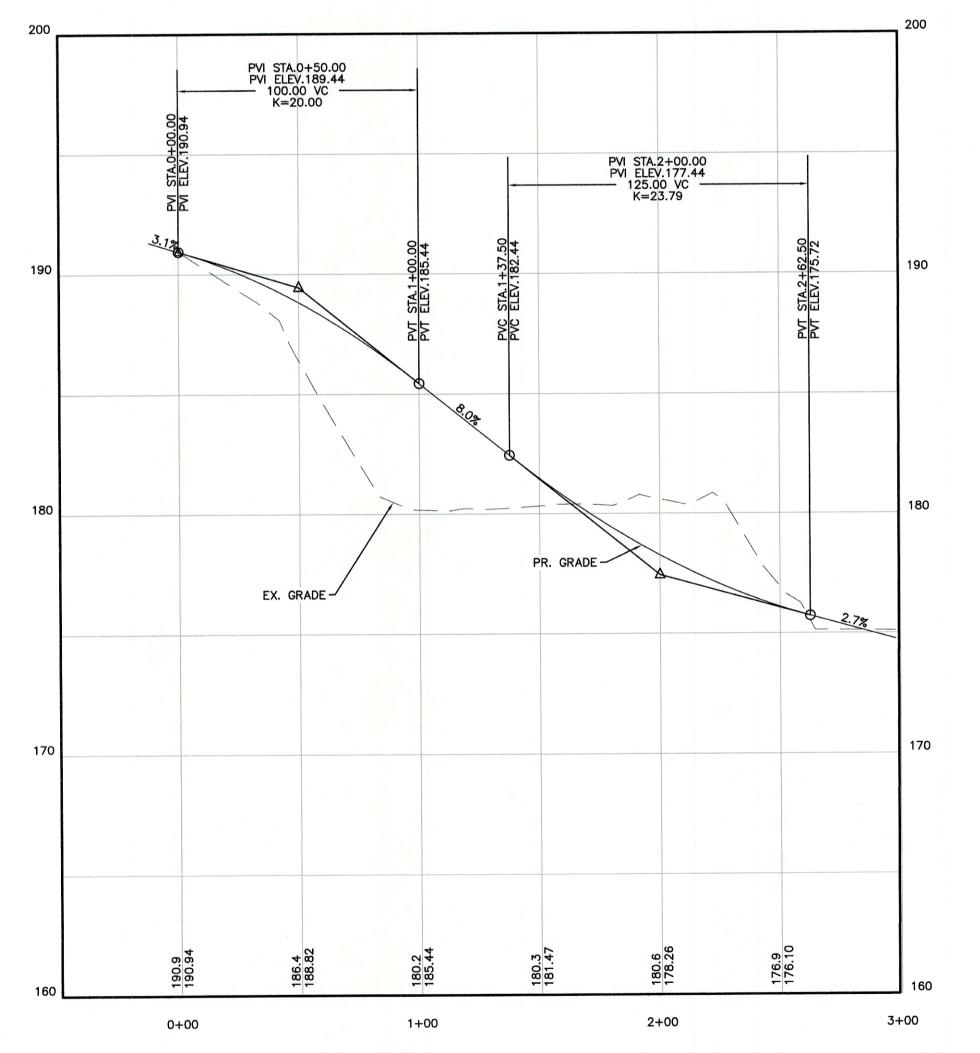

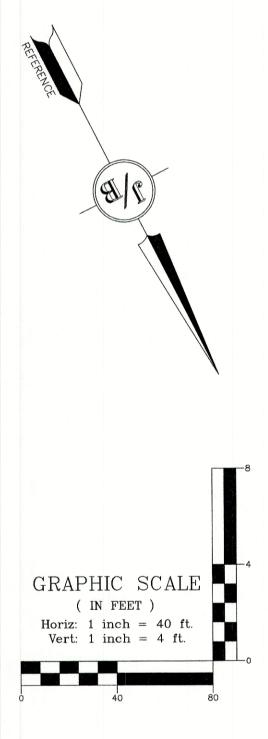

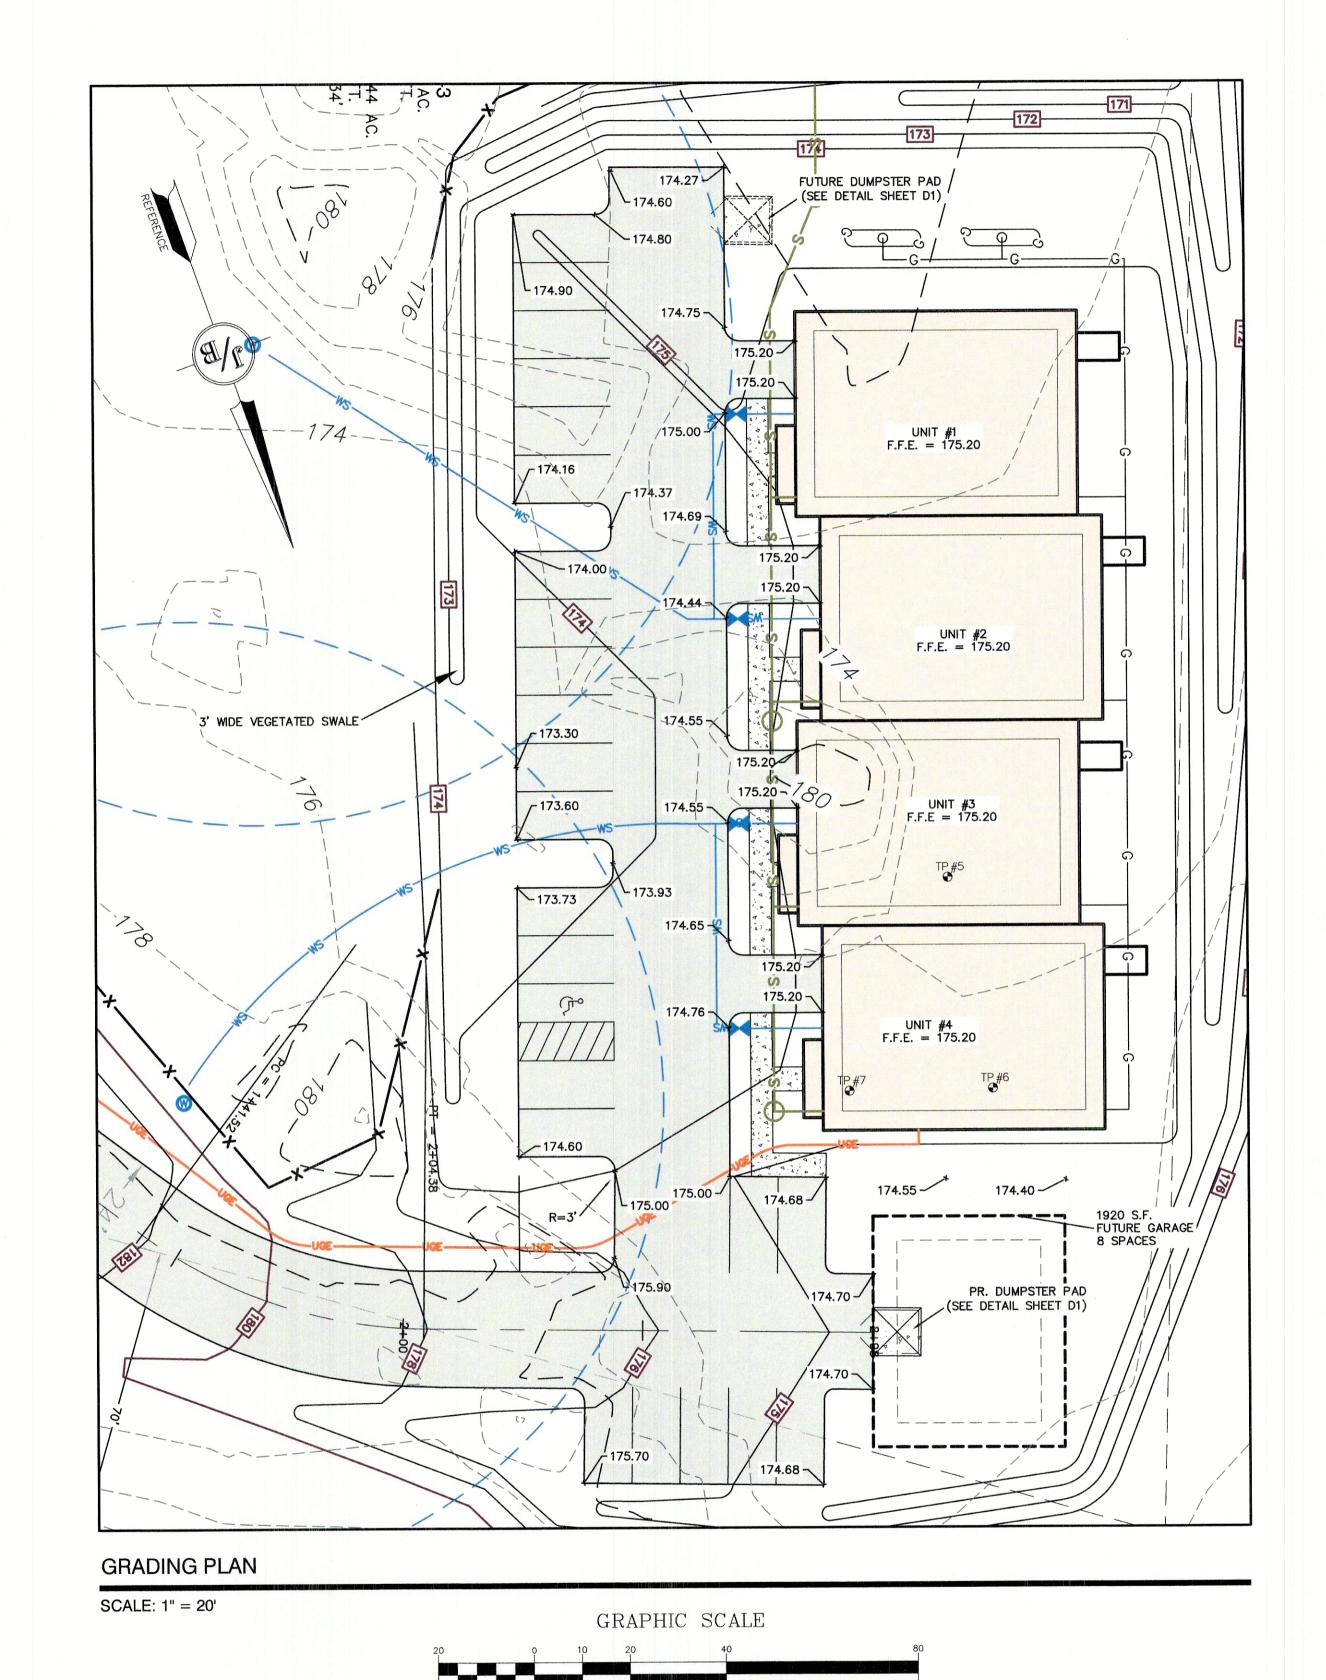

Design: BWG Draft: DFP Date: 11/15/2021
Checked: BWG Scale: AS SHOWN Project No.: 20631
Drawing Name: 20631-PLAN.dwg
THIS BLAN SHALL NOT BE MODIFIED WITHOUT WRITTEN

THIS PLAN SHALL NOT BE MODIFIED WITHOUT WRITTEN PERMISSION FROM JONES & BEACH ENGINEERS, INC. (JBE).
ANY ALTERATIONS, AUTHORIZED OR OTHERWISE, SHALL BE AT THE USER'S SOLE RISK AND WITHOUT LIABILITY TO JBE.



1	11/15/21	REVISED PER PB COMMENTS	BWG
0	10/6/21	ISSUED FOR REVIEW	BWG
REV.	DATE	REVISION	BY

Designed and Produced in NH


Jones & Beach Engineers, Inc.


85 Portsmouth Ave. PO Box 219 Stratham, NH 03885 Civil Engineering Services FAX: 603-772-0227 E-MAIL: JBE@JONESANDBEACH.COM

Plan Name:	PLAN AND PROFILE	
Project:	PPM TOWNHOMES SPAULDING ROAD, FREMONT, NH	
Owner of Record:	PPM FREMONT HOLDING, LLC 326 MAIN STREET FREMONT, NH 03044	

(IN FEET) 1" = 20'

P1
SHEET 6 OF 12
JBE PROJECT NO. 20631

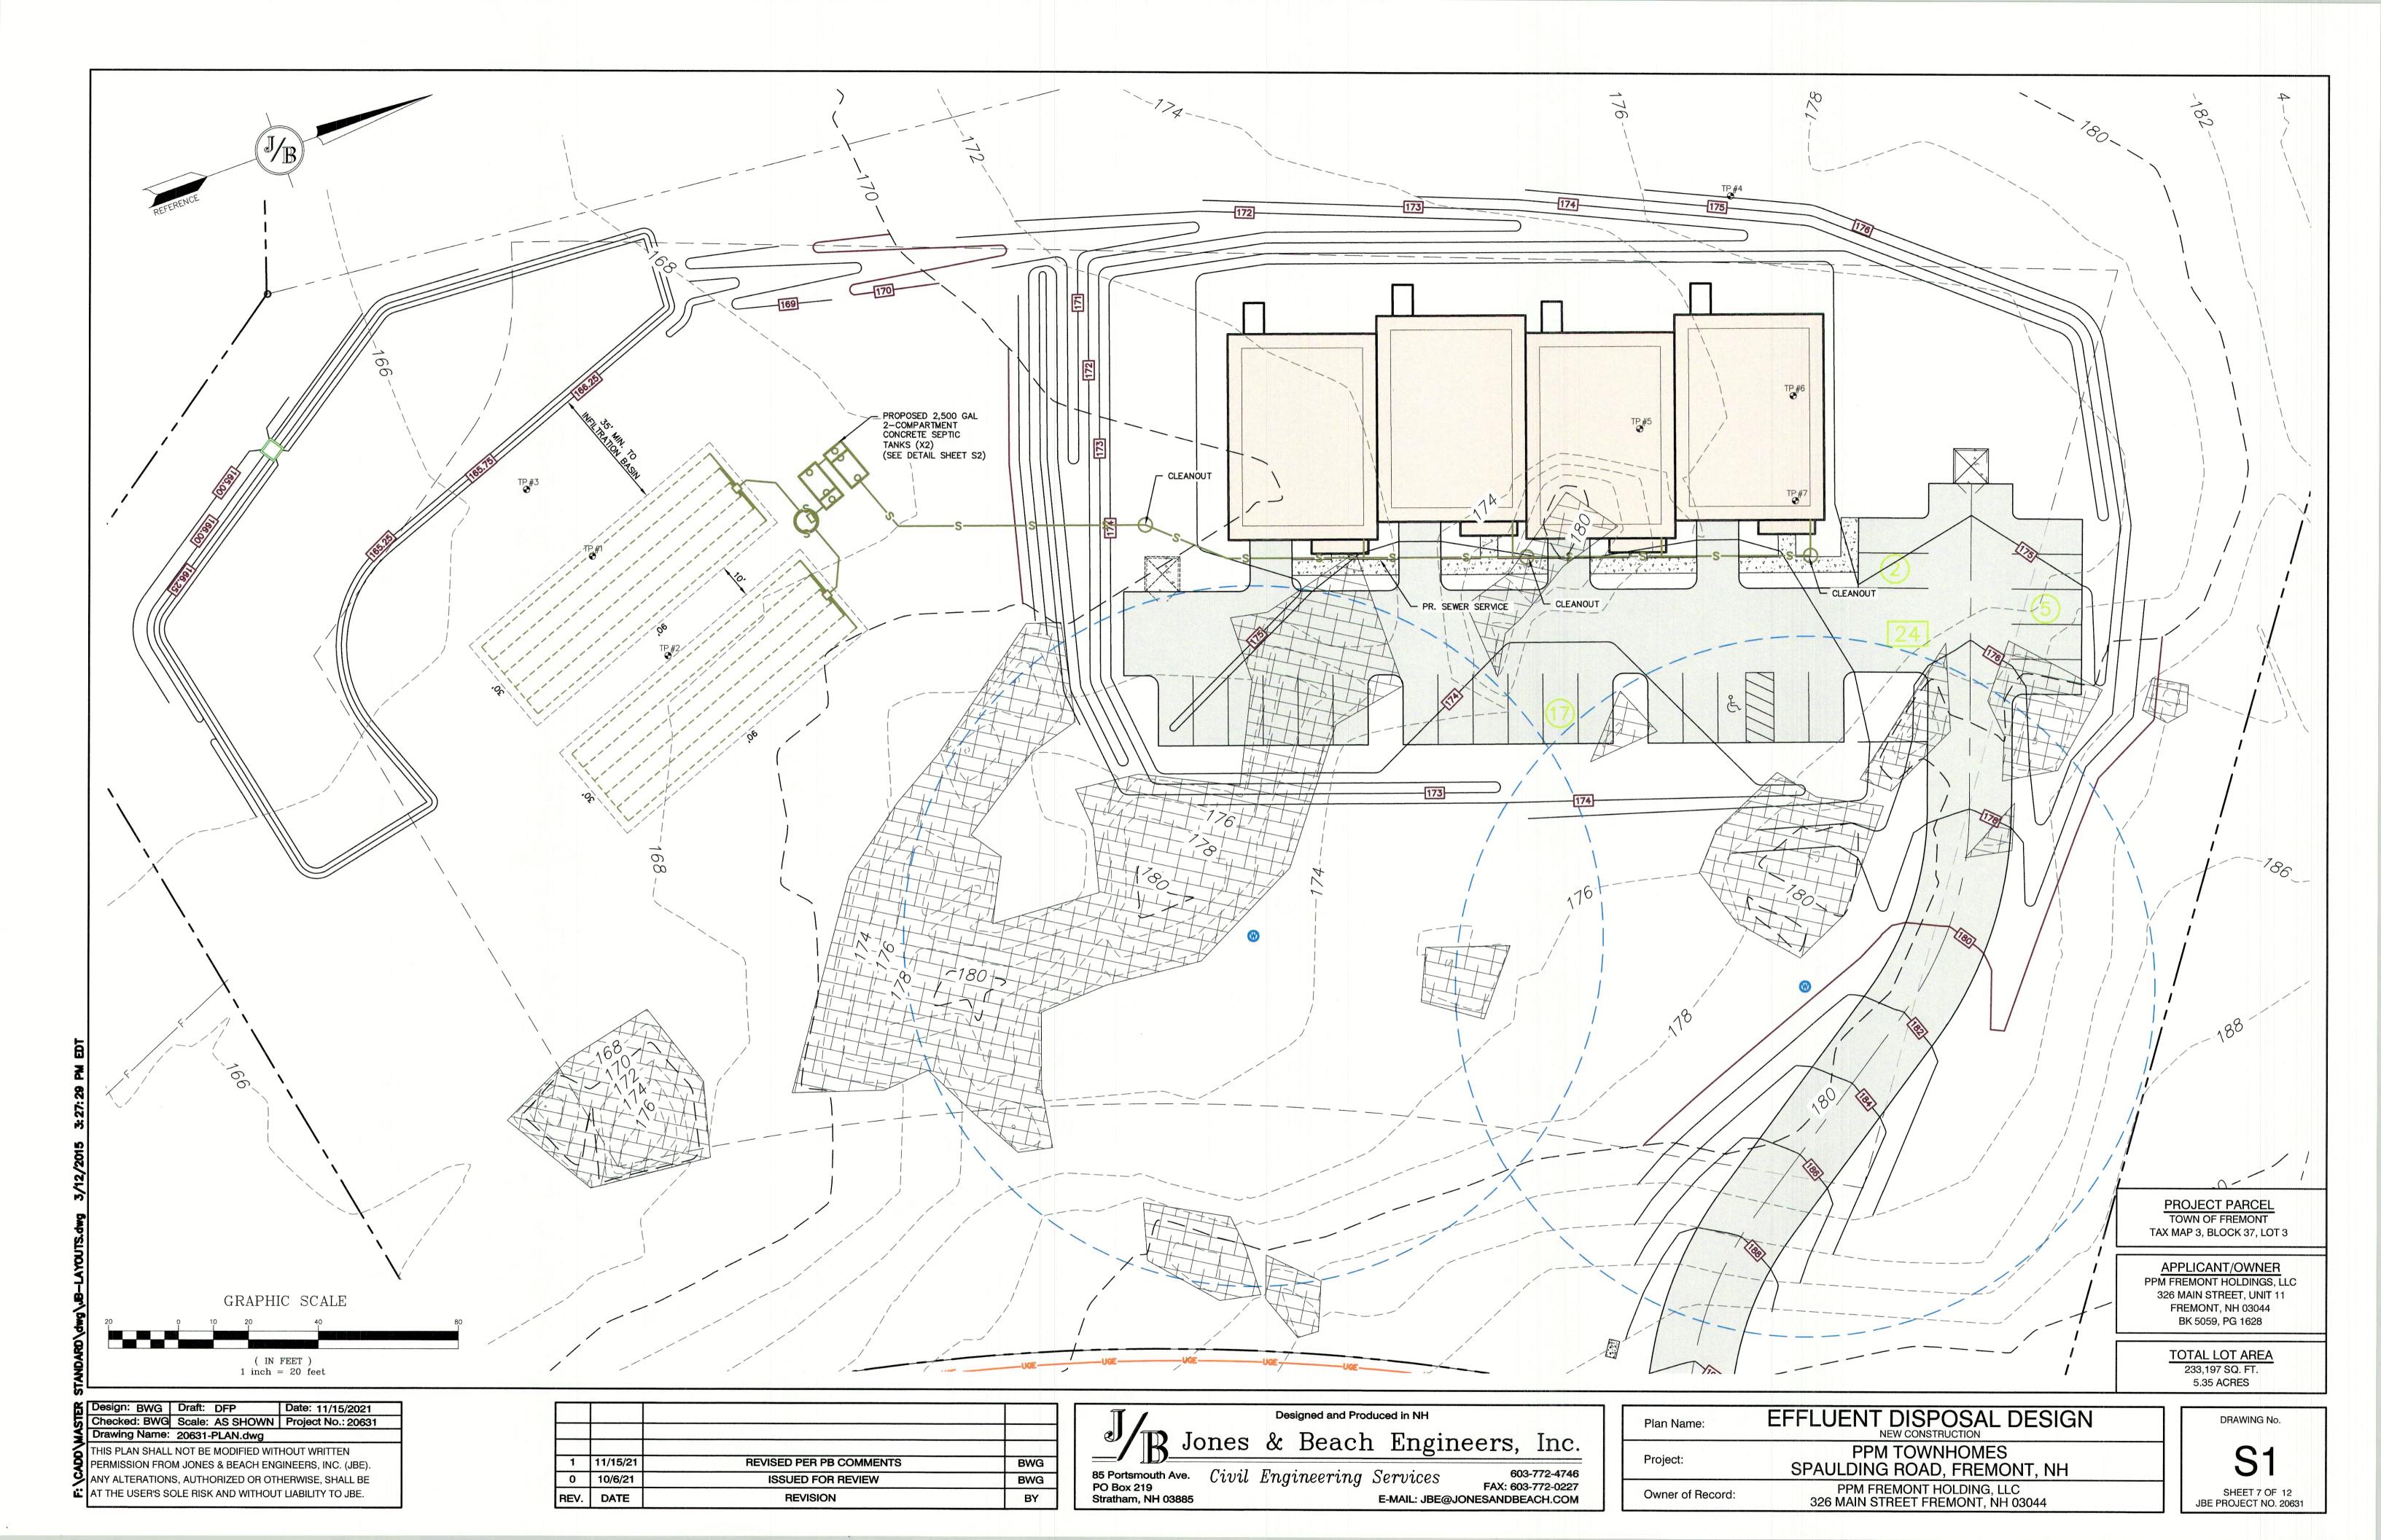

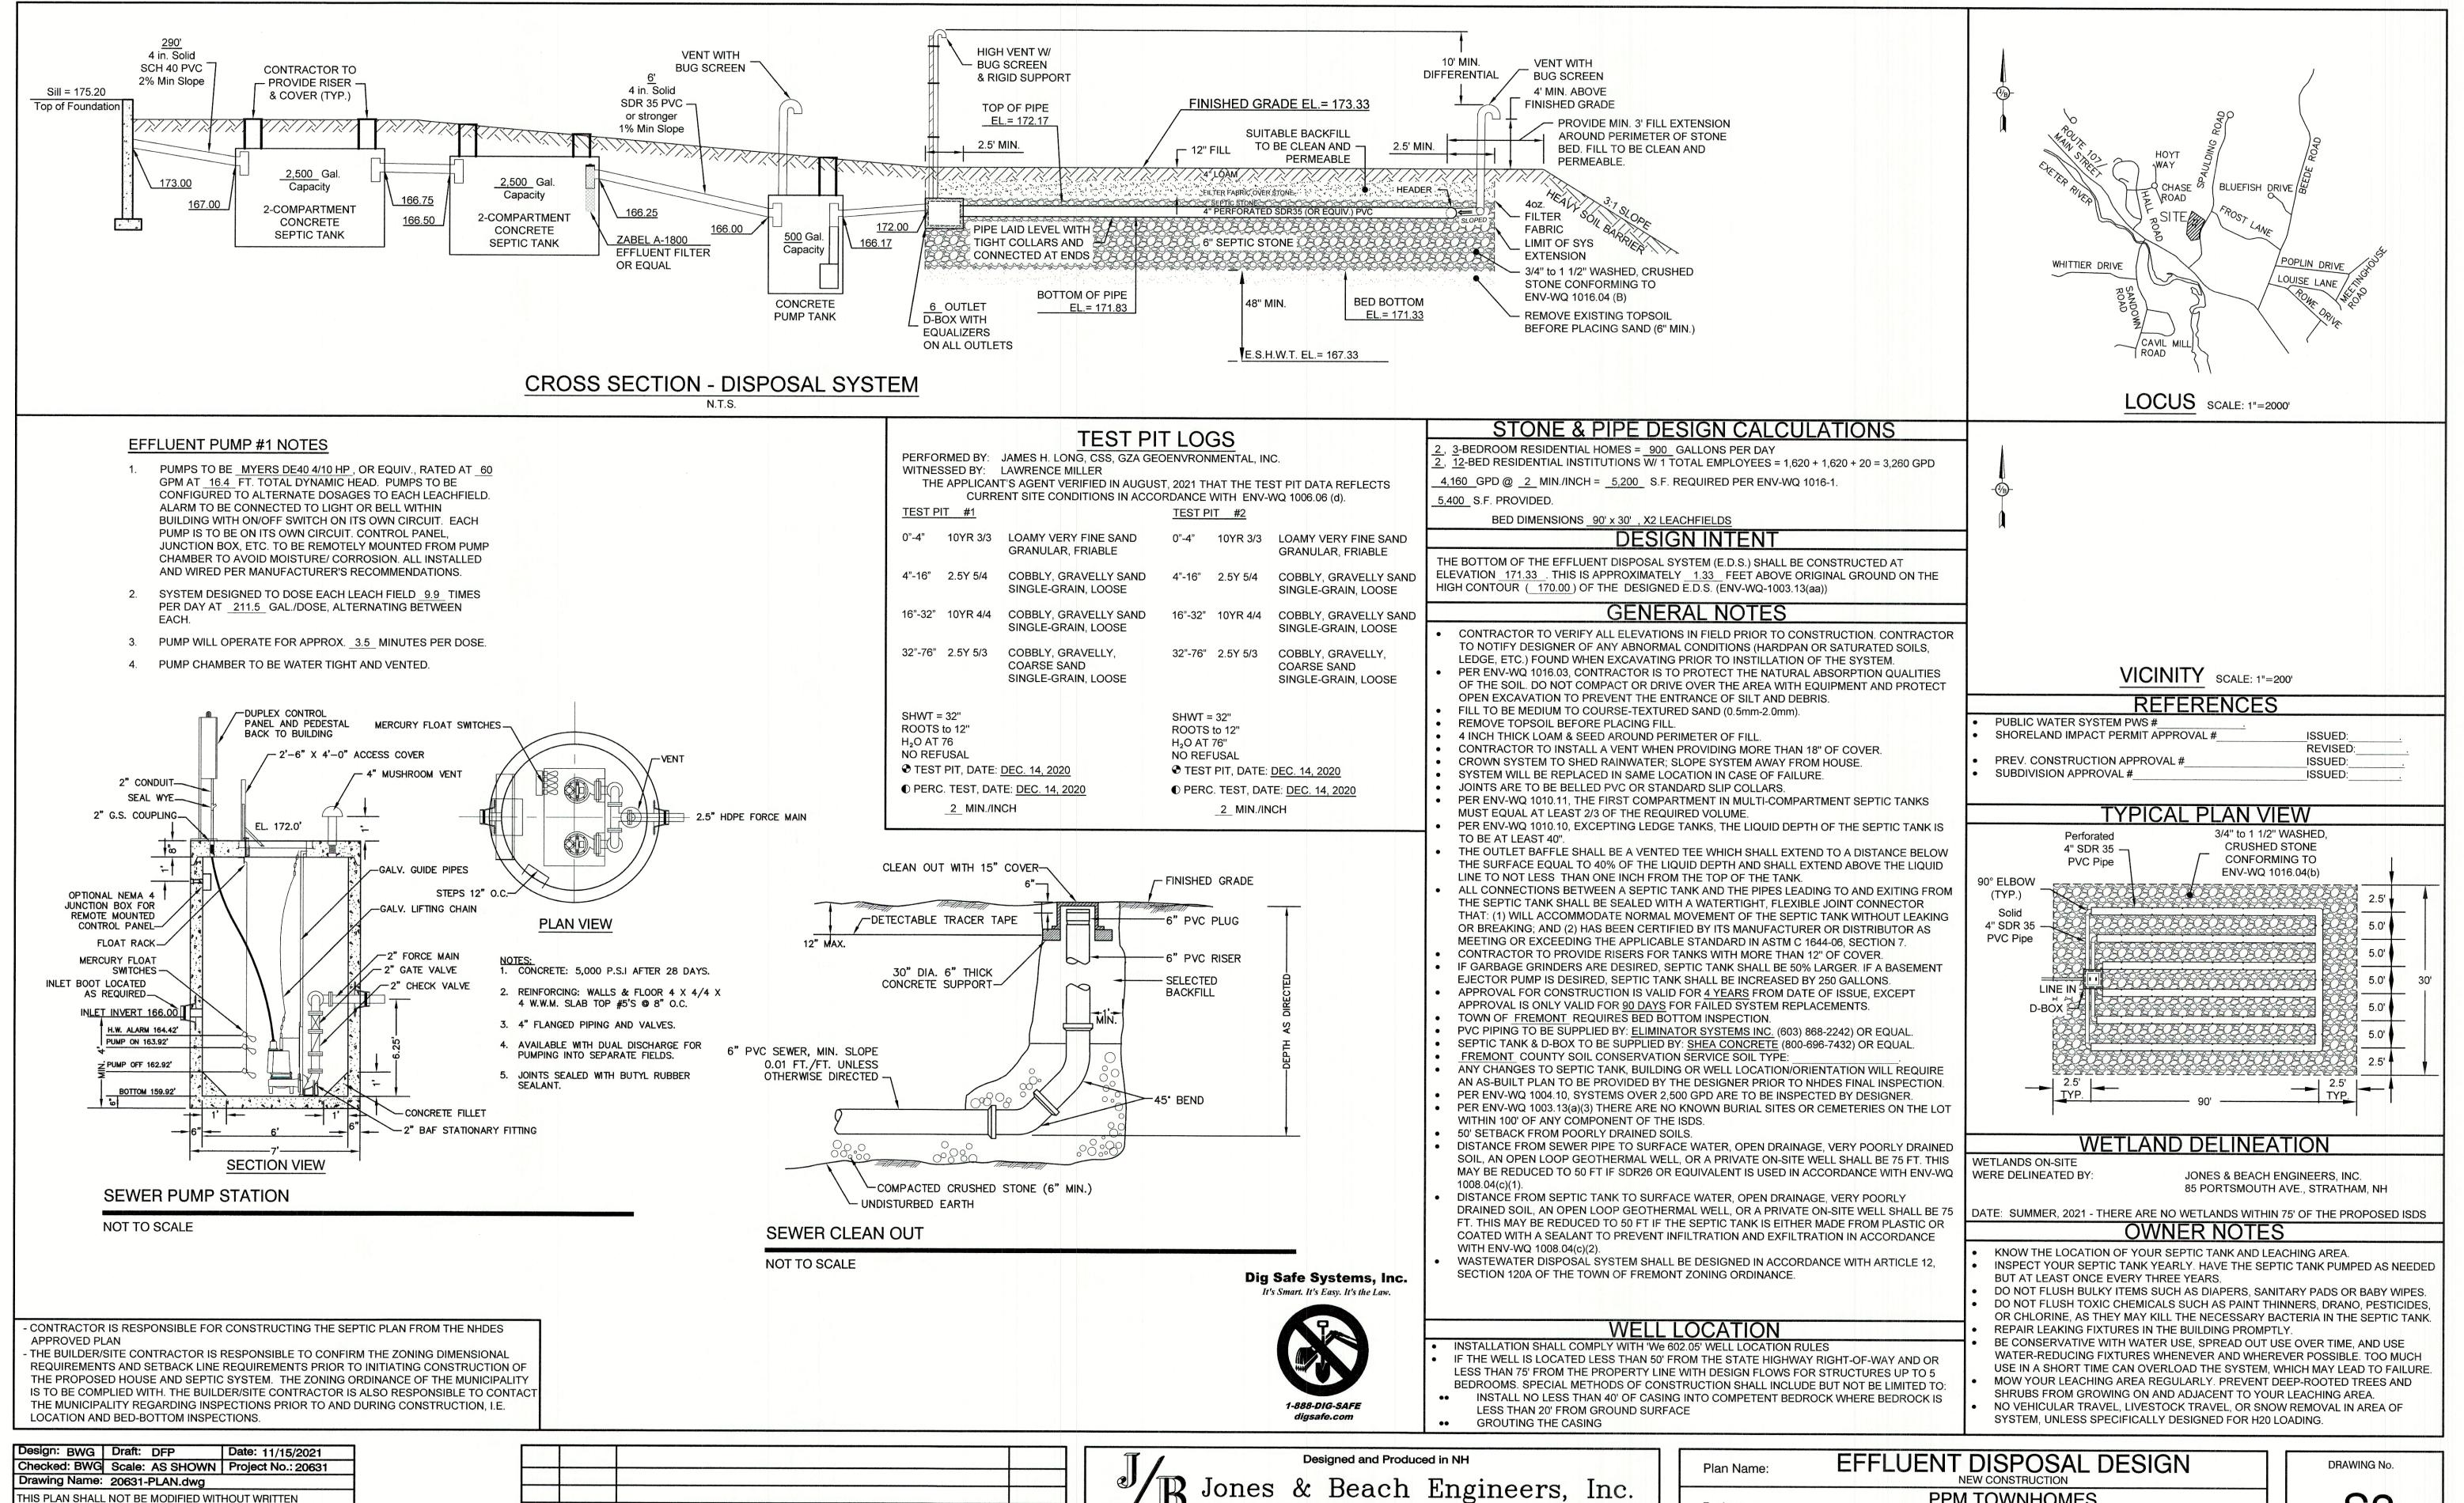

PERMISSION FROM JONES & BEACH ENGINEERS, INC. (JBE) ANY ALTERATIONS, AUTHORIZED OR OTHERWISE, SHALL BE

AT THE USER'S SOLE RISK AND WITHOUT LIABILITY TO JBE.

REVISED PER PB COMMENTS 1 | 11/15/21 BWG 0 10/6/21 SSUED FOR REVIEW BWG **REVISION** DATE BY

PO Box 219 Stratham, NH 03885

85 Portsmouth Ave. Civil Engineering Services


603-772-4746 FAX: 603-772-0227 E-MAIL: JBE@JONESANDBEACH.COM

PPM TOWNHOMES Project: SPAULDING ROAD, FREMONT, NH

Owner of Record:

PPM FREMONT HOLDING, LLC 326 MAIN STREET FREMONT, NH 03044

SHEET 8 OF 12 JBE PROJECT NO. 20631

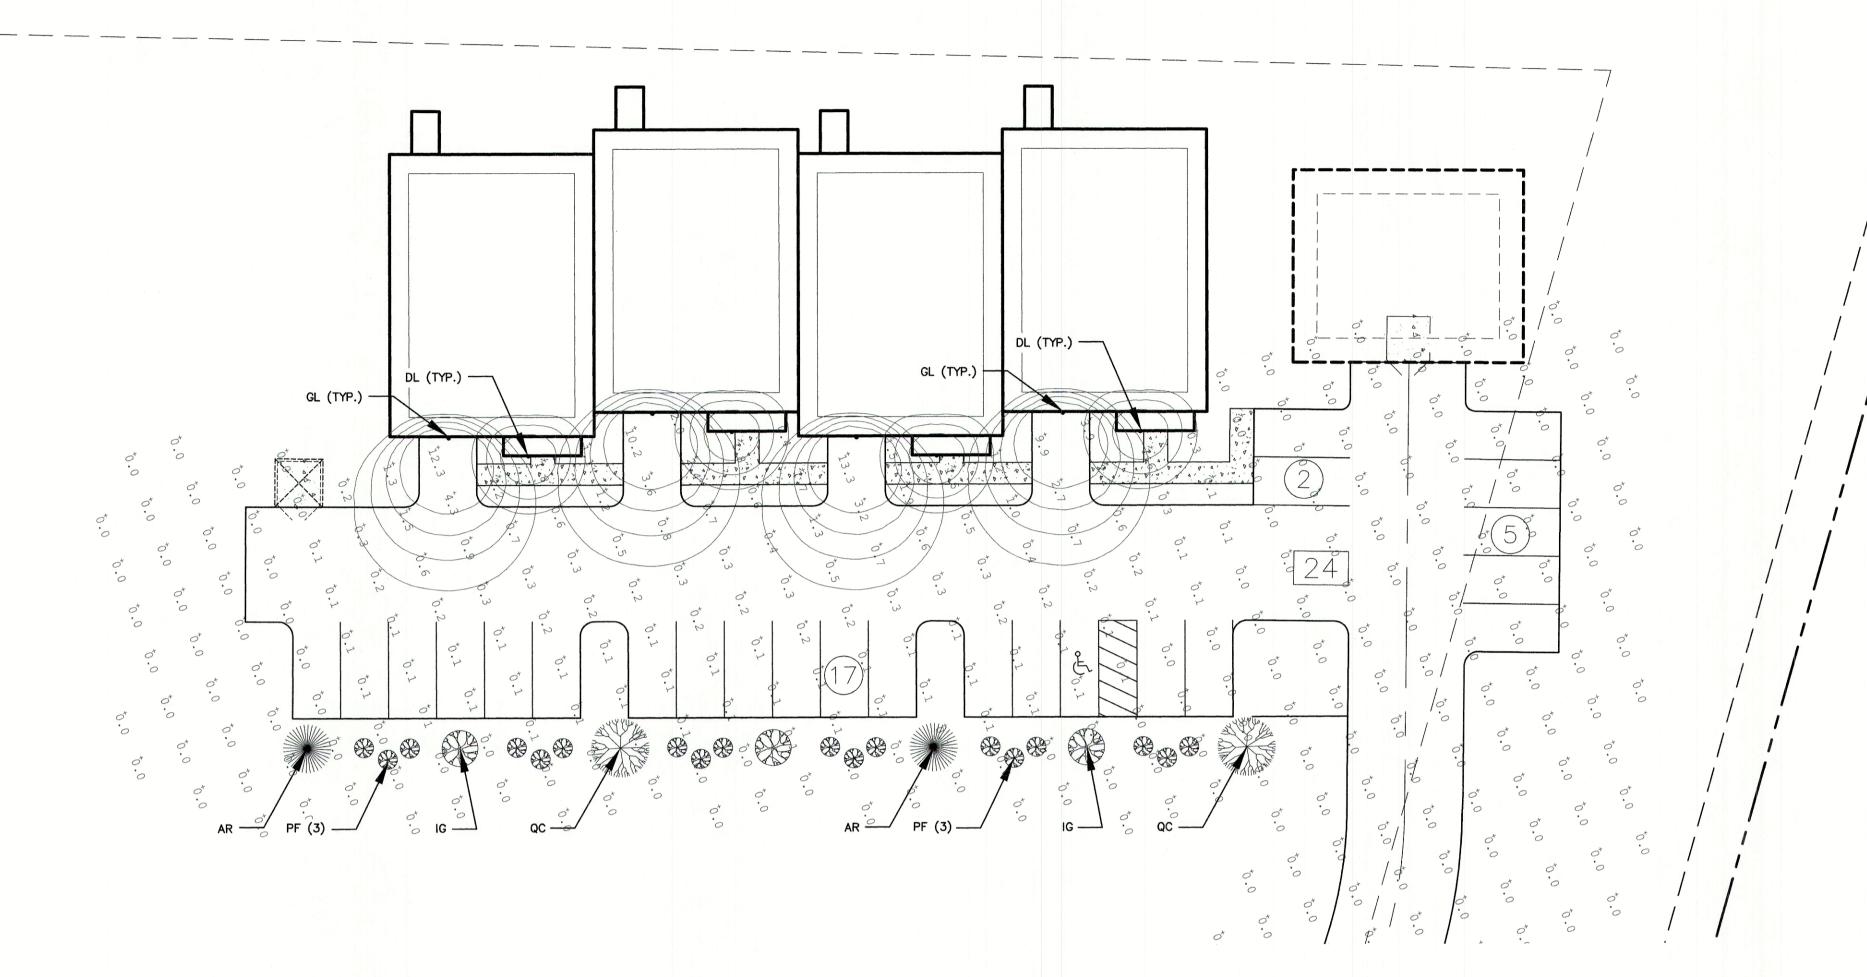





LANDSCAPE NOTES:

- THE CONTRACTOR SHALL LOCATE AND VERIFY THE EXISTENCE OF ALL UTILITIES PRIOR TO STARTING WORK.
- 2. THE CONTRACTOR SHALL SUPPLY ALL PLANT MATERIALS IN QUANTITIES SUFFICIENT TO COMPLETE THE PLANTINGS SHOWN ON THE DRAWINGS.
- 3. ALL MATERIAL SHALL CONFORM TO THE GUIDELINES ESTABLISHED BY THE CURRENT AMERICAN STANDARD FOR NURSERY STOCK PUBLISHED BY THE AMERICAN ASSOCIATION
- 4. ALL PLANT SUBSTITUTIONS MUST BE APPROVED THE LANDSCAPE ARCHITECT.
- 5. ALL PLANT MATERIALS SHALL BE EXACTLY AS SPECIFIED BY THE LANDSCAPE ARCHITECT. IF PLANT SPECIES CULTIVARS ARE FOUND TO VARY FROM THAT SPECIFIED AT ANY TIME DURING THE GUARANTEE PERIOD, THE LANDSCAPE ARCHITECT RESERVES THE RIGHT TO HAVE THE CONTRACTOR REPLACE THAT PLANT MATERIAL.
- PLANTS SHALL BE SUBJECT TO INSPECTION AND APPROVAL AT THE PLACE OF GROWTH, UPON DELIVERY OR AT THE JOB SITE WHILE WORK IS ON-GOING FOR CONFORMITY TO SPECIFIED QUALITY, SIZE AND VARIETY.
- 7. PLANTS FURNISHED IN CONTAINERS SHALL HAVE THE ROOTS WELL ESTABLISHED IN THE SOIL MASS AND SHALL HAVE AT LEAST ONE (1) GROWING SEASON. ROOT-BOUND

PLANTS OR INADEQUATELY SIZED CONTAINERS TO SUPPORT THE PLANT MAY BE DEEMED

- 8. NO PLANT SHALL BE PUT IN THE GROUND BEFORE GRADING HAS BEEN FINISHED AND APPROVED BY THE LANDSCAPE ARCHITECT.
- 9. ALL WORK AND PLANTS SHALL BE DONE, INSTALLED AND DETAILED IN STRICT ACCORDANCE WITH PROJECT SPECIFICATIONS.
- 10. ALL PLANTS SHALL BE WATERED THOROUGHLY TWICE DURING THE FIRST 24-HOUR PERIOD AFTER PLANTING. ALL PLANTS SHALL BE WATERED WEEKLY, OR MORE OFTEN IF NECESSARY, DURING THE FIRST GROWING SEASON.
- 11. ALL PLANTS SHALL BE GUARANTEED BY THE CONTRACTOR FOR NOT LESS THAN ONE FULL YEAR FROM THE TIME OF PROVISIONAL ACCEPTANCE. DURING THIS TIME, THE OWNER SHALL MAINTAIN ALL PLANT MATERIALS IN THE ABOVE MANNER. IT IS THE CONTRACTOR'S RESPONSIBILITY TO INSPECT THE PLANTS TO ENSURE PROPER CARE. IF THE CONTRACTOR IS DISSATISFIED WITH THE CARE GIVEN, HE SHALL IMMEDIATELY, AND IN SUFFICIENT TIME TO PERMIT THE CONDITION TO BE RECTIFIED, NOTIFY THE LANDSCAPE ARCHITECT IN WRITING OR OTHERWISE FORFEIT HIS CLAIM.
- 12. FINAL ACCEPTANCE BY THE LANDSCAPE ARCHITECT WILL BE MADE UPON THE CONTRACTOR'S REQUEST AFTER ALL CORRECTIVE WORK HAS BEEN COMPLETED.
- 13. BY THE END OF THE GUARANTEE PERIOD, THE CONTRACTOR SHALL HAVE REPLACED ANY PLANT MATERIAL THAT IS MISSING, NOT TRUE TO SIZE AS SPECIFIED, THAT HAS DIED, LOST NATURAL SHAPE DUE TO DEAD BRANCHES, EXCESSIVE PRUNING OR INADEQUATE OR IMPROPER CARE, OR THAT IS, IN THE OPINION OF THE LANDSCAPE ARCHITECT, IN UNHEALTHY OR UNSIGHTLY CONDITION.
- 14. ALL LANDSCAPE AREAS TO BE GRASS COMMON TO REGION, EXCEPT FOR INTERIOR LANDSCAPED ISLANDS OR WHERE OTHER PLANT MATERIAL IS SPECIFIED.
- 15. ALL TREES AND SHRUBS SHALL BE PLANTED IN MULCH BEDS WITH EDGE STRIPS TO SEPARATE TURF GRASS AREAS.
- 16. THE CONTRACTOR SHALL REMOVE WEEDS, ROCKS, CONSTRUCTION ITEMS, ETC. FROM ANY LANDSCAPE AREA SO DESIGNATED TO REMAIN, WHETHER ON OR OFF-SITE. GRASS SEED OR PINE BARK MULCH SHALL BE APPLIED AS DEPICTED ON PLANS.
- 17. FINISHED GRADES IN LANDSCAPED ISLANDS SHALL BE INSTALLED SO THAT THEY ARE 1" HIGHER THAN THE TOP OF THE SURROUNDING CURB.
- 18. ALL LANDSCAPING SHALL MEET THE TOWN STANDARDS AND REGULATIONS.
- 19. EXISTING TREES TO REMAIN SHALL BE PROTECTED WITH TEMPORARY SNOW FENCING AT THE DRIPLINE OF THE TREE. THE CONTRACTOR SHALL NOT STORE VEHICLES OR MATERIALS WITHIN THE LANDSCAPED AREAS. ANY DAMAGE TO EXISTING TREES, SHRUBS OR LAWN SHALL BE REPAIRED BY THE CONTRACTOR AT NO ADDITIONAL COST TO THE
- 20. ALL MULCH AREAS SHALL RECEIVE A 3" LAYER OF SHREDDED PINE BARK MULCH OVER A 10 MIL WEED MAT EQUAL TO 'WEEDBLOCK' BY EASY GARDENER OR DEWITT WEED BARRIER.
- 21. ALL LANDSCAPED AREAS SHALL HAVE SELECT MATERIALS REMOVED TO A DEPTH OF AT LEAST 9" BELOW FINISH GRADE. THE RESULTING VOID IS TO BE FILLED WITH A MINIMUM OF 9" HIGH-QUALITY SCREENED LOAM AMENDED WITH 3" OF AGED ORGANIC COMPOST.
- 22. THIS PLAN IS INTENDED FOR LANDSCAPING PURPOSES ONLY. REFER TO CIVIL/SITE DRAWINGS FOR OTHER SITE CONSTRUCTION INFORMATION.
- 23. IRRIGATION PIPING SYSTEM SHALL BE REVIEWED AND APPROVED BY OWNER AND ENGINEER PRIOR TO INSTALLATION.
- 24. ADDITIONAL PLANTING AND SEEDING MAY BE REQUIRED AS PART OF THE ON-SITE WETLANDS RESTORATION AND MITIGATION PACKAGE PREPARED BY WEST ENVIRONMENTAL. CONTRACTOR SHALL COORDINATE WITH PROJECT ENGINEER AND WETLAND CONSULTANT TO ENSURE THAT THESE ADDITIONAL REQUIREMENTS ARE PROPERLY ADDRESSED.

PLANTING SCHEDULE:

BOTANICAL NAME/COMMON NAME	SIZE	LABEL	QUANTITY
TREES			
ACER RUBRUM 'RED SUNSET' / RED SUNSET RED MAPLE	2.5-3" CAL.	AR	2
QUERCUS COCCINEA / SCARLET OAK	2.5-3" CAL.	QC	2
SHRUBS			
POTENTILLA FRUTICOSA / SHRUBBY CINQUEFOIL	1 GAL.	PF	18
ILEX GLABRA COMPACTA / COMPACT INKBERRY	5 GAL.	IG	3

LUMINAIRE SCHEDULE:

Symbol	Qty	Label	Arrangement	Description
•	4	DL	Single	496860Z (KICHLER) / MTD AT FRONT DOOR
⊕	4	GL	Single	TGS2S402MRRW / WALL MTD 8.5' AFG

GRAPHIC SCALE (IN FEET)

1'' = 20'

Design: BWG | Draft: DFP Date: 11/15/2021 Checked: BWG Scale: AS SHOWN | Project No.: 20631 Drawing Name: 20631-PLAN.dwg THIS PLAN SHALL NOT BE MODIFIED WITHOUT WRITTEN PERMISSION FROM JONES & BEACH ENGINEERS, INC. (JBE).

ANY ALTERATIONS, AUTHORIZED OR OTHERWISE, SHALL BE AT THE USER'S SOLE RISK AND WITHOUT LIABILITY TO JBE.

PROJECT PARCEL

TOWN OF FREMONT

TAX MAP 3, BLOCK 37, LOT 3

APPLICANT/OWNER

PPM FREMONT HOLDINGS, LLC

326 MAIN STREET, UNIT 11

FREMONT, NH 03044

BK 5059, PG 1628

TOTAL LOT AREA

233,197 SQ. FT.


5.35 ACRES


1	11/15/21	REVISED PER PB COMMENTS	BWG
0	10/6/21	ISSUED FOR REVIEW	BWG
REV.	DATE	REVISION	BY

1/		Des	signed and Prod	luced in NH		
\mathbb{R}^{1}	ones	&	Beach	Engin	eers,	Inc.
85 Portsmouth Ave. PO Box 219	Civil	Eng	in eering	Services		3-772-4746 3-772-0227

Jone	es & Beach Engin	neers, Inc.	
85 Portsmouth Ave. Ci	vil Engineering Services	603-772-4746 FAX: 603-772-0227	
Stratham, NH 03885	E-MAIL: JBE@c	JONESANDBEACH.COM Owner of Recor	ra:

Plan Name:	LIGHTING AND LANDSCAPE PLAN		
Project:	PPM TOWNHOMES SPAULDING ROAD, FREMONT, NH		
Owner of Record:	PPM FREMONT HOLDING, LLC 326 MAIN STREET FREMONT, NH 03044		

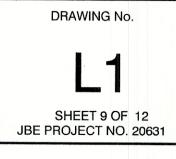


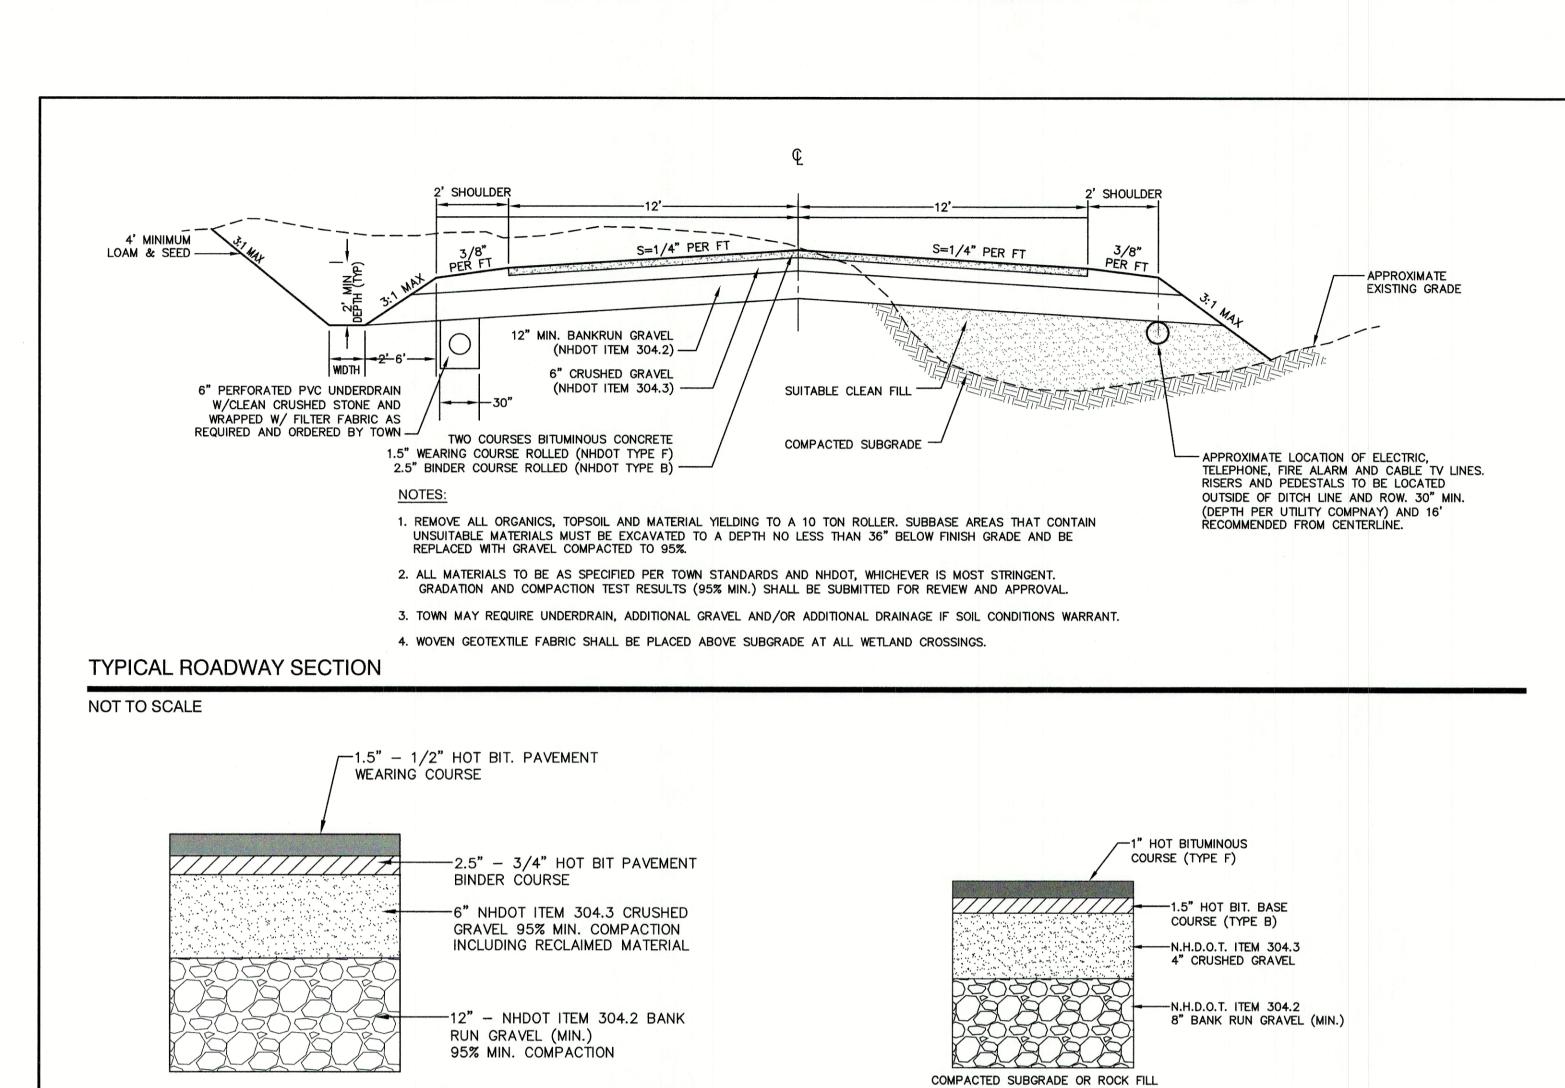

TYPICAL BITUMINOUS PAVEMENT

95% COMPACTED SUBGRADE OR ROCK FILL

NOT TO SCALE

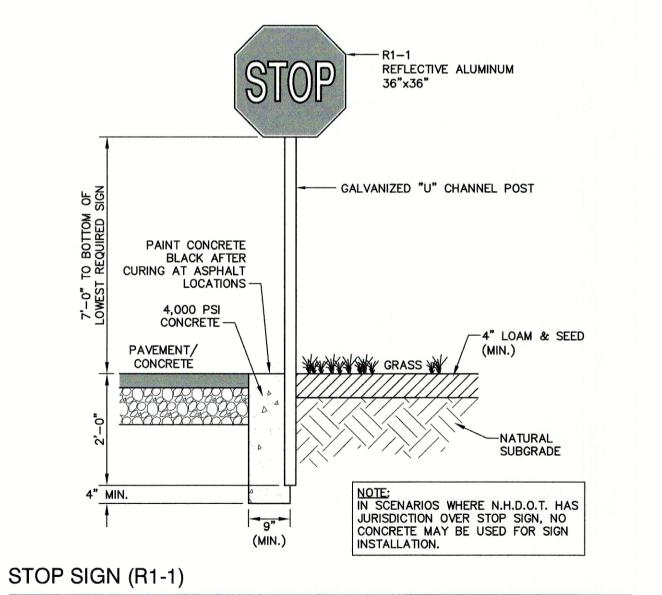

20' PLATFORM ROADWAY 6' (TYP.) EXISTING GRADE-5/8" PER FT. 5/8" PER FT. MAX. (TYP.)-DRIVEWAY CULVERT LOCATION WHERE NEEDED (MIN. 12" DIA., OR AS SPECIFIED)_/ -DITCHLINE **CUT SECTION CROSS-SECTION A-A** ROADWAY 2:1 SLOPE 20' PLATFORM VARIES MAX. (TYP.)_ CROSS-SECTION B-B 5/8" PER FT. BREAK POINT-APPROX. FILL SECTION EXISTING GRADE--CULVERT LOCATION WHERE NEEDED (MIN 12" DIA., OR TYPICAL DRIVEWAY SECTIONS AS SPECIFIED)


PLASTIC MARKER
TAPE ABOVE CABLES

ELECTRIC SERVICE
CABLES 250 VAC OR
LESS PVC-SCH 40

PRIMARY POWER 5" SCH. 80 PVC CABLE
7,200 VAC. OTHER POWER, TELEPHONE CATV, ETC., CABLES ARE NO CLOSER THAN 12"

NOTE: ALL UTILITIES SHALL BE REVIEWED AND APPROVED BY APPROPRIATE UTILITY COMPANY.

UTILITY TRENCH

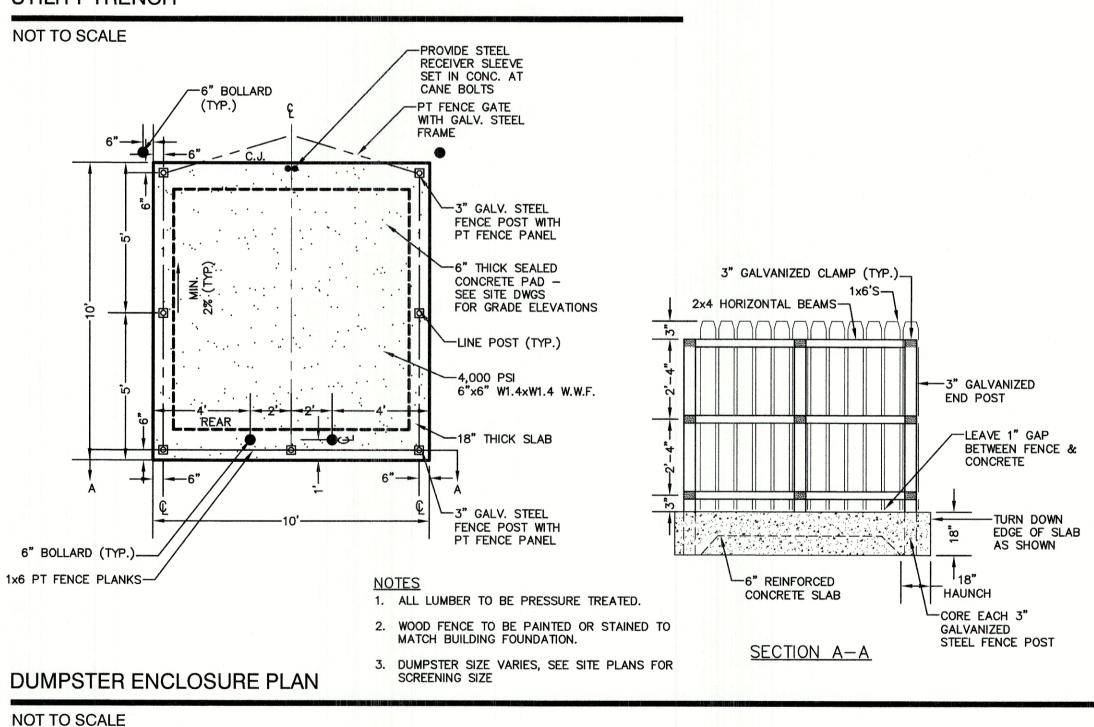

Design: BWG Draft: DFP Date: 11/15/2021
Checked: BWG Scale: AS SHOWN Project No.: 20631
Drawing Name: 20631-PLAN.dwg

NOT TO SCALE

THIS PLAN SHALL NOT BE MODIFIED WITHOUT WRITTEN PERMISSION FROM JONES & BEACH ENGINEERS, INC. (JBE). ANY ALTERATIONS, AUTHORIZED OR OTHERWISE, SHALL BE AT THE USER'S SOLE RISK AND WITHOUT LIABILITY TO JBE.



1	11/15/21	REVISED PER PB COMMENTS	BWG
0	10/6/21	ISSUED FOR REVIEW	BWG
REV.	DATE	REVISION	BY

NOT TO SCALE

BITUMINOUS SIDEWALK DETAIL

NOT TO SCALE

Designed and Produced in NH

Jones & Beach Engineers, Inc.

85 Portsmouth Ave. PO Box 219
Stratham, NH 03885

Civil Engineering Services

E-MAIL: JBE@JONESANDBEACH.COM


Plan Name:	DETAIL SHEET	
Flair Name.	DETAIL SHEET	
Project:	PPM TOWNHOMES SPAULDING ROAD, FREMONT, NH	
Owner of Record: PPM FREMONT HOLDING, LLC 326 MAIN STREET FREMONT, NH 03044		

DRAWING No.

D1

SHEET 10 OF 12

JBE PROJECT NO. 20631

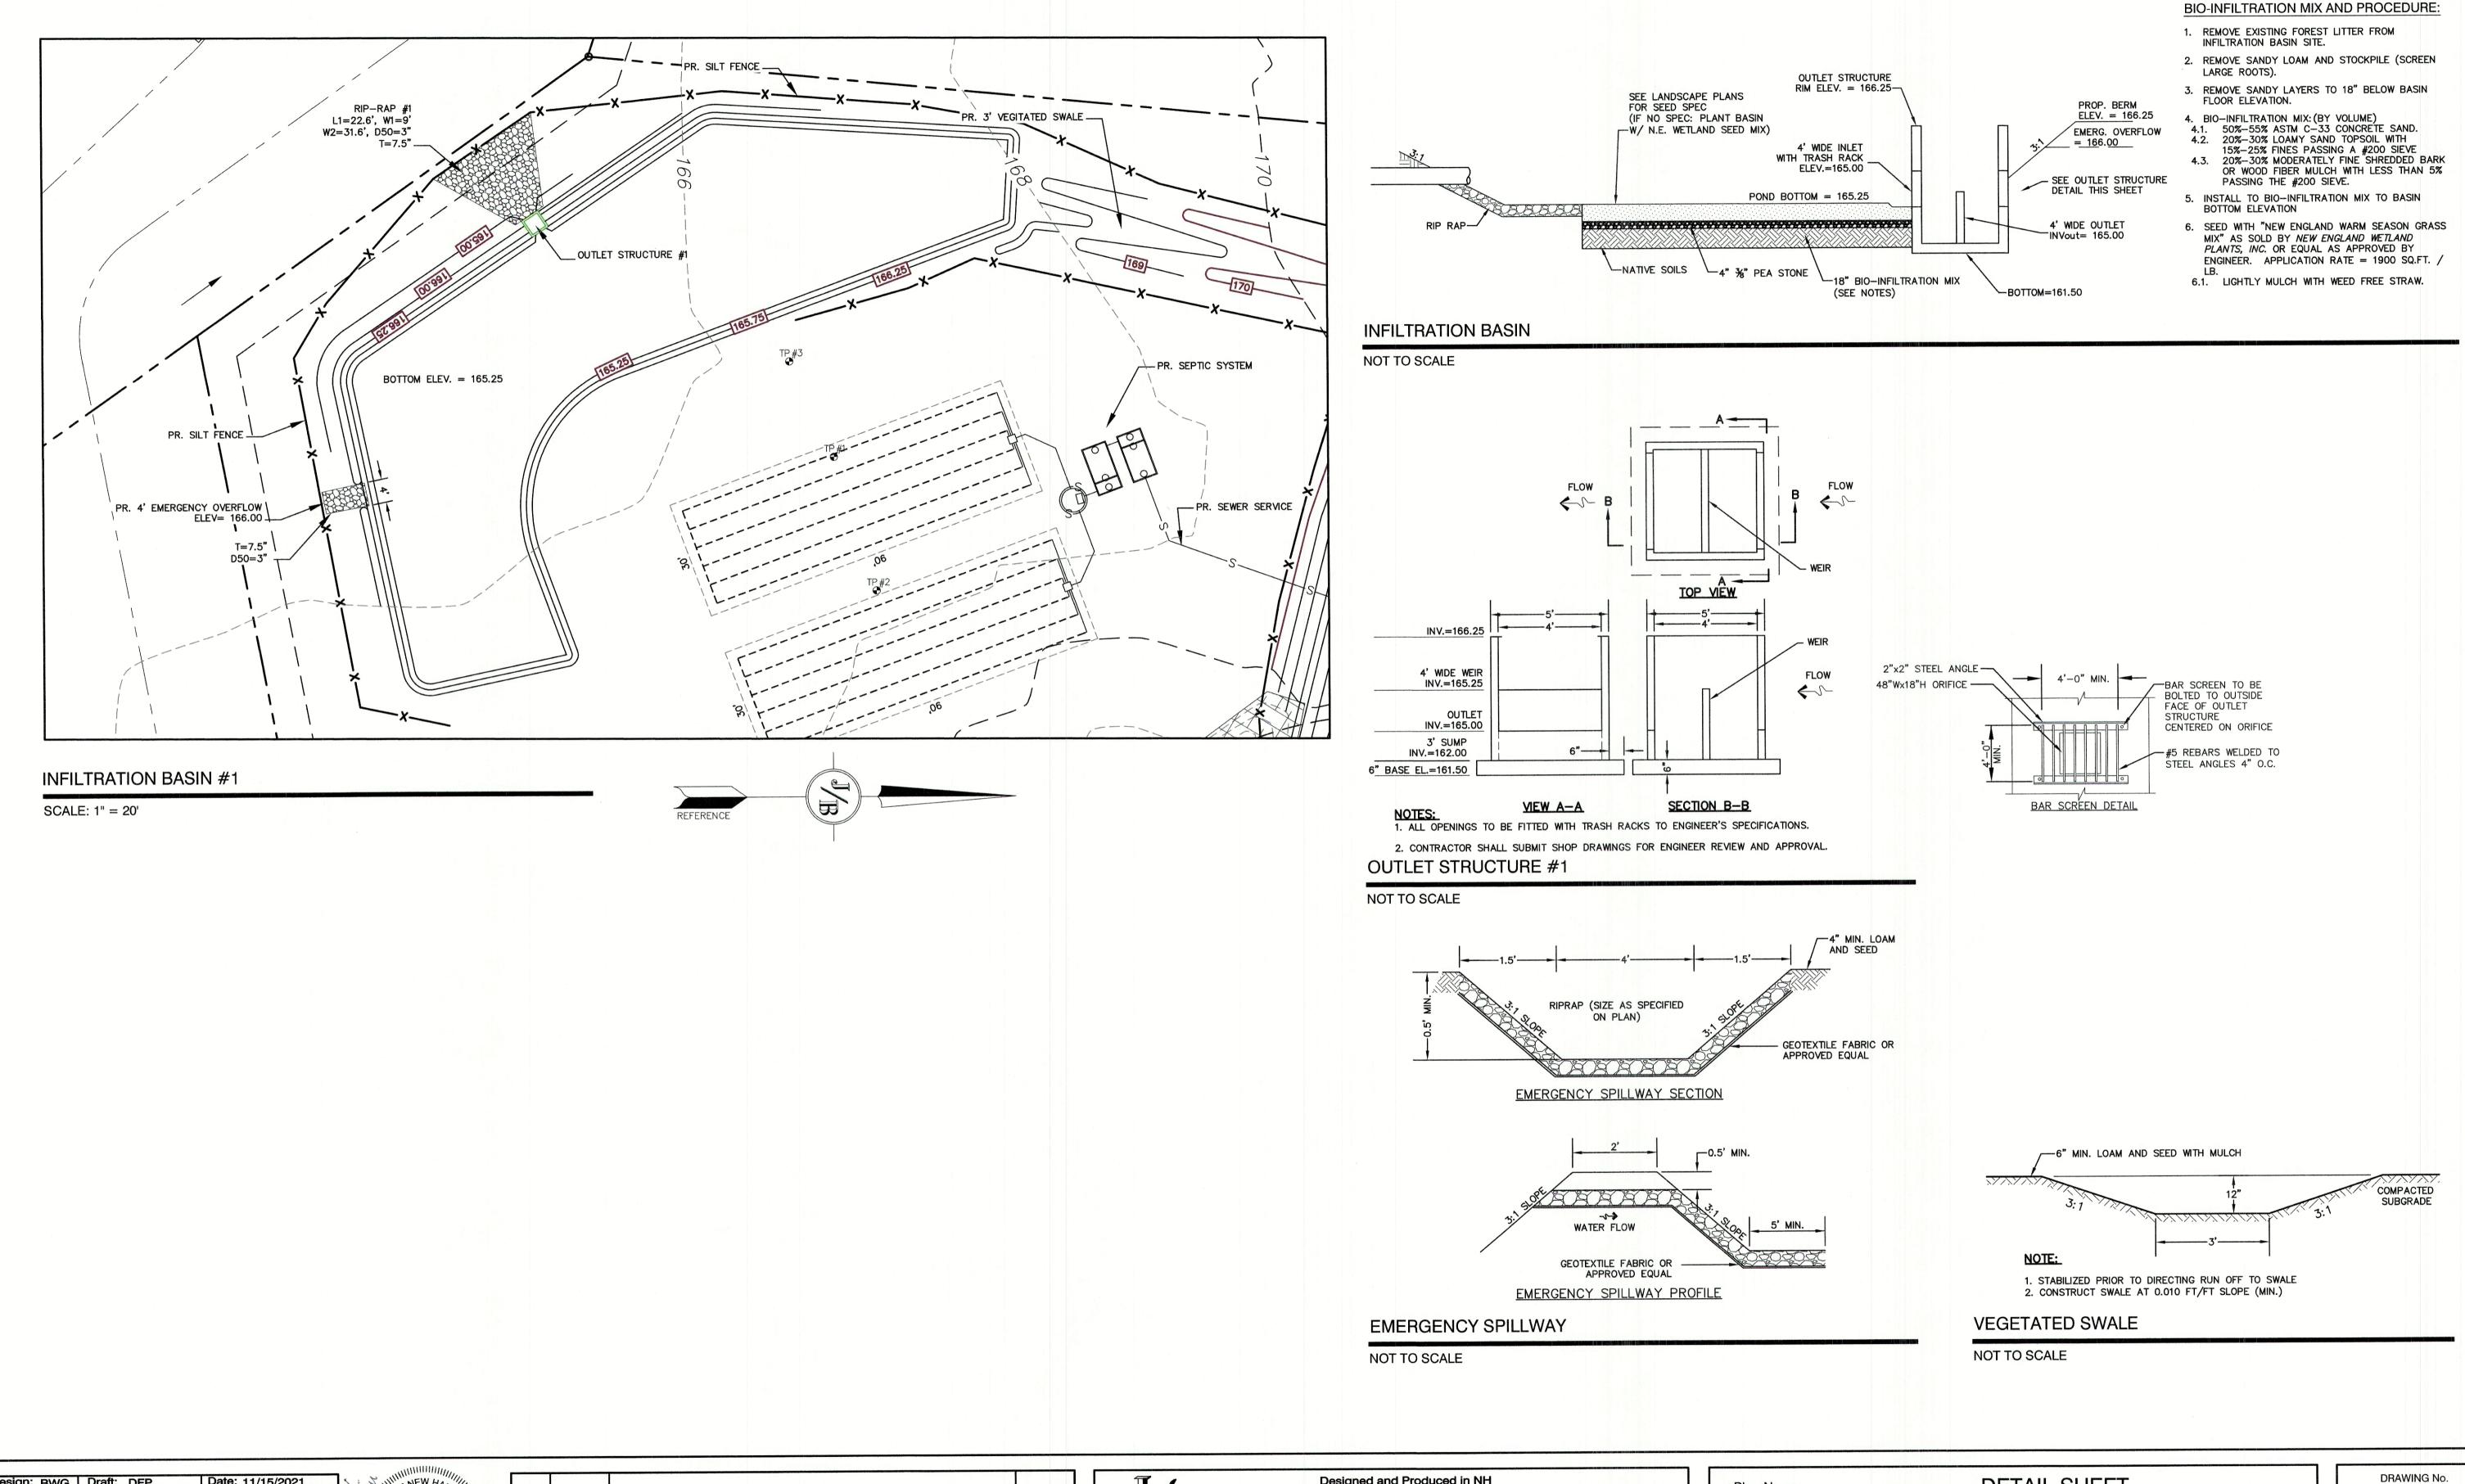

Design: BWG Draft: DFP Date: 11/15/2021
Checked: BWG Scale: AS SHOWN Project No.: 20631
Drawing Name: 20631-PLAN.dwg
THIS PLAN SHALL NOT BE MODIFIED WITHOUT WRITTEN
PERMISSION FROM JONES & BEACH ENGINEERS, INC. (JBE).
ANY ALTERATIONS, AUTHORIZED OR OTHERWISE, SHALL BE
AT THE USER'S SOLE RISK AND WITHOUT LIABILITY TO JBE.



1	11/15/21	REVISED PER PB COMMENTS	BWG
0	10/6/21	ISSUED FOR REVIEW	BWG
REV.	DATE	REVISION	BY

Bones & Beach Engineers, Inc.

85 Portsmouth Ave. Civil Engineering Services 603-772-4746

85 Portsmouth Ave. Civil Engineering Services 603-772-4746
PO Box 219
Stratham, NH 03885


Civil Engineering Services FAX: 603-772-0227
E-MAIL: JBE@JONESANDBEACH.COM

	Plan Name:	DETAIL SHEET
	Project:	PPM TOWNHOMES SPAULDING ROAD, FREMONT, NH
Owner of Record:		PPM FREMONT HOLDING, LLC 326 MAIN STREET FREMONT, NH 03044

D2
SHEET 11 OF 12
JBE PROJECT NO. 20631

TEMPORARY EROSION CONTROL NOTES

- 1. THE SMALLEST PRACTICAL AREA OF LAND SHALL BE EXPOSED AT ANY ONE TIME. AT NO TIME SHALL AN AREA IN EXCESS OF 5 ACRES BE EXPOSED AT ANY ONE TIME BEFORE DISTURBED AREAS ARE STABILIZED.
- EROSION, SEDIMENT AND DETENTION MEASURES SHALL BE INSTALLED AS SHOWN ON THE PLANS AND AT LOCATIONS AS REQUIRED, DIRECTED BY THE ENGINEER.
- ALL DISTURBED AREAS (INCLUDING POND AREAS BELOW THE PROPOSED WATERLINE) SHALL BE RETURNED TO PROPOSED GRADES AND ELEVATIONS. DISTURBED AREAS SHALL BE LOAMED WITH A MINIMUM OF 6" OF SCREENED ORGANIC LOAM AND SEEDED WITH SEED MIXTURE 'C' AT A RATE NOT LESS THAN 1.10 POUNDS OF SEED PER 1,000 S.F. OF AREA (48 LBS. / ACRE).
- SILT FENCES AND OTHER BARRIERS SHALL BE INSPECTED EVERY SEVEN CALENDAR DAYS AND WITHIN 24 HOURS OF A RAINFALL OF 0.5" OR GREATER. ALL DAMAGED AREAS SHALL BE REPAIRED, AND SEDIMENT DEPOSITS SHALL PERIODICALLY BE REMOVED
- AFTER ALL DISTURBED AREAS HAVE BEEN STABILIZED, THE TEMPORARY EROSION CONTROL MEASURES SHALL BE REMOVED AND THE AREA DISTURBED BY THE REMOVAL SMOOTHED AND RE-VEGETATED.
- AREAS MUST BE SEEDED AND MULCHED OR OTHERWISE PERMANENTLY STABILIZED WITHIN 3 DAYS OF FINAL GRADING, OR TEMPORARILY STABILIZED WITHIN 14 DAYS OF THE INITIAL DISTURBANCE OF SOIL, ALL AREAS SHALL BE STABILIZED WITHIN 45 DAYS OF INITIAL DISTURBANCE.
- ALL PROPOSED VEGETATED AREAS THAT DO NOT EXHIBIT A MINIMUM OF 85 PERCENT VEGETATIVE GROWTH BY OCTOBER 15, OR WHICH ARE DISTURBED AFTER OCTOBER 15, SHALL BE STABILIZED BY SEEDING AND INSTALLING NORTH AMERICAN GREEN S75 EROSION CONTROL BLANKETS (OR AN EQUIVALENT APPROVED IN WRITING BY THE ENGINEER) ON SLOPES GREATER THAN 3:1, AND SEEDING AND PLACING 3 TO 4 TONS OF MULCH PER ACRE, SECURED WITH ANCHORED NETTING, ELSEWHERE. THE INSTALLATION OF EROSION CONTROL BLANKETS OR MULCH AND NETTING SHALL NOT OCCUR OVER ACCUMULATED SNOW OR ON FROZEN GROUND AND SHALL BE COMPLETED IN ADVANCE OF THAW OR SPRING MELT EVENTS.
- ALL DITCHES OR SWALES WHICH DO NOT EXHIBIT A MINIMUM OF 85 PERCENT VEGETATIVE GROWTH BY OCTOBER 15, OR WHICH ARE DISTURBED AFTER OCTOBER 15, SHALL BE STABILIZED TEMPORARILY WITH STONE OR EROSION CONTROL BLANKETS APPROPRIATE FOR THE DESIGN FLOW CONDITIONS.
- 9. AFTER OCTOBER 15th, INCOMPLETE ROAD OR PARKING SURFACES, WHERE WORK HAS STOPPED FOR THE WINTER SEASON, SHALL BE PROTECTED WITH A MINIMUM OF 3" OF CRUSHED GRAVEL PER NHDOT ITEM 304.3.
- 10. AN AREA SHALL BE CONSIDERED STABLE IF ONE OF THE FOLLOWING HAS OCCURRED:
 - a. BASE COURSE GRAVELS HAVE BEEN INSTALLED IN AREAS TO BE PAVED;
 - b. A MINIMUM OF 85% VEGETATED GROWTH HAS BEEN ESTABLISHED;
 - C. A MINIMUM OF 3" OF NON-EROSIVE MATERIAL SUCH STONE OR RIPRAP HAS BEEN INSTALLED; OR
 - d. EROSION CONTROL BLANKETS HAVE BEEN PROPERLY INSTALLED.
- 11. FUGITIVE DUST CONTROL IS REQUIRED TO BE CONTROLLED IN ACCORDANCE WITH ENV-A 1000, AND THE PROJECT IS TO MEET THE REQUIREMENTS AND INTENT OF RSA 430:53 AND AGR 3800 RELATIVE TO INVASIVE SPECIES.
- 12. PRIOR TO BEGINNING CONSTRUCTION, THE CONTRACTOR'S NAME, ADDRESS, AND PHONE NUMBER SHALL BE SUBMITTED TO DES VIA EMAIL (SEE BELOW).
- 13. PRIOR TO CONSTRUCTION, A PHASING PLAN THAT DELINEATES EACH PHASE OF THE PROJECT SHALL BE SUBMITTED. ALL TEMPORARY SEDIMENT BASINS THAT WILL BE NEEDED FOR DEWATERING WORK AREAS SHALL BE LOCATED AND IDENTIFIED ON THIS
- 14. IN ORDER TO ENSURE THE STABILITY OF THE SITE AND EFFECTIVE IMPLEMENTATION OF THE SEDIMENT AND EROSION CONTROL MEASURES SPECIFIED IN THE PLANS FOR THE DURATION OF CONSTRUCTION, THE CONTRACTOR SHALL BE IN STRICT COMPLIANCE WITH THE FOLLOWING INSPECTION AND MAINTENANCE REQUIREMENTS IN ADDITION TO THOSE CALLED FOR IN THE SWPPP:
 - a. A CERTIFIED PROFESSIONAL IN EROSION AND SEDIMENT CONTROL OR A PROFESSIONAL ENGINEER LICENSED IN THE STATE OF NEW HAMPSHIRE ("MONITOR") SHALL BE EMPLOYED TO INSPECT THE SITE FROM THE START OF ALTERATION OF TERRAIN ACTIVITIES UNTIL THE SITE IS STABLE
 - b. DURING THIS PERIOD, THE MONITOR SHALL INSPECT THE SUBJECT SITE AT LEAST ONCE A WEEK, AND IF POSSIBLE, DURING ANY 1/2 INCH OR GREATER RAIN EVENT (I.E. 1/2 INCH OF PRECIPITATION OR MORE WITHIN A 24 HOUR PERIOD). IF UNABLE TO BE PRESENT DURING SUCH A STORM, THE MONITOR SHALL INSPECT THE SITE WITHIN 24 HOURS OF THIS
 - c. THE MONITOR SHALL PROVIDE TECHNICAL ASSISTANCE AND RECOMMENDATIONS TO THE CONTRACTOR ON THE APPROPRIATE BEST MANAGEMENT PRACTICES FOR EROSION AND SEDIMENT CONTROLS REQUIRED TO MEET THE REQUIREMENTS OF RSA 485 A:17 AND ALL APPLICABLE DES PERMIT CONDITIONS.

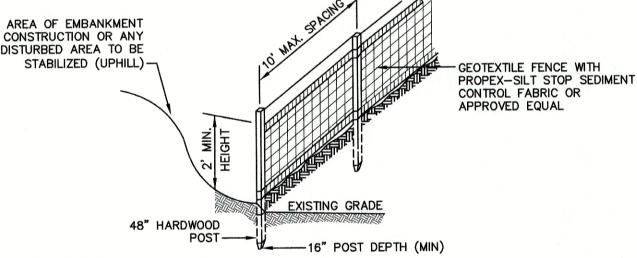

CONSTRUCTION SPECIFICATIONS:

- WOVEN FABRIC FENCE TO BE FASTENED SECURELY TO FENCE POSTS WITH WIRE TIES OR STAPLES. FILTER CLOTH SHALL BE FASTENED TO WOVEN WIRE EVERY 24" AT TOP, MID AND BOTTOM AND EMBEDDED IN THE GROUND A MINIMUM OF 8" AND THEN COVERED WITH SOIL.
- . THE FENCE POSTS SHALL BE A MINIMUM OF 48" LONG, SPACED A MAXIMUM 10' APART, AND DRIVEN A MINIMUM OF 16" INTO THE GROUND.
- WHEN TWO SECTIONS OF FILTER CLOTH ADJOIN EACH OTHER, THE ENDS OF THE FABRIC SHALL BE OVERLAPPED 6", FOLDED AND STAPLED TO PREVENT SEDIMENT FROM BY-PASSING.
- MAINTENANCE SHALL BE PERFORMED AS NEEDED AND SEDIMENT REMOVED AND PROPERLY DISPOSED OF WHEN IT IS 6" DEEP OR VISIBLE 'BULGES' DEVELOP IN THE SILT FENCE.


Date: 11/15/2021

- . PLACE THE ENDS OF THE SILT FENCE UP CONTOUR TO PROVIDE FOR SEDIMENT STORAGE.
- SILT FENCE SHALL REMAIN IN PLACE FOR 24 MONTHS.

SILT FENCE

NOT TO SCALE

Design: BWG | Draft: DFP

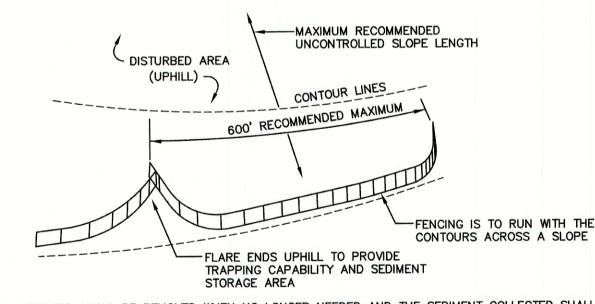

7. SILT FENCES SHALL BE REMOVED WHEN NO LONGER NEEDED AND THE SEDIMENT COLLECTED SHALL BE DISPOSED AS DIRECTED BY THE ENGINEER. THE AREA DISTURBED BY THE REMOVAL SHALL BE SMOOTHED AND REVEGETATED.

MAINTENANCE:

- 1. SILT FENCES SHALL BE INSPECTED IMMEDIATELY AFTER EACH RAINFALL AND AT LEAST DAILY DURING PROLONGED RAINFALL. ANY REPAIRS THAT ARE REQUIRED SHALL BE DONE IMMEDIATELY.
- 2. IF THE FABRIC ON A SILT FENCE SHOULD DECOMPOSE OR BECOME INEFFECTIVE DURING THE EXPECTED LIFE OF THE FENCE, THE FABRIC SHALL BE REPLACED PROMPTLY.
- 3. SEDIMENT DEPOSITS SHOULD BE INSPECTED AFTER EVERY STORM EVENT. THE DEPOSITS SHOULD BE REMOVED WHEN THEY REACH APPROXIMATELY ONE HALF THE HEIGHT OF THE BARRIER.
- 4. SEDIMENT DEPOSITS THAT ARE REMOVED, OR LEFT IN PLACE AFTER THE FABRIC HAS BEEN REMOVED, SHALL BE GRADED TO CONFORM WITH THE EXISTING TOPOGRAPHY AND VEGETATED.

SEEDING SPECIFICATIONS

- 1. GRADING AND SHAPING A. SLOPES SHALL NOT BE STEEPER THAN 2:1 WITHOUT APPROPRIATE EROSION CONTROL MEASURES AS
- SPECIFIED ON THE PLANS (3:1 SLOPES OR FLATTER ARE PREFERRED). B. WHERE MOWING WILL BE DONE, 3:1 SLOPES OR FLATTER ARE RECOMMENDED.

- 2. SEEDBED PREPARATION A. SURFACE AND SEEPAGE WATER SHOULD BE DRAINED OR DIVERTED FROM THE SITE TO PREVENT DROWNING 3. INSTALL SILT FENCING, HAY BALES AND CONSTRUCTION ENTRANCES PRIOR TO THE START OF CONSTRUCTION. THESE ARE TO BE OR WINTER KILLING OF THE PLANTS.
- B. STONES LARGER THAN 4 INCHES AND TRASH SHOULD BE REMOVED BECAUSE THEY INTERFERE WITH SEEDING AND FUTURE MAINTENANCE OF THE AREA. WHERE FEASIBLE, THE SOIL SHOULD BE TILLED TO A DEPTH OF ABOUT 4 INCHES TO PREPARE A SEEDBED AND FERTILIZER AND LIME MIXED INTO THE SOIL. THE SEEDBED SHOULD BE LEFT IN A REASONABLY FIRM AND SMOOTH CONDITION. THE LAST TILLAGE OPERATION SHOULD BE PERFORMED ACROSS THE SLOPE WHEREVER PRACTICAL.

3. ESTABLISHING A STAND

- A. LIME AND FERTILIZER SHOULD BE APPLIED PRIOR TO OR AT THE TIME OF SEEDING AND INCORPORATED INTO THE SOIL. TYPES AND AMOUNTS OF LIME AND FERTILIZER SHOULD BE BASED ON AN EVALUATION OF SOIL TESTS. WHEN A SOIL TEST IS NOT AVAILABLE, THE FOLLOWING MINIMUM AMOUNTS SHOULD BE
- AGRICULTURAL LIMESTONE, 2 TONS PER ACRE OR 100 LBS. PER 1,000 SQ.FT.
- NITROGEN(N), 50 LBS. PER ACRE OR 1.1 LBS. PER 1,000 SQ.FT. PHOSPHATE(P205), 100 LBS. PER ACRE OR 2.2 LBS. PER 1,000 SQ.FT.
- POTASH(K20), 100 LBS. PER ACRE OR 2.2 LBS. PER 1,000 SQ.FT. (NOTE: THIS IS THE EQUIVALENT OF 500 LBS. PER ACRE OF 10-20-20 FERTILIZER OR 1,000 LBS. PER ACRE OF 5-10-10.)
- B. SEED SHOULD BE SPREAD UNIFORMLY BY THE METHOD MOST APPROPRIATE FOR THE SITE. METHODS INCLUDE BROADCASTING, DRILLING AND HYDROSEEDING. WHERE BROADCASTING IS USED, COVER SEED WITH .25 INCH OF SOIL OR LESS, BY CULTIPACKING OR RAKING.
- C. REFER TO THE 'SEEDING GUIDE' AND 'SEEDING RATES' TABLES ON THIS SHEET FOR APPROPRIATE SEED MIXTURES AND RATES OF SEEDING. ALL LEGUMES (CROWNVETCH, BIRDSFOOT, TREFOIL AND FLATPEA) MUST BE INOCULATED WITH THEIR SPECIFIC INOCULANT PRIOR TO THEIR INTRODUCTION TO THE SITE.
- D. WHEN SEEDED AREAS ARE MULCHED, PLANTINGS MAY BE MADE FROM EARLY SPRING TO EARLY OCTOBER. WHEN SEEDED AREAS ARE NOT MULCHED, PLANTINGS SHOULD BE MADE FROM EARLY SPRING TO MAY 20th OR FROM AUGUST 10th TO SEPTEMBER 1st.

- A. HAY, STRAW, OR OTHER MULCH, WHEN NEEDED, SHOULD BE APPLIED IMMEDIATELY AFTER SEEDING. B. MULCH WILL BE HELD IN PLACE USING APPROPRIATE TECHNIQUES FROM THE BEST MANAGEMENT PRACTICE FOR MULCHING. HAY OR STRAW MULCH SHALL BE PLACED AT A RATE OF 90 LBS PER 1000 S.F.
- 5. MAINTENANCE TO ESTABLISH A STAND
- A. PLANTED AREAS SHOULD BE PROTECTED FROM DAMAGE BY FIRE, GRAZING, TRAFFIC, AND DENSE WEED
- B. FERTILIZATION NEEDS SHOULD BE DETERMINED BY ONSITE INSPECTIONS. SUPPLEMENTAL FERTILIZER IS USUALLY THE KEY TO FULLY COMPLETE THE ESTABLISHMENT OF THE STAND BECAUSE MOST PERENNIALS TAKE 2 TO 3 YEARS TO BECOME FULLY ESTABLISHED.
- C. IN WATERWAYS, CHANNELS, OR SWALES WHERE UNIFORM FLOW CONDITIONS ARE ANTICIPATED, ANNUAL MOWING MAY BE NECESSARY TO CONTROL GROWTH OF WOODY VEGETATION.

USE	SEEDING MIXTURE 1/	DROUGHTY	WELL DRAINED	MODERATELY WELL DRAINED	POORLY DRAINED
STEEP CUTS AND FILLS, BORROW AND DISPOSAL	A B C	FAIR POOR POOR	GOOD GOOD GOOD	GOOD FAIR EXCELLENT	FAIR FAIR GOOD
AREAS	D	FAIR	EXCELLENT	EXCELLENT	POOR
WATERWAYS, EMERGENC SPILLWAYS, AND OTHER CHANNELS WITH FLOWING WATER.		GOOD GOOD	GOOD EXCELLENT	GOOD EXCELLENT	FAIR FAIR
LIGHTLY USED PARKING LOTS, ODD AREAS, UNUSED LANDS, AND LOW INTENSITY USE RECREATION SITES.	A B C	GOOD GOOD GOOD	GOOD GOOD EXCELLENT	GOOD FAIR EXCELLENT	FAIR POOR FAIR
PLAY AREAS AND ATHLETIC FIELDS. (TOPSOIL IS ESSENTIAL FOR GOOD TURF.)	E F	FAIR FAIR	EXCELLENT EXCELLENT	EXCELLENT EXCELLENT	2/ 2/

GRAVEL PIT, SEE NH-PM-24 IN APPENDIX FOR RECOMMENDATION REGARDING RECLAMATION OF SAND AND GRAVEL PITS.

REFER TO SEEDING MIXTURES AND RATES IN TABLE BELOW. 27 POORLY DRAINED SOILS ARE NOT DESIRABLE FOR USE AS PLAYING AREA AND ATHLETIC FIELDS.

NOTE: TEMPORARY SEED MIX FOR STABILIZATION OF TURF SHALL BE WINTER RYE OR OATS AT A RATE OF 2.5 LBS. PER 1000 S.F. AND SHALL BE PLACED PRIOR TO OCTOBER 15th, IF PERMANENT SEEDING NOT

SEEDING GUIDE

MIXTURE	POUNDS PER ACRE	POUNDS 1 1.000 Sq.
A. TALL FESCUE CREEPING RED FESCUE RED TOP TOTAL	20 20 2 42	0.45 0.45 0.05 0.95
B. TALL FESCUE CREEPING RED FESCUE CROWN VETCH OR	15 10 15	0.35 0.25 0.35
FLAT PEA TOTAL	30 40 OR 55	0.75 0.95 OR 1.
C. TALL FESCUE CREEPING RED FESCUE BIRDS FOOT TREFOIL TOTAL	20 20 <u>8</u> 48	0.45 0.45 <u>0.20</u> 1.10
D. TALL FESCUE FLAT PEA TOTAL	20 30 50	0.45 0.75 1.20
E. CREEPING RED FESCUE 1/ KENTUCKY BLUEGRASS 1/ TOTAL	50 50 100	1.15 1.15 2.30
F. TALL FESCUE 1	150	3.60

SEEDING RATES

Jones & Beach Engineers, Inc.

Designed and Produced in NH


85 Portsmouth Ave. Civil Engineering Services

PO Box 219

Stratham, NH 03885

CONSTRUCTION SEQUENCE

- 1. PRIOR TO THE START OF ANY ACTIVITY, IT IS THE RESPONSIBILITY OF THE SITE'S SITE DEVELOPER (OR OWNER) TO FILE A NOTICE OF INTENT (NOI) FORM WITH THE ENVIRONMENTAL PROTECTION AGENCY (EPA) IN ORDER TO GAIN COVERAGE UNDER THE NPDES GENERAL PERMIT FOR STORM WATER DISCHARGES FROM CONSTRUCTION ACTIVITIES. A PRE CONSTRUCTION MEETING IS TO BE HELD WITH ALL DEPARTMENT HEADS PRIOR TO THE START OF CONSTRUCTION.
- 2. CUT AND REMOVE TREES IN CONSTRUCTION AREA AS REQUIRED OR DIRECTED.
 - MAINTAINED UNTIL THE FINAL PAVEMENT SURFACING AND LANDSCAPING AREAS ARE ESTABLISHED.
- CLEAR, CUT, GRUB AND DISPOSE OF DEBRIS IN APPROVED FACILITIES. THIS INCLUDES ANY REQUIRED DEMOLITION OF EXISTING STRUCTURES, UTILITIES, ETC.
- CONSTRUCT AND/OR INSTALL TEMPORARY OR PERMANENT SEDIMENT AND/OR DETENTION BASIN(S) AS REQUIRED. THESE FACILITIES SHALL BE INSTALLED AND STABILIZED PRIOR TO DIRECTING RUN-OFF TO THEM.
- 6. STRIP LOAM AND PAVEMENT, OR RECLAIM EXISTING PAVEMENT WITHIN LIMITS OF WORK PER THE RECOMMENDATIONS OF THE PROJECT ENGINEER AND STOCKPILE EXCESS MATERIAL. STABILIZE STOCKPILE AS NECESSARY.
- PERFORM PRELIMINARY SITE GRADING IN ACCORDANCE WITH THE PLANS, INCLUDING THE CONSTRUCTION OF ANY RETAINING WALLS
- AND SOUND WALLS.
- 8. PREPARE BUILDING PAD(S) TO ENABLE BUILDING CONSTRUCTION TO BEGIN.
- INSTALL THE SEWER AND DRAINAGE SYSTEMS FIRST, THEN ANY OTHER UTILITIES IN ACCORDANCE WITH THE PLAN AND DETAILS. ANY CONFLICTS BETWEEN UTILITIES ARE TO BE RESOLVED WITH THE INVOLVEMENT AND APPROVAL OF THE ENGINEER.
- 10. ALL SWALES AND DRAINAGE STRUCTURES ARE TO BE CONSTRUCTED AND STABILIZED PRIOR TO HAVING RUN-OFF DIRECTED TO THEM.
- 11. DAILY, OR AS REQUIRED, CONSTRUCT TEMPORARY BERMS, DRAINAGE DITCHES, CHECK DAMS, SEDIMENT TRAPS, ETC., TO PREVENT EROSION ON THE SITE AND PREVENT ANY SILTATION OF ABUTTING WATERS AND/OR PROPERTY.
- 12. PERFORM FINAL FINE GRADING, INCLUDING PLACEMENT OF 'SELECT' SUBGRADE MATERIALS.
- 13. PAVE ALL PARKING LOTS AND ROADWAYS WITH INITIAL 'BASE COURSE'.
- 14. PERFORM ALL REMAINING SITE CONSTRUCTION (i.e. BUILDING, CURBING, UTILITY CONNECTIONS, ETC.).
- 15. LOAM AND SEED ALL DISTURBED AREAS AND INSTALL ANY REQUIRED SEDIMENT AND EROSION CONTROL FACILITIES (i.e. RIP RAP, EROSION CONTROL BLANKETS, ETC.).
- 16. FINISH PAVING ALL ROADWAYS AND PARKING AREAS WITH 'FINISH' COURSE.
- 17. ALL ROADWAYS AND PARKING LOTS SHALL BE STABILIZED WITHIN 72 HOURS OF ACHIEVING FINISHED GRADE.
- 18. ALL CUT AND FILL SLOPES SHALL BE SEEDED/LOAMED WITHIN 72 HOURS OF ACHIEVING FINISHED GRADE.
- 19. COMPLETE PERMANENT SEEDING AND LANDSCAPING.
- 20. REMOVE TEMPORARY EROSION CONTROL MEASURES AFTER SEEDING AREAS HAVE BEEN 75%-85% ESTABLISHED AND SITE IMPROVEMENTS ARE COMPLETE. SMOOTH AND RE-VEGETATE ALL DISTURBED AREAS.
- 21. CLEAN SITE AND ALL DRAINAGE STRUCTURES, PIPES AND SUMPS OF ALL SILT AND DEBRIS.
- 22. INSTALL ALL PAINTED PAVEMENT MARKINGS AND SIGNAGE PER THE PLANS AND DETAILS.
- 23. ALL EROSION CONTROLS SHALL BE INSPECTED WEEKLY AND AFTER EVERY HALF-INCH OF RAINFALL.
- 24. UPON COMPLETION OF CONSTRUCTION, IT IS THE RESPONSIBILITY OF THE CONTRACTOR TO NOTIFY ANY RELEVANT PERMITTING AGENCIES THAT THE CONSTRUCTION HAS BEEN FINISHED IN A SATISFACTORY MANNER.

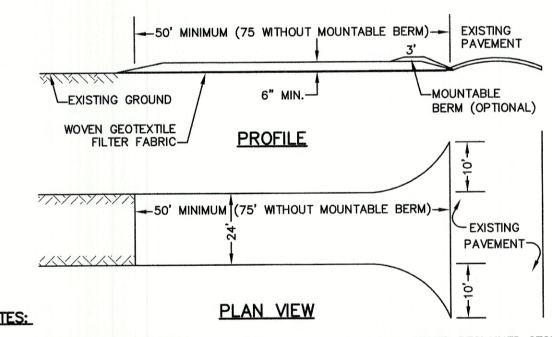

1. STONE FOR STABILIZED CONSTRUCTION ENTRANCE SHALL BE 3 INCH STONE, RECLAIMED STONE, OR RECYCLED CONCRETE EQUIVALENT.

2. THE LENGTH OF THE STABILIZED ENTRANCE SHALL NOT BE LESS THAN 50 FEET, 75' WITHOUT A MOUNTABLE BERM, AND EXCEPT FOR A SINGLE RESIDENTIAL LOT WHERE A 30 FOOT MINIMUM LENGTH

3. THICKNESS OF THE STONE FOR THE STABILIZED ENTRANCE SHALL NOT BE LESS THAN 6 INCHES.
4. THE WIDTH OF THE ENTRANCE SHALL NOT BE LESS THAN THE FULL WIDTH OF THE ENTRANCE WHERE INGRESS OR EGRESS OCCURS, OR 10 FEET, WHICHEVER IS GREATER.

5. GEOTEXTILE FILTER FABRIC SHALL BE PLACED OVER THE ENTIRE AREA PRIOR TO PLACING THE STONE. FILTER FABRIC IS NOT REQUIRED FOR A SINGLE FAMILY RESIDENTIAL LOT. 6. ALL SURFACE WATER THAT IS FLOWING TO OR DIVERTED TOWARD THE CONSTRUCTION ENTRANCE SHALL B PIPED BENEATH THE ENTRANCE. IF PIPING IS IMPRACTICAL, A STONE BERM WITH 5:1 SLOPES THAT CAN BE

CROSSED BY VEHICLES MAY BE SUBSTITUTED FOR THE PIPE. 7. THE ENTRANCE SHALL BE MAINTAINED IN A CONDITION THAT WILL PREVENT TRACKING OR FLOWING OF SEDIMENT ONTO THE PUBLIC RIGHT-OF-WAY. THIS MAY REQUIRE PERIODIC TOP DRESSING WITH ADDITIONAL STONE AS CONDITIONS DEMAND AND REPAIR AND/OR CLEAN OUT OF ANY MEASURES USED TO TRAP SEDIMENT. ALL SEDIMENT SPILLED, WASHED, OR TRACKED ONTO THE PUBLIC RIGHT-OF-WAY MUST BE REMOVED PROMPTLY.

STABILIZED CONSTRUCTION ENTRANCE

NOT TO SCALE

EROSION AND SEDIMENT CONTROL DETAILS

Project:

603-772-4746

FAX: 603-772-0227

E-MAIL: JBE@JONESANDBEACH.COM

PPM TOWNHOMES SPAULDING ROAD, FREMONT, NH

DRAWING No.

SHEET 12 OF 12

JBE PROJECT NO. 20631

PPM FREMONT HOLDING, LLC Owner of Record 326 MAIN STREET FREMONT, NH 03044

Checked: BWG | Scale: AS SHOWN | Project No.: 20631 Drawing Name: 20631-PLAN.dwg THIS PLAN SHALL NOT BE MODIFIED WITHOUT WRITTEN ERMISSION FROM JONES & BEACH ENGINEERS, INC. (JBE) ANY ALTERATIONS, AUTHORIZED OR OTHERWISE, SHALL BE AT THE USER'S SOLE RISK AND WITHOUT LIABILITY TO JBE



N HAME			
N HAMOCHIANI			
12535 H	1	11/15/21	REVI
NSEO CHANNE	0	10/6/21	
NSED WALE WALE	REV.	DATE	