SITE PLAN LIBERTY LANTERN ESTATES TAX MAP 2 LOT 70 MAIN STREET, FREMONT, NH

SHEET INDEX

- CS COVER SHEET
- OVERALL EXISTING CONDITIONS PLAN C1
- C1A EXISTING CONDITIONS PLAN
- CONDO SITE PLAN A1
- C2 OVERALL SITE PLAN
- SITE PLAN C2A
- OVERALL GRADING AND DRAINAGE PLAN C3

C3A-C3B GRADING AND DRAINAGE PLAN

- UTILITY PLAN C4
- PLAN AND PROFILE P1
- LANDSCAPING PLAN L1
- HIGHWAY ACCESS PLAN H1
- SEPTIC DETAIL SHEETS S1-S4
- D1-D3 DETAIL SHEETS
- EROSION AND SEDIMENT CONTROL DETAILS E1

APPLICANT / DEVELOPER

HAUS EMILY, LLC 56 WESTVILLE ROAD, UNIT 4 PLAISTOW, NH 03865 (603) 382-1715 CONTACT: GARY DENSEN

CIVIL ENGINEER / SURVEYOR

JONES & BEACH ENGINEERS, INC. **85 PORTSMOUTH AVENUE** PO BOX 219 STRATHAM, NH 03885 (603) 772-4746 CONTACT: BARRY GIER EMAIL: BGIER@JONESANDBEACH.COM

OWNER OF RECORD TIMOTHY AND GERALDINE PALMER

706 MAIN STREET FREMONT, NH 03044 CONTACT: TIMOTHY GERALDINE

WETLAND CONSULTANT

GZA GEOENVIRONMENTAL, INC. 5 COMMERCE PARK NORTH, SUITE 201 BEDFORD, NH 03110 (603) 430-9282 CONTACT: JAMES LONG

ELECTRIC **EVERSOURCE** 740 N COMMERCIAL ST PO BOX 330 MANCHESTER, NH 03105-0330 (800) 662-7764

TELEPHONE


CONSOLIDATED COMMUNICATIONS 1575 GREENLAND ROAD GREENLAND, NH 03840 (603) 427-5525

CABLE TV

COMCAST COMMUNICATION CORPORATION 334-B CALEF HIGHWAY EPPING, NH 03042-2325 (603) 679-5695

Design: BWG	Draft: DFP	Date: 12/17/21
Checked: BWG	Scale: AS NOTE	D Project No.: 20724
Drawing Name:	20724-PLAN.dwg	
	NOT BE MODIFIED W	
PERMISSION FRO	M JONES & BEACH E	NGINEERS, INC. (JBE).
ANY ALTERATION	S, AUTHORIZED OR C	OTHERWISE, SHALL BE
AT THE USER'S SO	OLE RISK AND WITHO	OUT LIABILITY TO JBE.

				Designed and Produced in NH	Plan Name:
2	12/6/21	REVISED PER PB COMMENTS	BWG	B Jones & Beach Engineers, Inc.	Project:
1	11/22/21	REVISED PER TECHNICAL REVIEW	BWG	85 Portsmouth Ave. Civil Engineering Services 603-772-4746	
0	10/6/21	ISSUED FOR REVIEW	BWG	PO Box 219	Owner of Record:
REV.	DATE	REVISION	BY	Stratham, NH 03885 E-MAIL: JBE@JONESANDBEACH.COM	

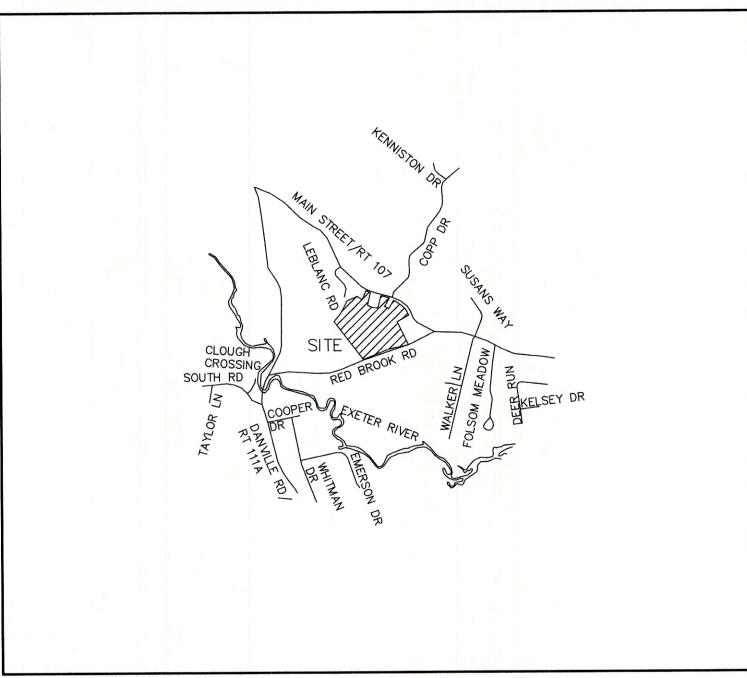

LOCUS MAP SCALE 1" = 2000'

PERMITS

TYPE OF PERMIT

NHDES SUBDIVISION PERMIT: NEW HAMPSHIRE DEPARTMENT OF **ENVIRONMENTAL SERVICES -**SUBSURFACE SYSTEMS BUREAU 29 HAZEN DRIVE, P.O. BOX 95 CONCORD, NEW HAMPSHIRE 03302-0095 (603) 271-3503 **RESPONSIBLE CONSULTANT: JONES & BEACH ENGINEERS, INC.**

NHDOT DRIVEWAY PERMIT: **NEW HAMPSHIRE DEPARTMENT OF** TRANSPORTATION, DISTRICT SIX P.O. BOX 740 **DURHAM, NEW HAMPSHIRE 03824** (603) 868-1133 **RESPONSIBLE CONSULTANT-**JONES & BEACH ENGINEERS, INC.

USEPA NPDES PHASE II CONSTRUCTION GENERAL PERMIT, NOTICE OF INTENT (NOI), AND NOTICE OF TERMINATION (NOT) TO BE FILED IN ACCORDANCE WITH FEDERAL AND LOCAL REGULATIONS PRIOR TO AND FOLLOWING CONSTRUCTION: EPA STORMWATER NOTICE PROCESSING CENTER MAIL CODE 4203M,

US EPA 1200 PENNSYLVANIA AVENUE, NW WASHINGTON, DC 20460 RESPONSIBLE CONSULTANT: JONES & BEACH ENGINEERS, INC.

STATUS

SUBMITTED:

PERMIT NO.

EXPIRATION:

DATED:

SUBMITTED:

PERMIT NO.

DATED:

EXPIRATION:

TYPE OF PERMIT

TOWN OF FREMONT SITE PLAN APPROVAL: SUBMITTED: TOWN OF FREMONT PLANNING BOARD 295 MAIN STREET **FREMONT, NEW HAMPSHIRE 03044** (603) 895-2226 **RESPONSIBLE CONSULTANT: JONES & BEACH ENGINEERS, INC.** NHDES ALTERATION OF TERRAIN PERMIT: **NEW HAMPSHIRE DEPARTMENT OF** ENVIRONMENTAL SERVICES - WATER DIVISION PERMIT NO. 29 HAZEN DRIVE, P.O. BOX 95 CONCORD, NEW HAMPSHIRE 03302-0095 (603) 271-3503 **RESPONSIBLE CONSULTANT:** JONES & BEACH ENGINEERS, INC. NHDES INDIVIDUAL SEPTIC PERMIT: **NEW HAMPSHIRE DEPARTMENT OF**

ENVIRONMENTAL SERVICES -SUBSURFACE SYSTEMS BUREAU 29 HAZEN DRIVE, P.O. BOX 95 CONCORD, NEW HAMPSHIRE 03302-0095 (603) 271-3503 **RESPONSIBLE CONSULTANT:** JONES & BEACH ENGINEERS, INC.

STATUS

PERMIT NO.

DATED:

EXPIRATION: SUBMITTED: DATED: EXPIRATION: SUBMITTED: PERMIT NO.

DATED: EXPIRATION:

PROJECT PARCEL TOWN OF FREMONT TAX MAP 2, LOT 70

OWNER TIMOTHY AND GERALDINE PALMER 706 MAIN STREET FREMONT, NH 03044 BK 5673, PG 0101

> APPLICANT HAUS EMILY, LLC 56 WESTVILLE ROAD, UNIT 4 PLAISTOW, NH 03865


> > TOTAL LOT AREA 1,322,917 SQ. FT. 30.37 ACRES

APPROVED - FREMONT, NH PLANNING BOARD

DATE:

COVER SHEET LIBERTY LANTERN ESTATES MAIN STREET, FREMONT, NH TIMOTHY & GERALDINE PALMER 706 MAIN STREET, FREMONT, NH 03044 DRAWING No. CS

SHEET 1 OF 21 JBE PROJECT NO. 20724

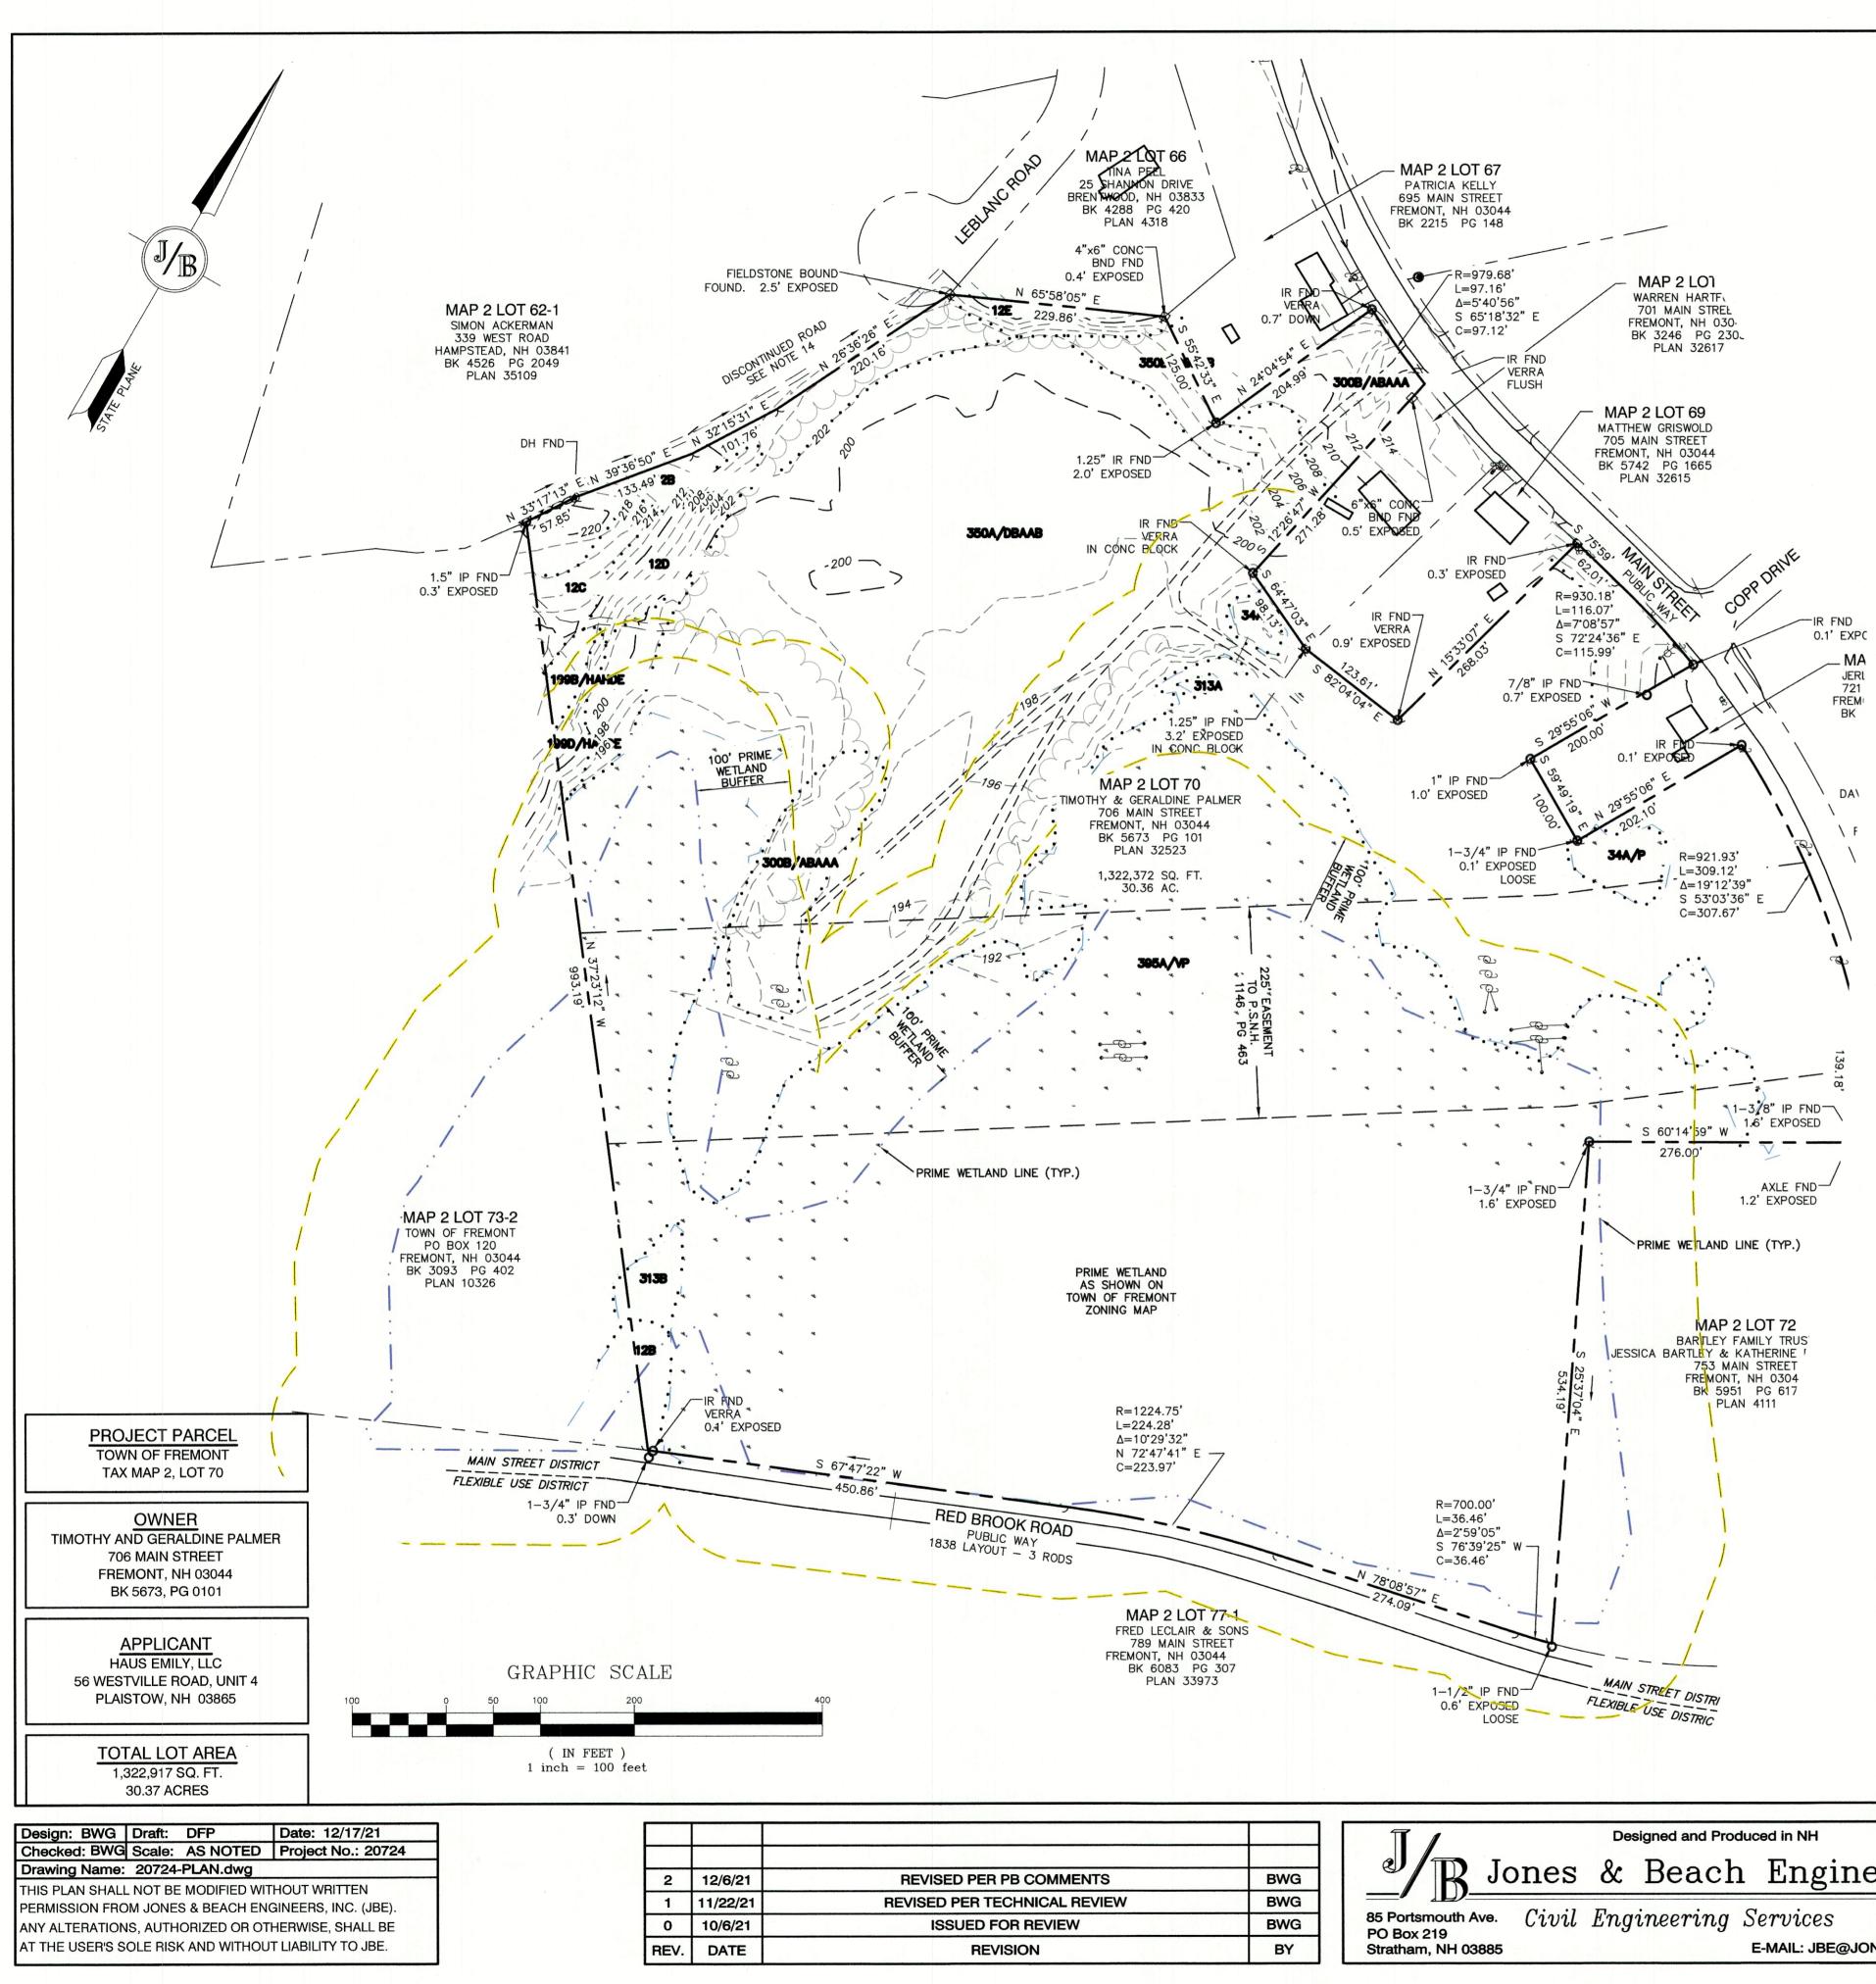

PLAN REFERENCES:

- 1. "PLAN OF SUB-DIVISION, DOROTHY A. PURINGTON, FREMONT, NEW HAMPSHIRE." DATED JUNE 1972. PREPARED BY K. E. MOORE & B. G. STAPLES, LAND SURVEYORS. R.C.R.D.
- 2. "SURVEY OF PROPERTY IN FREMONT, N.H. AND OWNED BY ROBERT BARTLEY." DATED SEPTEMBER 23, 1972. PREPARED BY R.S.L. LAYOUT & DESIGN. R.C.R.D. 4111.
- 3. "PLAN OF LAND IN FREMONT, NEW HAMPSHIRE OWNED BY WILLIAM J. LeBLANC." DATED SEPTEMBER 1973. PREPARED BY R. PENNEY R.C.R.D. 4318.
- 4. "SUB-DIVISION PLAN, LAND OF EDWARD SMITH, FREMONT, N.H." ORIGINAL SURVEY BY MOORE AND STAPLES, DOVER, N.H., REDRAWN BY T.W. CHESLEY, NORTHWOOD, N.H. DATED MARCH 1974, R.C.R.D. 4425.
- 5. "PLAN OF SUBDIVISION FOR JAMES F. WATKINS JR., RED BROOK ROAD, FREMONT, NEW HAMPSHIRE." DATED FEBRUARY 1981. PREPARED BY K. E. MOORE & B. G. STAPLES. R.C.R.D. 10326.
- 6. "PLAT OF LAND, MAIN STREET (NH RT 107), TAX MAP 2 LOT 70, FREMONT, NEW HAMPSHIRE FOR MAGNUSSON FARM, LLC." DATED JANUARY 21, 2005. PREPARED BY JAMES VERRA AND ASSOCIATES. R.C.R.D 32523.
- 7. "PLAT OF LAND, 701 MAIN STREET (NH RT 107), TAX MAP 2 LOT 68, FREMONT, NEW HAMPSHIRE FOR WARREN J. HARTFORD. DATED MAY 2, 2005. PREPARED BY JAMES VERRA AND ASSOCIATES. R.C.R.D. 32617.
- 8. "PLAT OF LAND, 705 MAIN STREET (NH RT 107), TAX MAP 2 LOT 69, FREMONT, NEW HAMPSHIRE FOR LLOYD & BETTY METEVIER." DATED MAY 2, 2005. PREPARED BY JAMES VERRA AND ASSOCIATES. R.C.R.D. 32651.
- 9. "LeBLANC WOODS, FREMONT, NEW HAMPSHIRE, SUBDIVISION PLAN, PREPARED FOR SIMON ACKERMAN." DATED MAY 22, 2007. PREPARED BY DK ENGINEERING ASSOCIATES, INC. R.C.R.D. 35109.
- 10. "PLANS OF PROPOSED UPGRADING PROJECT, B-2151, NH PROJECT NO. S-2212, NH ROUTE #107." PREPARED BY STATE OF NEW HAMPSHIRE DEPARTMENT OF PUBLIC WORKS. DATED NOVEMBER 9, 1973.


CERTIFICATION:

PURSUANT TO RSA 676:18-III AND RSA 672:14

I CERTIFY THAT THIS SURVEY PLAT IS NOT A SUBDIVISION PURSUANT TO THIS TITLE AND THAT THE LINES OF STREETS AND WAYS SHOWN ARE THOSE OF PUBLIC OR PRIVATE STREETS OR WAYS ALREADY ESTABLISHED AND THAT NO NEW WAYS ARE SHOWN.

I CERTIFY THAT THIS PLAT WAS PREPARED UNDER MY DIRECT SUPERVISION, THAT IT IS THE RESULT OF A FIELD SURVEY BY THIS OFFICE AND HAS AN UNADJUSTED LINEAR ERROR OF CLOSURE THAT EXCEED BOTH THE MINIMUM OF 1:10.000 AS DEFINED IN SECTION 503.04 OF THE NEW HAMPSHIRE CODE OF ADMINISTRATIVE RULES AND THE MINIMUM OF 1:15,000 AS DEFINED IN SECTION 4.2 OF THE N.H.L.S.A. ETHICS AND STANDARDS.

THIS SURVEY CONFORMS TO A CATEGORY 1 CONDITION 1 SURVEY AS DEFINED IN SECTION 4.1 OF THE N.H.L.S.A. ETHICS AND STANDARDS.

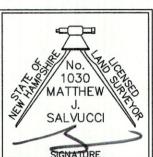


MATTHEW J. SALVUCCI, LLS 1030 ON BEHALF OF JONES & BEACH ENGINEERS, INC.

MAP UNIT NO.	SOIL TAXONOMIC NAME	SLOPE (%)
12B	HINCKLEY	3-8
12C	HINCKLEY	8-15
12D	HINCKLEY	15-25
12E	HINCKLEY	25-50
34A	WAREHAM	0-3
199B	DUMPS	3–8
199D	DUMPS	15-25
300B	UDIPSAMMENTS	3–8
313A	DEERFIELD	0-3
313B	DEERFIELD	3–8
313C	DEERFIELD	8–15
350A	UDIPSAMMENTS	0-3
350B	UDIPSAMMENTS	3–8
395A	CHOCORUA	0-3

Plan Name:	Designed and Produced in NH	Π /	
	ones & Beach Engineers, Inc.	B Jo	BWG
Project:	Cinuil Emaimooming Compions 603-772-4746		BWG
0 (1)	Civil Engineering Services 603-772-4746 FAX: 603-772-0227	85 Portsmouth Ave. PO Box 219	BWG
Owner of Record	E-MAIL: JBE@JONESANDBEACH.COM	Stratham, NH 03885	BY

121/21 DATE:

SITE SPECIFIC SOIL TABLE:

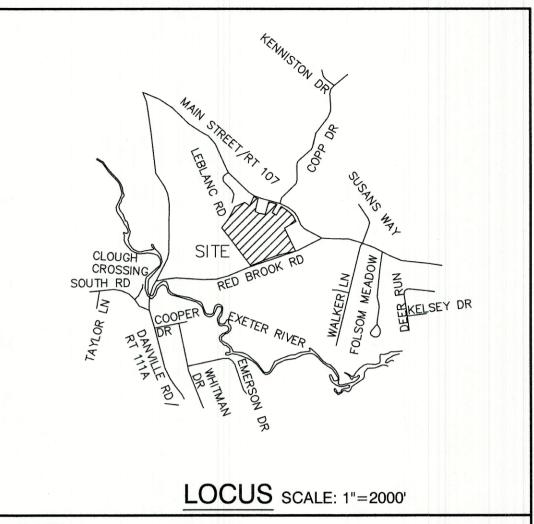


NOTES:


- 1. THE INTENT OF THIS PLAN IS TO SHOW THE EXISTING CONDITIONS OF FREMONT NH TAX MAP 2, LOT 70.
- 2. ZONING DISTRICT: MAIN STREET DISTRICT (AQUIFER PROTECTION DISTRICT) LOT AREA MINIMUM = 87,120 SF
- LOT FRONTAGE MINIMUM = 200'BUILDING SETBACKS (MINIMUM):
- FRONT SETBACK = 50'SIDE & REAR SETBACK = 30'
- WETLAND BUFFER = 100'
- MAX. BUILDING HEIGHT = 35'MAX. LOT COVERAGE = 15%
- 3. THE UTILITY LOCATIONS SHOWN HEREON WERE DETERMINED BY OBSERVED ABOVE GROUND EVIDENCE AND SHOULD BE CONSIDERED APPROXIMATE IN LOCATION ONLY LOCATION, DEPTH, SIZE, TYPE, EXISTENCE OR NONEXISTENCE OF UNDERGROUND UTILITIES AND/OR UNDERGROUND STORAGE TANKS WAS NOT VERIFIED BY THIS SURVEY. ALL CONTRACTORS SHOULD NOTIFY IN WRITING ALL UTILITY COMPANIES AND GOVERNMENT AGENCIES PRIOR TO ANY EXCAVATION WORK OR CALL DIG-SAFE AT 1-888-DIG-SAFE.
- 4. THE SUBJECT PARCEL IS NOT LOCATED WITHIN AN AREA HAVING A SPECIAL FLOOD HAZARD ZONE DESIGNATION BY THE FEDERAL EMERGENCY MANAGEMENT AGENCY, ON FLOOD INSURANCE RATE MAP NOs. 33015C0378E AND 33015C0380E, BOTH WITH EFFECTIVE DATE OF MAY 17, 2005.
- 5. BASIS OF BEARING HORIZONTAL NH STATE PLANE PER PLAN REF 6. VERTICAL - ASSUMED.
- 6. CERTAIN DATA HEREON MAY VARY FROM RECORDED DATA DUE TO DIFFERENCES IN DECLINATION, ORIENTATION, AND METHODS OF MEASUREMENT.
- 7. ALL BOOK AND PAGE NUMBERS REFER TO THE ROCKINGHAM COUNTY REGISTRY OF DEEDS.
- 8. THE TAX MAP AND LOT NUMBERS ARE BASED ON THE TOWN OF FREMONT TAX RECORDS AND ARE SUBJECT TO CHANGE.
- 9. RESEARCH WAS PERFORMED AT THE TOWN OF FREMONT ASSESSOR'S OFFICE. THE ROCKINGHAM COUNTY REGISTRY OF DEEDS, THE NEW HAMPSHIRE DEPARTMENT OF TRANSPORTATION, AND THE NEW HAMPSHIRE STATE ARCHIVES.
- 10. THIS SURVEY IS NOT A CERTIFICATION TO OWNERSHIP OR TITLE OF LANDS SHOWN. OWNERSHIP AND ENCUMBRANCES ARE MATTERS OF TITLE EXAMINATION NOT OF A BOUNDARY SURVEY. THE INTENT OF THIS PLAN IS TO RETRACE THE BOUNDARY LINES OF DEEDS REFERENCED HEREON. OWNERSHIP OF ADJOINING PROPERTIES IS ACCORDING TO ASSESSOR'S RECORDS. THIS PLAN MAY OR MAY NOT INDICATE ALL ENCUMBRANCES EXPRESSED, IMPLIED OR PRESCRIPTIVE.
- 11. ANY USE OF THIS PLAN AND OR ACCOMPANYING DESCRIPTIONS SHOULD BE DONE WITH LEGAL COUNSEL, TO BE CERTAIN THAT TITLES ARE CLEAR, THAT INFORMATION IS CURRENT, AND THAT ANY NECESSARY CERTIFICATES ARE IN PLACE FOR A PARTICULAR CONVEYANCE, OR OTHER USES.
- 12. THE LIMITS OF JURISDICTIONAL WETLANDS WERE DELINEATED BY MR. PETER PERTKAUSKOS UNDER THE SUPERVISION OF MR. JAMES LONG OF GZA GEOENVIRONMENTAL, INC. IN NOVEMBER 2020, AND JANUARY 2021 IN ACCORDANCE WITH THE FOLLOWING GUIDANCE DOCUMENTS:
 - THE CORPS OF ENGINEERS FEDERAL MANUAL FOR IDENTIFYING AND DELINEATING JURISDICTIONAL WETLANDS.
 - THE NORTH CENTRAL & NORTHEAST REGIONAL SUPPLEMENT TO THE FEDERAL MANUAL. THE CURRENT VERSION OF THE FIELD INDICATORS FOR IDENTIFYING HYDRIC SOILS IN NEW ENGLAND, AS PUBLISHED BY THE NEW ENGLAND INTERSTATE WATER POLLUTION CONTROL COMMISSION AND/OR THE
 - CURRENT VERSION OF THE FIELD INDICATORS OF HYDRIC SOILS IN THE UNITED STATES, AS PUBLISHED BY THE USDA, NRCS, AS APPROPRIATE THE CURRENT NATIONAL LIST OF PLANT SPECIES THAT OCCUR IN WETLANDS, AS PUBLISHED BY THE US FISH AND WILDLIFE SERVICE.
- 13. SURVEY TIE LINES SHOWN HEREON ARE NOT BOUNDARY LINES. THEY SHOULD ONLY BE USED TO LOCATE THE PARCEL SURVEYED FROM THE FOUND MONUMENTS SHOWN AND LOCATED BY THIS SURVEY.
- 14. "OLD ROAD LEADING FROM COUGH BRIDGE TO THE ROCKS ROAD" DISCONTINUED BY TOWN VOTE MARCH 14, 1876. NO LAYOUT FOUND BY THIS OFFICE AT THIS TIME. BOUNDARY ALONG OLD ROAD HELD AS NEAR EDGE, PER RECORD PLANS 3 6. AND 9.
- 15. SEE BOUNDARY LINE FINE AGREEMENT BETWEEN MAGNUSSON FARM LLC, WARREN HARTFORD, AND LLOYD & BETTY METEVIER, R.C.R.D BOOK 4459, PAGE 2345, AND PLAN REFERENCES 7 & 8.
- 16. THE SOIL MAPPING OF THE SITE WAS CONDUCTED IN ACCORDANCE WITH THE STANDARDS SET FORTH IN THE SOCIETY OF SOIL SCIENTISTS OF NORTHERN NEW ENGLAND (SSSNNE) PUBLICATION NO. 3 "SITE-SPECIFIC SOIL MAPPING STANDARDS FOR NEW HAMPSHIRE AND VERMONT, VERSION 5.0" DATED DECEMBER 2017 BY NEW HAMPSHIRE CERTIFIED SOIL SCIENTISTS (CSS) JAMES H. LONG (CSS #15) BETWEEN FEBRUARY 24 AND MARCH 1, 2022. THE SITE-SPECIFIC SOIL MAPPING STANDARDS ARE BASED ON A UNIVERSALLY RECOGNIZED TAXONOMIC SYSTEM OF SOIL CLASSIFICATION AND ARE SUPPORTED BY NATIONAL SOIL MAPPING STANDARDS ESTABLISHED BY THE USDA NATIONAL COOPERATIVE SOIL SURVEY.

EXISTING CONDITIONS PLAN LIBERTY LANTERN ESTATES MAIN STREET, FREMONT, NH **TIMOTHY & GERALDINE PALMER** 706 MAIN STREET, FREMONT, NH 03044



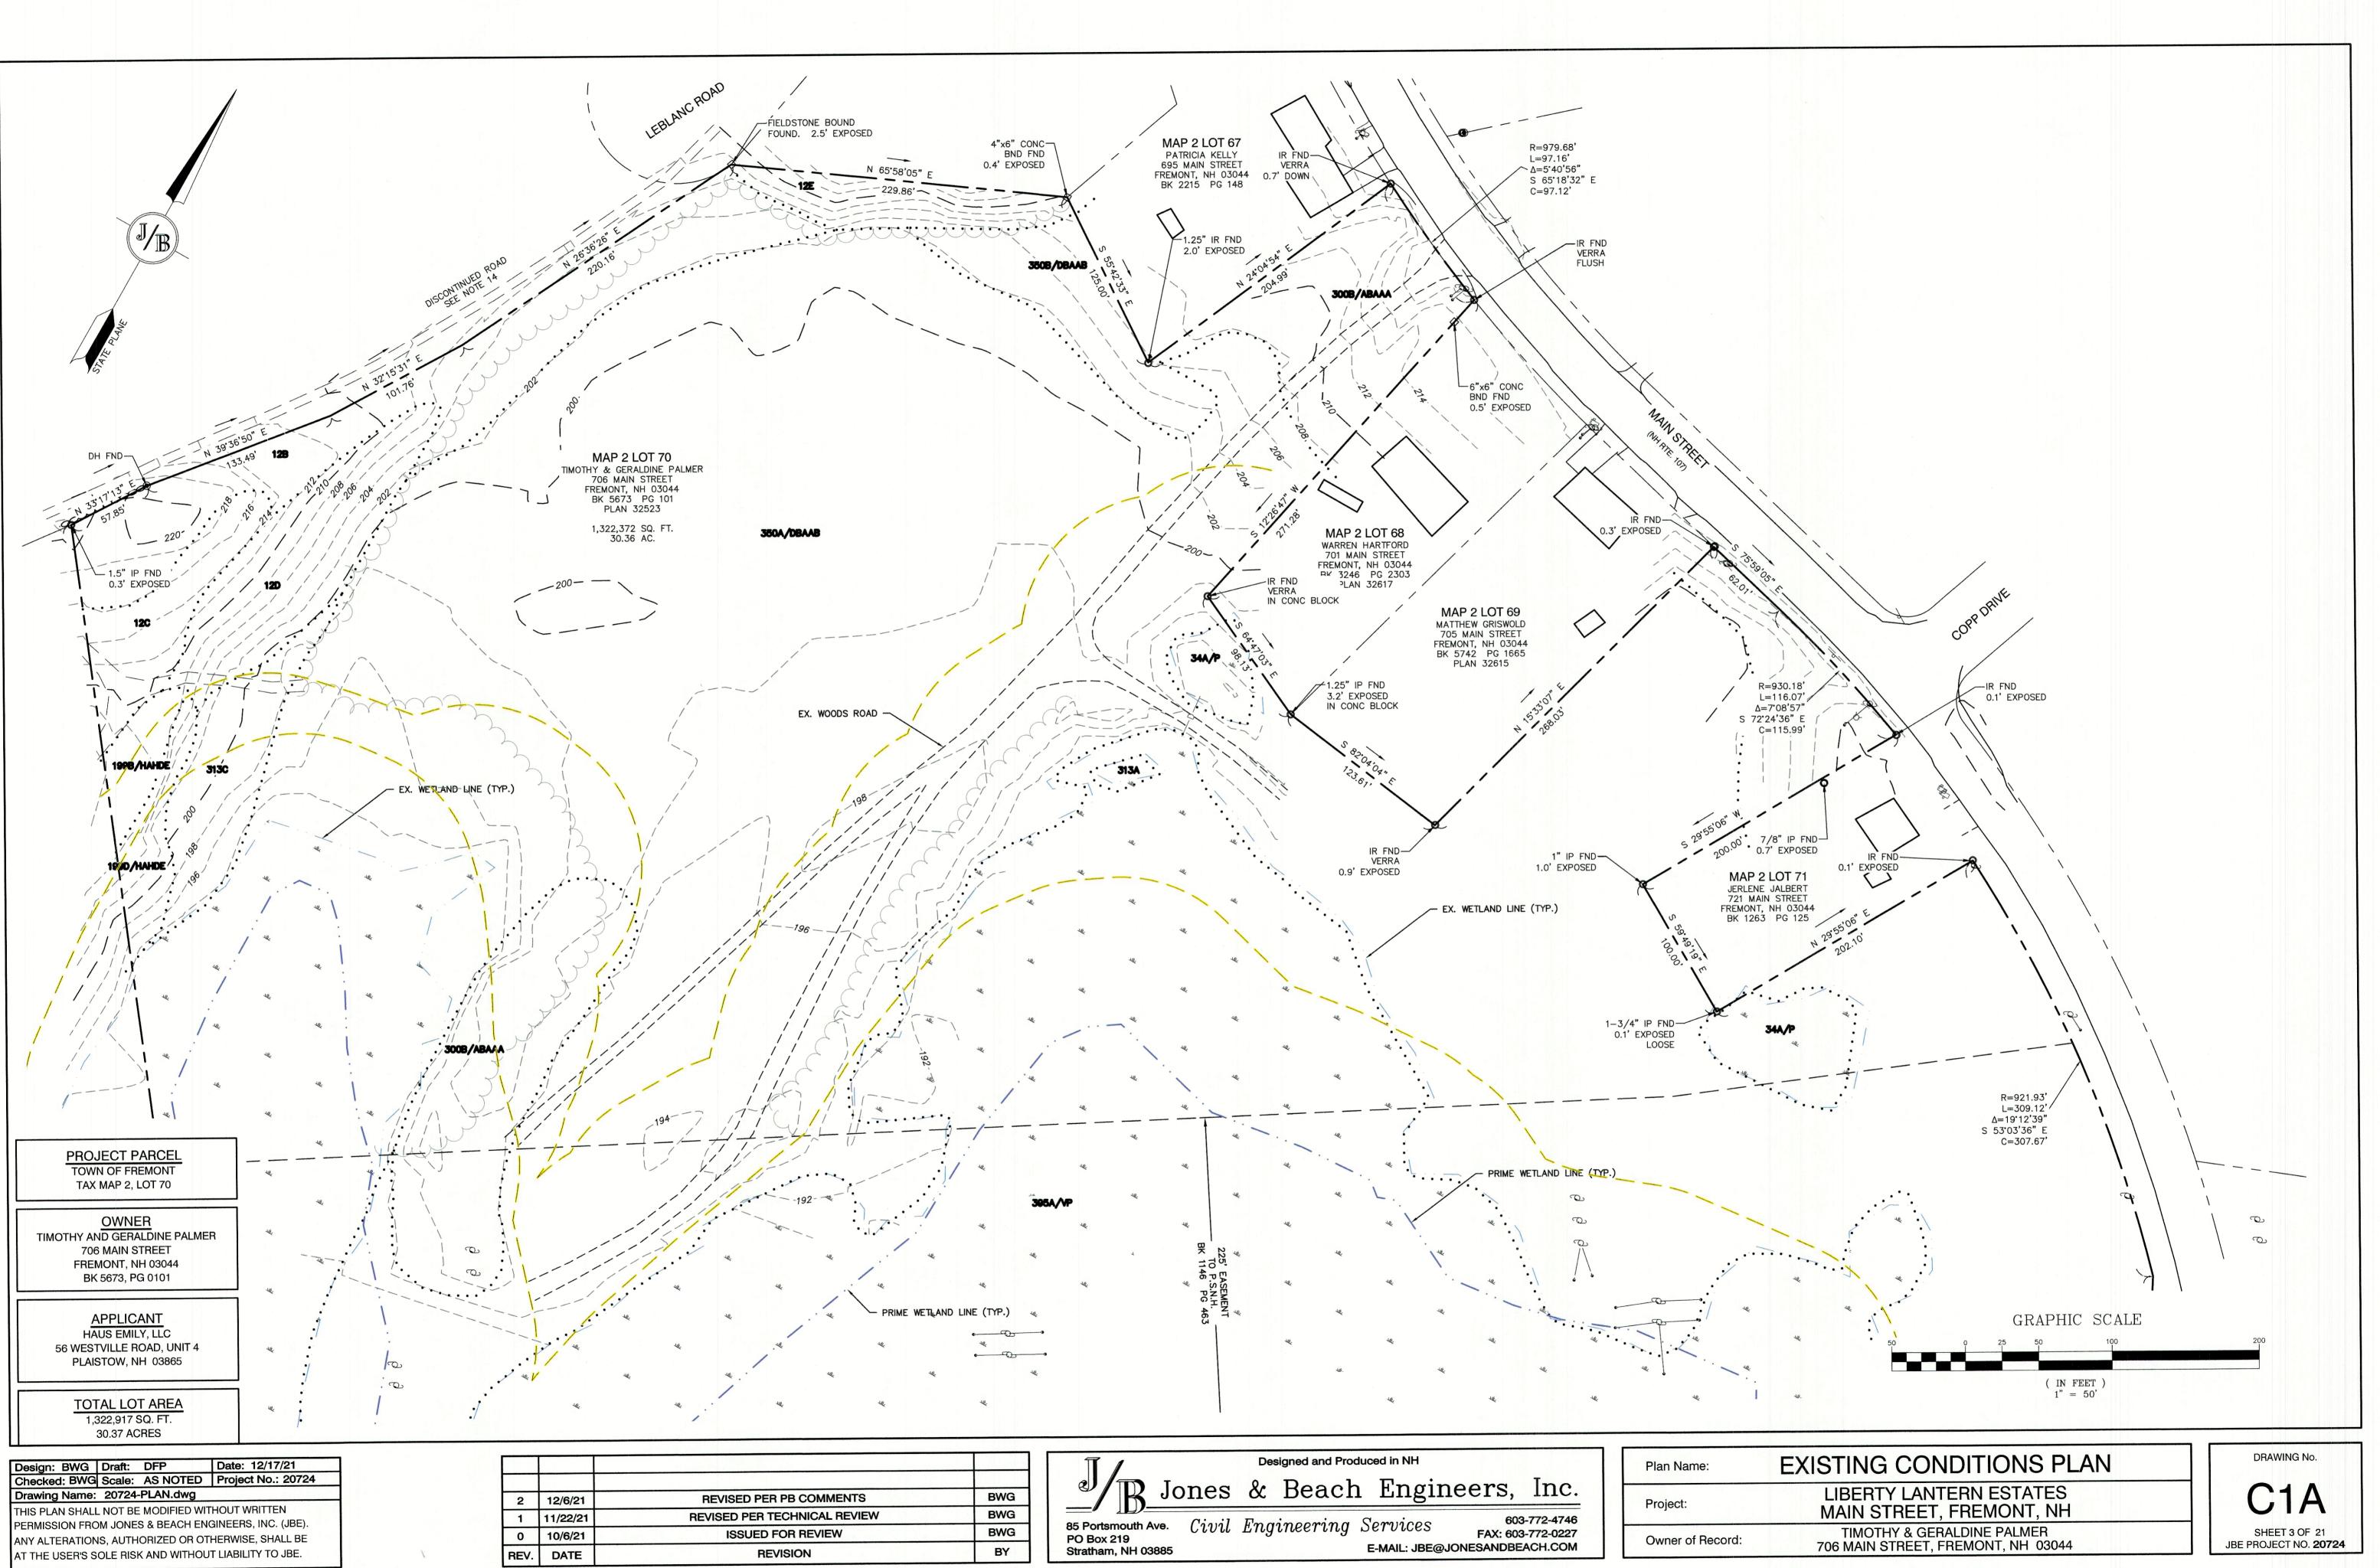

Services	000	۰
Dervices	FAX: 603-	1
E-MAIL: JBE@JO	NESANDBEA	(

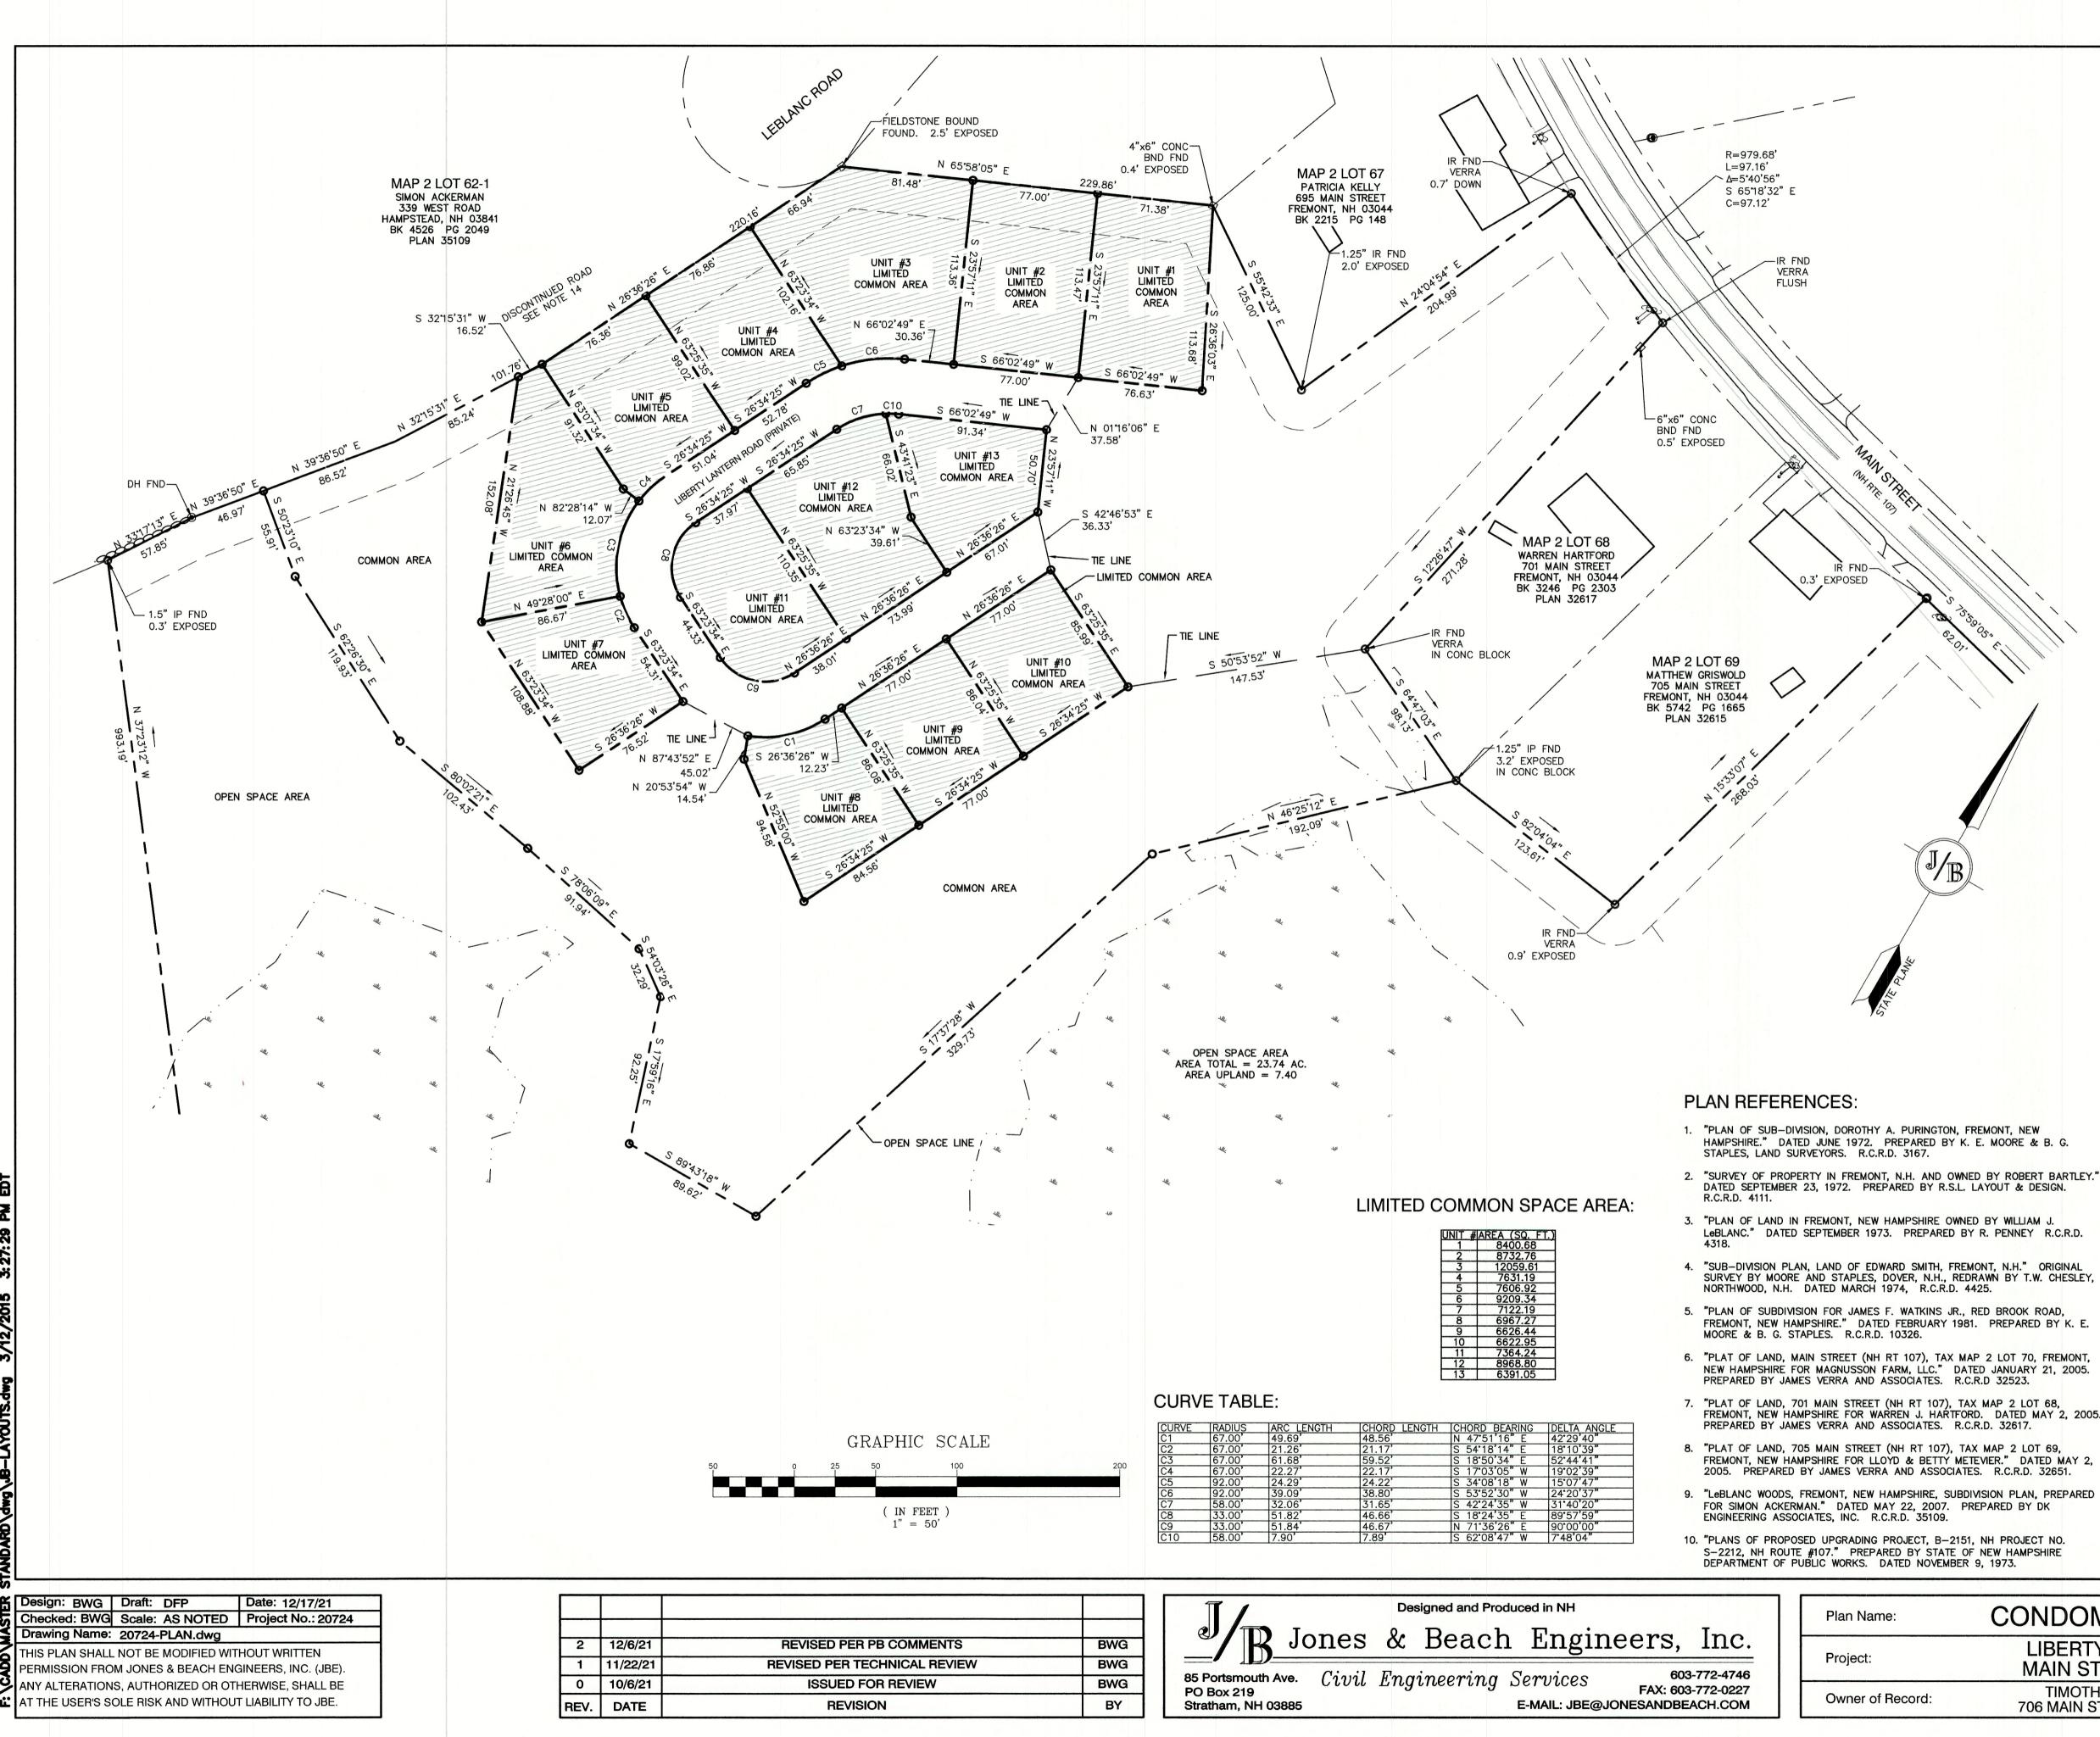

NOTES:

- 1. THE INTENT OF THIS PLAN IS TO SHOW THE PROPOSED CONDOMINIUM SITE PLAN OF FREMONT NH TAX MAP 2, LOT 70 WITH 13 ELDERLY OPEN SPACE UNITS PER ARTICLE 13, SECTION 1031 OF THE TOWN OF FREMONT ZONING ORDINANCE, CONTAINING A MAXIMUM OF 25 BEDROOMS.
- 2. ZONING DISTRICT: MAIN STREET DISTRICT ELDERLY OPEN SPACE (AQUIFER PROTECTION DISTRICT) LOT AREA MINIMUM = 87,120 SF (SEE NOTE #4 FOR DENSITY CALCULATIONS)
- LOT FRONTAGE MINIMUM = 200' BUILDING SETBACKS (MINIMUM): FRONT SETBACK = 50° SIDE & REAR SETBACK = 30' WETLAND BUFFER = 100'
- MAX. BUILDING HEIGHT = 35'MAX. LOT COVERAGE = 15%
- 3. ELDERLY OPEN SPACE REQUIREMENTS: AREA REQUIRED = 20 ACRES PARCEL AREA = 30.37 ACRES FRONTAGE REQUIRED = 50° PARCEL FRONTAGE = 1,709.23'
- 4. ELDERLY OPEN SPACE DENSITY CALCULATION: =(DEVELOPABLE AREA X 0.9) X (2 BEDROOMS / ACRE) $=(606,867 \text{ SF. } \times 0.9) = 546,180 \text{ S.F.} = 12.54 \text{ AC.}$
- =(12.54 AC X 2 BEDROOMS / ACRE) = 25 BEDROOMS
- 5. ALL UNITS, WITH THE EXCEPTION OF UNIT #1, SHALL BE A MAXIMUM OF 2-BEDROOMS. UNIT 1 SHALL BE 1-BEDROOM.
- 6. BASIS OF BEARING HORIZONTAL NH STATE PLANE PER PLAN REF 6. VERTICAL - ASSUMED.
- 7. CERTAIN DATA HEREON MAY VARY FROM RECORDED DATA DUE TO DIFFERENCES IN DECLINATION, ORIENTATION, AND METHODS OF MEASUREMENT.
- 8. ALL BOOK AND PAGE NUMBERS REFER TO THE ROCKINGHAM COUNTY REGISTRY OF DEEDS.
- 9. THE TAX MAP AND LOT NUMBERS ARE BASED ON THE TOWN OF FREMONT TAX RECORDS AND ARE SUBJECT TO CHANGE.
- 10. RESEARCH WAS PERFORMED AT THE TOWN OF FREMONT ASSESSOR'S OFFICE, THE ROCKINGHAM COUNTY REGISTRY OF DEEDS, THE NEW HAMPSHIRE DEPARTMENT OF TRANSPORTATION, AND THE NEW HAMPSHIRE STATE ARCHIVES.
- 11. THIS SURVEY IS NOT A CERTIFICATION TO OWNERSHIP OR TITLE OF LANDS SHOWN. OWNERSHIP AND ENCUMBRANCES ARE MATTERS OF TITLE EXAMINATION NOT OF A BOUNDARY SURVEY. THE INTENT OF THIS PLAN IS TO RETRACE THE BOUNDARY LINES OF DEEDS REFERENCED HEREON. OWNERSHIP OF ADJOINING PROPERTIES IS ACCORDING TO ASSESSOR'S RECORDS. THIS PLAN MAY OR MAY NOT INDICATE ALL ENCUMBRANCES EXPRESSED, IMPLIED OR PRESCRIPTIVE.
- 12. ANY USE OF THIS PLAN AND OR ACCOMPANYING DESCRIPTIONS SHOULD BE DONE WITH LEGAL COUNSEL, TO BE CERTAIN THAT TITLES ARE CLEAR, THAT INFORMATION IS CURRENT, AND THAT ANY NECESSARY CERTIFICATES ARE IN PLACE FOR A PARTICULAR CONVEYANCE, OR OTHER USES.
- 13. THE LIMITS OF JURISDICTIONAL WETLANDS WERE DELINEATED BY MR. PETER PERTKAUSKOS UNDER THE SUPERVISION OF MR. JAMES LONG OF GZA GEOENVIRONMENTAL, INC. IN NOVEMBER 2020, AND JANUARY 2021 IN ACCORDANCE WITH THE FOLLOWING GUIDANCE DOCUMENTS:
- THE CORPS OF ENGINEERS FEDERAL MANUAL FOR IDENTIFYING AND Α. DELINEATING JURISDICTIONAL WETLANDS. THE NORTH CENTRAL & NORTHEAST REGIONAL SUPPLEMENT TO THE FEDERAL
- MANUAL. THE CURRENT VERSION OF THE FIELD INDICATORS FOR IDENTIFYING HYDRIC SOILS IN NEW ENGLAND, AS PUBLISHED BY THE NEW ENGLAND INTERSTATE WATER POLLUTION CONTROL COMMISSION AND/OR THE CURRENT VERSION OF
- THE FIELD INDICATORS OF HYDRIC SOILS IN THE UNITED STATES, AS PUBLISHED BY THE USDA, NRCS, AS APPROPRIATE. THE CURRENT NATIONAL LIST OF PLANT SPECIES THAT OCCUR IN WETLANDS, AS PUBLISHED BY THE US FISH AND WILDLIFE SERVICE.
- 14. "OLD ROAD LEADING FROM COUGH BRIDGE TO THE ROCKS ROAD" DISCONTINUED BY TOWN VOTE MARCH 14, 1876. NO LAYOUT FOUND BY THIS OFFICE AT THIS TIME. BOUNDARY ALONG OLD ROAD HELD AS NEAR EDGE, PER RECORD PLANS 3, 6, AND
- 15. SEE BOUNDARY LINE FINE AGREEMENT BETWEEN MAGNUSSON FARM LLC, WARREN HARTFORD, AND LLOYD & BETTY METEVIER, R.C.R.D BOOK 4459, PAGE 2345, AND PLAN REFERENCES 7 & 8.
- 16. THE DECK, PORCH, AND PORTIONS OF THE DRIVEWAY AS SHOWN ARE LIMITED COMMON AREA. SEE DECLARATION OF CONDOMINIUM.
- 17. THE HORIZONTAL BOUNDARIES OF THE BUILDING SHALL BE: "THE OUTSIDE FINISHED EXERIOR SURFACE OF THE WALLS, FOUNDATIONS, AND ROOFS AND THE LOWER SURFACE OF THE BASEMENT SLAB, INCLUDING ALL SUPPORTS, VENTS, CHIMNEYS, STAIRWAYS, PORCHES, AND DECKS APPURTENANT THERETO."
- 18. SHEET A1 & C2 SHALL BE RECORDED AT ROCKINGHAM COUNTY REGISTRY OF DEEDS. FULL PLAN SET ON FILE IN THE TOWN OF FREMONT, NH PLANNING BOARD OFFICE.
- 19. SURVEY TIE LINES SHOWN HEREON ARE NOT BOUNDARY LINES. THEY SHOULD ONLY BE USED TO LOCATE THE PARCEL SURVEYED FROM THE FOUND MONUMENTS SHOWN AND LOCATED BY THIS SURVEY.

.S.L. LAYOUT & DESIGN.	
OWNED BY WILLIAM J. ED BY R. PENNEY R.C.R.D.	
FREMONT, N.H." ORIGINAL , REDRAWN BY T.W. CHESLEY, .D. 4425.	
JR., RED BROOK ROAD, 7 1981. PREPARED BY K. E.	
X MAP 2 LOT 70, FREMONT, DATED JANUARY 21, 2005. R.C.R.D 32523.	ТІМС
), TAX MAP 2 LOT 68, RTFORD. DATED MAY 2, 2005. R.C.R.D. 32617.	
), TAX MAP 2 LOT 69, Y METEVIER." DATED MAY 2, CIATES. R.C.R.D. 32651.	Ę
SUBDIVISION PLAN, PREPARED 7. PREPARED BY DK	
-2151, NH PROJECT NO. TE OF NEW HAMPSHIRE MBER 9, 1973.	
CONDOMINIUM SITE PLAN	

LIBERTY LANTERN ESTATES

MAIN STREET, FREMONT, NH

TIMOTHY & GERALDINE PALMER

706 MAIN STREET, FREMONT, NH 03044

PROJECT PARCEL TOWN OF FREMONT TAX MAP 2, LOT 70

OWNER OTHY AND GERALDINE PALMER 706 MAIN STREET FREMONT, NH 03044 BK 5673, PG 0101

> APPLICANT HAUS EMILY, LLC 56 WESTVILLE ROAD, UNIT 4 PLAISTOW, NH 03865


> > TOTAL LOT AREA 1,322,917 SQ. FT. 30.37 ACRES


DRAWING No.

A SHEET 4 OF 21 JBE PROJECT NO. 20724


2.	FREMONT ZONING BOARD ORDINANCES, CONTAINING A MAXIMUM OF 25 BEDROOMS. ALL UNITS WILL BE SERVICED BY ON-SITE WELLS AND SEPTICS. ZONING DISTRICT: MAIN STREET DISTRICT - ELDERLY OPEN SPACE (AQUIFER PROTECTION DISTRICT) LOT AREA MINIMUM = SEE DENSITY CALCULATION NOTE #4				
	BUILDING SETBACKS (MINIMUM): PERIMETER BUFFER = 25' WETLAND SETBACK = 100' MAX. BUILDING HEIGHT = 35' MIN. BUILDING SEPARATION = 35' MAX BEDROOM PER UNIT = 2				
	MAX LIVING SPACE PER UNIT = 1500 SF. AVAILABLE BUILDING AREA=606,867 SF				
3.	ELDERLY OPEN SPACE REQUIREMENTS: AREA REQUIRED = 20 ACRES PARCEL AREA = 30.37 ACRES FRONTAGE REQUIRED = 50' PARCEL FRONTAGE = 1,709.23'			MAP 2 LOT 62-1 SIMON ACKERMAN 339 WEST ROAD HAMPSTEAD, NH 03841 BK 4526 PG 2049	Limited Coi S
	ELDERLY OPEN SPACE DENSITY CALCULATION: =(DEVELOPABLE AREA X 0.9) X (2 BEDROOMS / ACRE) =($606,867$ SF. X 0.9) = 546,180 S.F. = 12.54 AC. =(12.54 AC X 2 BEDROOMS / ACRE) = 25 BEDROOMS			PLAN 35109	N 3215'3 10 9'36'50" E8 86.52'\
5.	ALL UNITS, WITH THE EXCEPTION OF UNIT #1, SHALL BE A MAXIMUM OF 2-BEDROOMS. UNIT 1 SHABE 1-BEDROOM.	LL.		N 39°36'50" E 46.97 N 33°17'13" E	
6.	OPEN SPACE CALCS: OPEN SPACE REQUIRED = 33% OF GROSS UPLAND OPEN SPACE REQUIRED = 33% X 606,867 SF. = 200,266 SF. OPEN SPACE PROVIDED = $1,034,254$ SF. OPEN SPACE UPLAND PROVIDED = $322,205$ SF.			57.85' S 50'23	3'10" E 55.91'
	NHDES APPROVAL FOR SUBDIVISION PERMIT NO. , DATED . NHDOT DRIVEWAY PERMIT NO. , DATED . NHDES ALTERATION OF TERRAIN PERMIT NO. , DATED . NHDES SEPTIC SYSTEM PERMIT NO. , DATED .			N 37.23 993	
8.	THIS PLAN SET HAS BEEN PREPARED BY JONES & BEACH ENGINEERS, INC., FOR MUNICIPAL AND STATE APPROVALS AND FOR CONSTRUCTION BASED ON DATA OBTAINED FROM ON-SITE FIELD SURVEY AND EXISTING MUNICIPAL RECORDS. THROUGHOUT THE CONSTRUCTION PROCESS, THE CONTRACTOR SHALL INFORM THE ENGINEER IMMEDIATELY OF ANY FIELD DISCREPANCY FROM DATA SHOWN ON THE DESIGN PLANS, INCLUDING ANY UNFORESEEN CONDITIONS, SUBSURFACE OR OTHERWISE, FOR EVALUATION AND RECOMMENDATIONS. ANY CONTRADICTION BETWEEN ITEMS ON T PLAN/PLAN SET, OR BETWEEN THE PLANS AND ON-SITE CONDITIONS, MUST BE RESOLVED BEFORE RELATED CONSTRUCTION HAS BEEN INITIATED. CONTRACTOR TO ALWAYS CONTACT DIG SAFE PRIOR TO DIGGING ONSITE OR OFFSITE TO ENSURE SAFETY AND OBEY THE LAW.	HIS		19. 12 ×	
9.	ALL CONSTRUCTION SHALL CONFORM TO TOWN STANDARDS AND REGULATIONS, AND NHDOT STANDARD SPECIFICATIONS FOR ROAD AND BRIDGE CONSTRUCTION, WHICHEVER IS MORE STRINGENT	г.		/	· ./·
10.	THE SUBJECT PARCEL IS NOT LOCATED WITHIN AN AREA HAVING A SPECIAL FLOOD HAZARD ZONE DESIGNATION BY THE FEDERAL EMERGENCY MANAGEMENT AGENCY, ON FLOOD INSURANCE RATE MANOS. 33015C0378E AND 33015C0380E, BOTH WITH EFFECTIVE DATE OF MAY 17, 2005.	P		1	- /
11.	LANDOWNERS ARE RESPONSIBLE FOR COMPLYING WITH ALL APPLICABLE LOCAL, STATE AND FEDERA WETLAND REGULATIONS, INCLUDING PERMITTING REQUIRED UNDER THESE REGULATIONS.	AL.		1 /	
12.	ALL CONSTRUCTION ACTIVITIES SHALL BE PERFORMED IN ACCORDANCE WITH THE STORMWATER POLLUTION PREVENTION PLAN (S.W.P.P.P.). THIS DOCUMENT IS TO BE KEPT ONSITE AT ALL TIMES AND UPDATED AS REQUIRED.			_	
13.	PRIOR TO THE START OF CONSTRUCTION, THE CONTRACTOR SHALL COORDINATE WITH THE ENGINEE ARCHITECT AND/OR OWNER, IN ORDER TO OBTAIN AND/OR PAY ALL THE NECESSARY LOCAL PERMITS, FEES AND BONDS.	R,		/ /	
14.	ALL SIGNAGE AND PAVEMENT MARKINGS SHALL BE IN ACCORDANCE WITH THE LATEST EDITION OF THE MANUAL ON UNIFORM TRAFFIC CONTROL DEVICES (M.U.T.C.D.) AND NHOOT STANDARDS AND SPECIFICATIONS (NON-REFLECTORIZED PAVEMENT MARKINGS), UNLESS OTHERWISE NOTED.		/	/	
15.	ALL STOP BARS SHALL BE 18" IN WIDTH IN A COLOR OF WHITE; ALL TRAFFIC ARROWS SHALL BE PAINTED IN A COLOR OF WHITE.		/	1	
	ALL BUILDING DIMENSIONS SHALL BE VERIFIED WITH THE ARCHITECTURAL AND STRUCTURAL PLANS PROVIDED BY THE OWNER. ANY DISCREPANCIES SHOULD BE BROUGHT TO THE ATTENTION OF THE ENGINEER AND OWNER PRIOR TO THE START OF CONSTRUCTION. BUILDING DIMENSIONS AND AREA TO BE TO OUTSIDE OF MASONRY, UNLESS OTHERWISE NOTED.	s /			
	SNOW TO BE STORED AT EDGE OF PAVEMENT AND IN AREAS SHOWN ON THE PLANS. DUMPSTERS AND/OR ROLL-OFFS ARE NOT TO BE PICKED UP BETWEEN 7:00 PM AND 7:00 AM.	1		AP 2 LOT 73-2	
19.	ALL CONSTRUCTION ACTIVITIES SHALL CONFORM TO LABOR OCCUPATIONAL SAFETY AND HEALTH ADMINISTRATION (OSHA) RULES AND REGULATIONS.	/	FRE	WN OF FREMONT PO BOX 120 MONT, NH 03044 3093 PG 402	
20.	ALL UNITS TO INCLUDE A 1 CAR GARAGE AND 1 EXTERIOR PARKING SPACE			PLAN 10326	
21.	THE WAYS SHOWN ON THIS PLAT ARE INTENDED BY THE OWNER/APPLICANT AND THE TOWN OF FREMONT TO BE PLATTED, CONSTRUCTED AND MAINTAINED AS A PRIVATE ROAD. THE RECORDING THIS PLAT SHALL NOT BE CONSTRUED AS AN OFFER OF DEDICATION OF THIS WAY AS A PUBLIC HIGHWAY UNDER NEW HAMPSHIRE LAW OF DEDICATION AND ACCEPTANCE.	OF	i		Y I
22.	DISTANCE TO TOWN OF FREMONT: POLICE STATION: 1.4 MI. FIRE STATION: 1.4 MI.			/	111
	THIS PROJECT SHALL COMPLY WITH HUD'S FAIR HOUSING ACCESSIBILITY GUIDELINES.		·	MAIN STREET DIST	
	OPEN SPACE SHALL BE UTILIZED FOR PASSIVE RECREATION ONLY. SHEET A1 & C2 SHALL BE RECORDED AT ROCKINGHAM COUNTY REGISTRY OF DEEDS. FULL PLAN S ON FILE IN THE TOWN OF FREMONT, NH PLANNING BOARD OFFICE.	SET		FLEXIBLE USE DISTRI	
Der	ign: BWG Draft: DEP Date: 12/17/21				
Che	sign: BWG Draft: DFP Date: 12/17/21 bocked: BWG Scale: AS NOTED Project No.: 20724 wing Name: 20724-PLAN.dwg				
Che Dra THIS		2	12/6/21 11/22/21		VISED PER PB SED PER TECH

REVISION

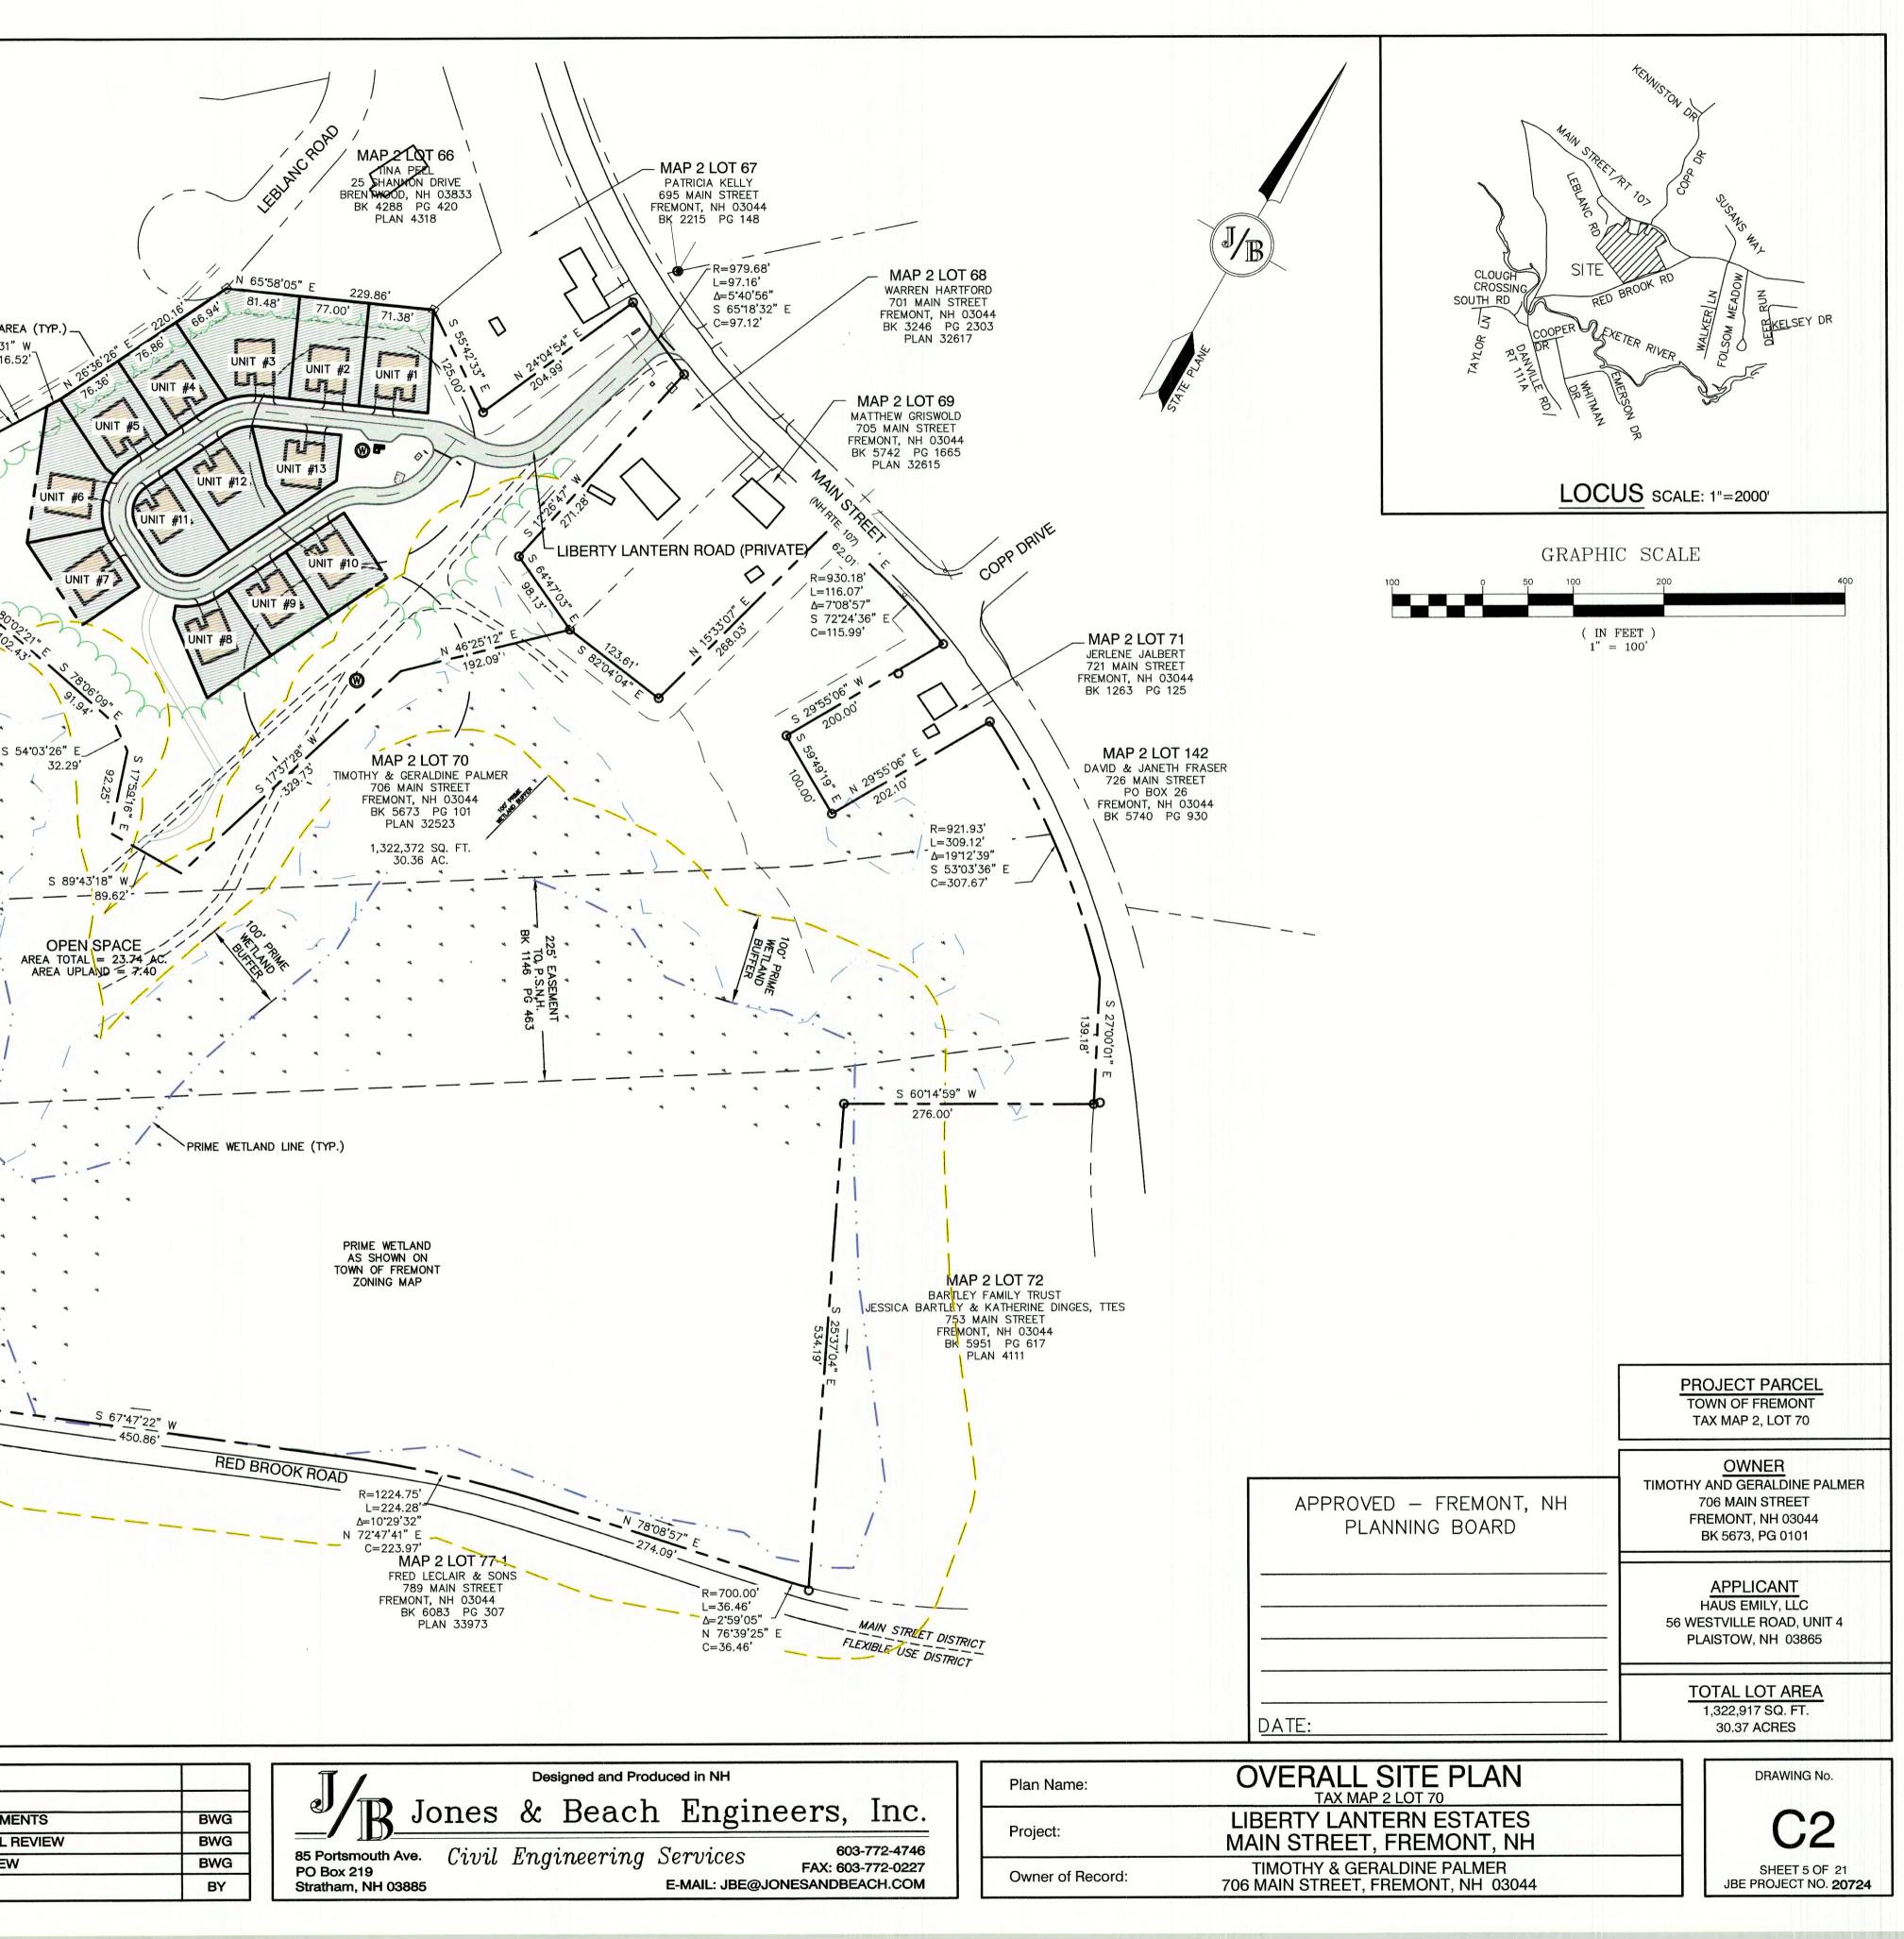


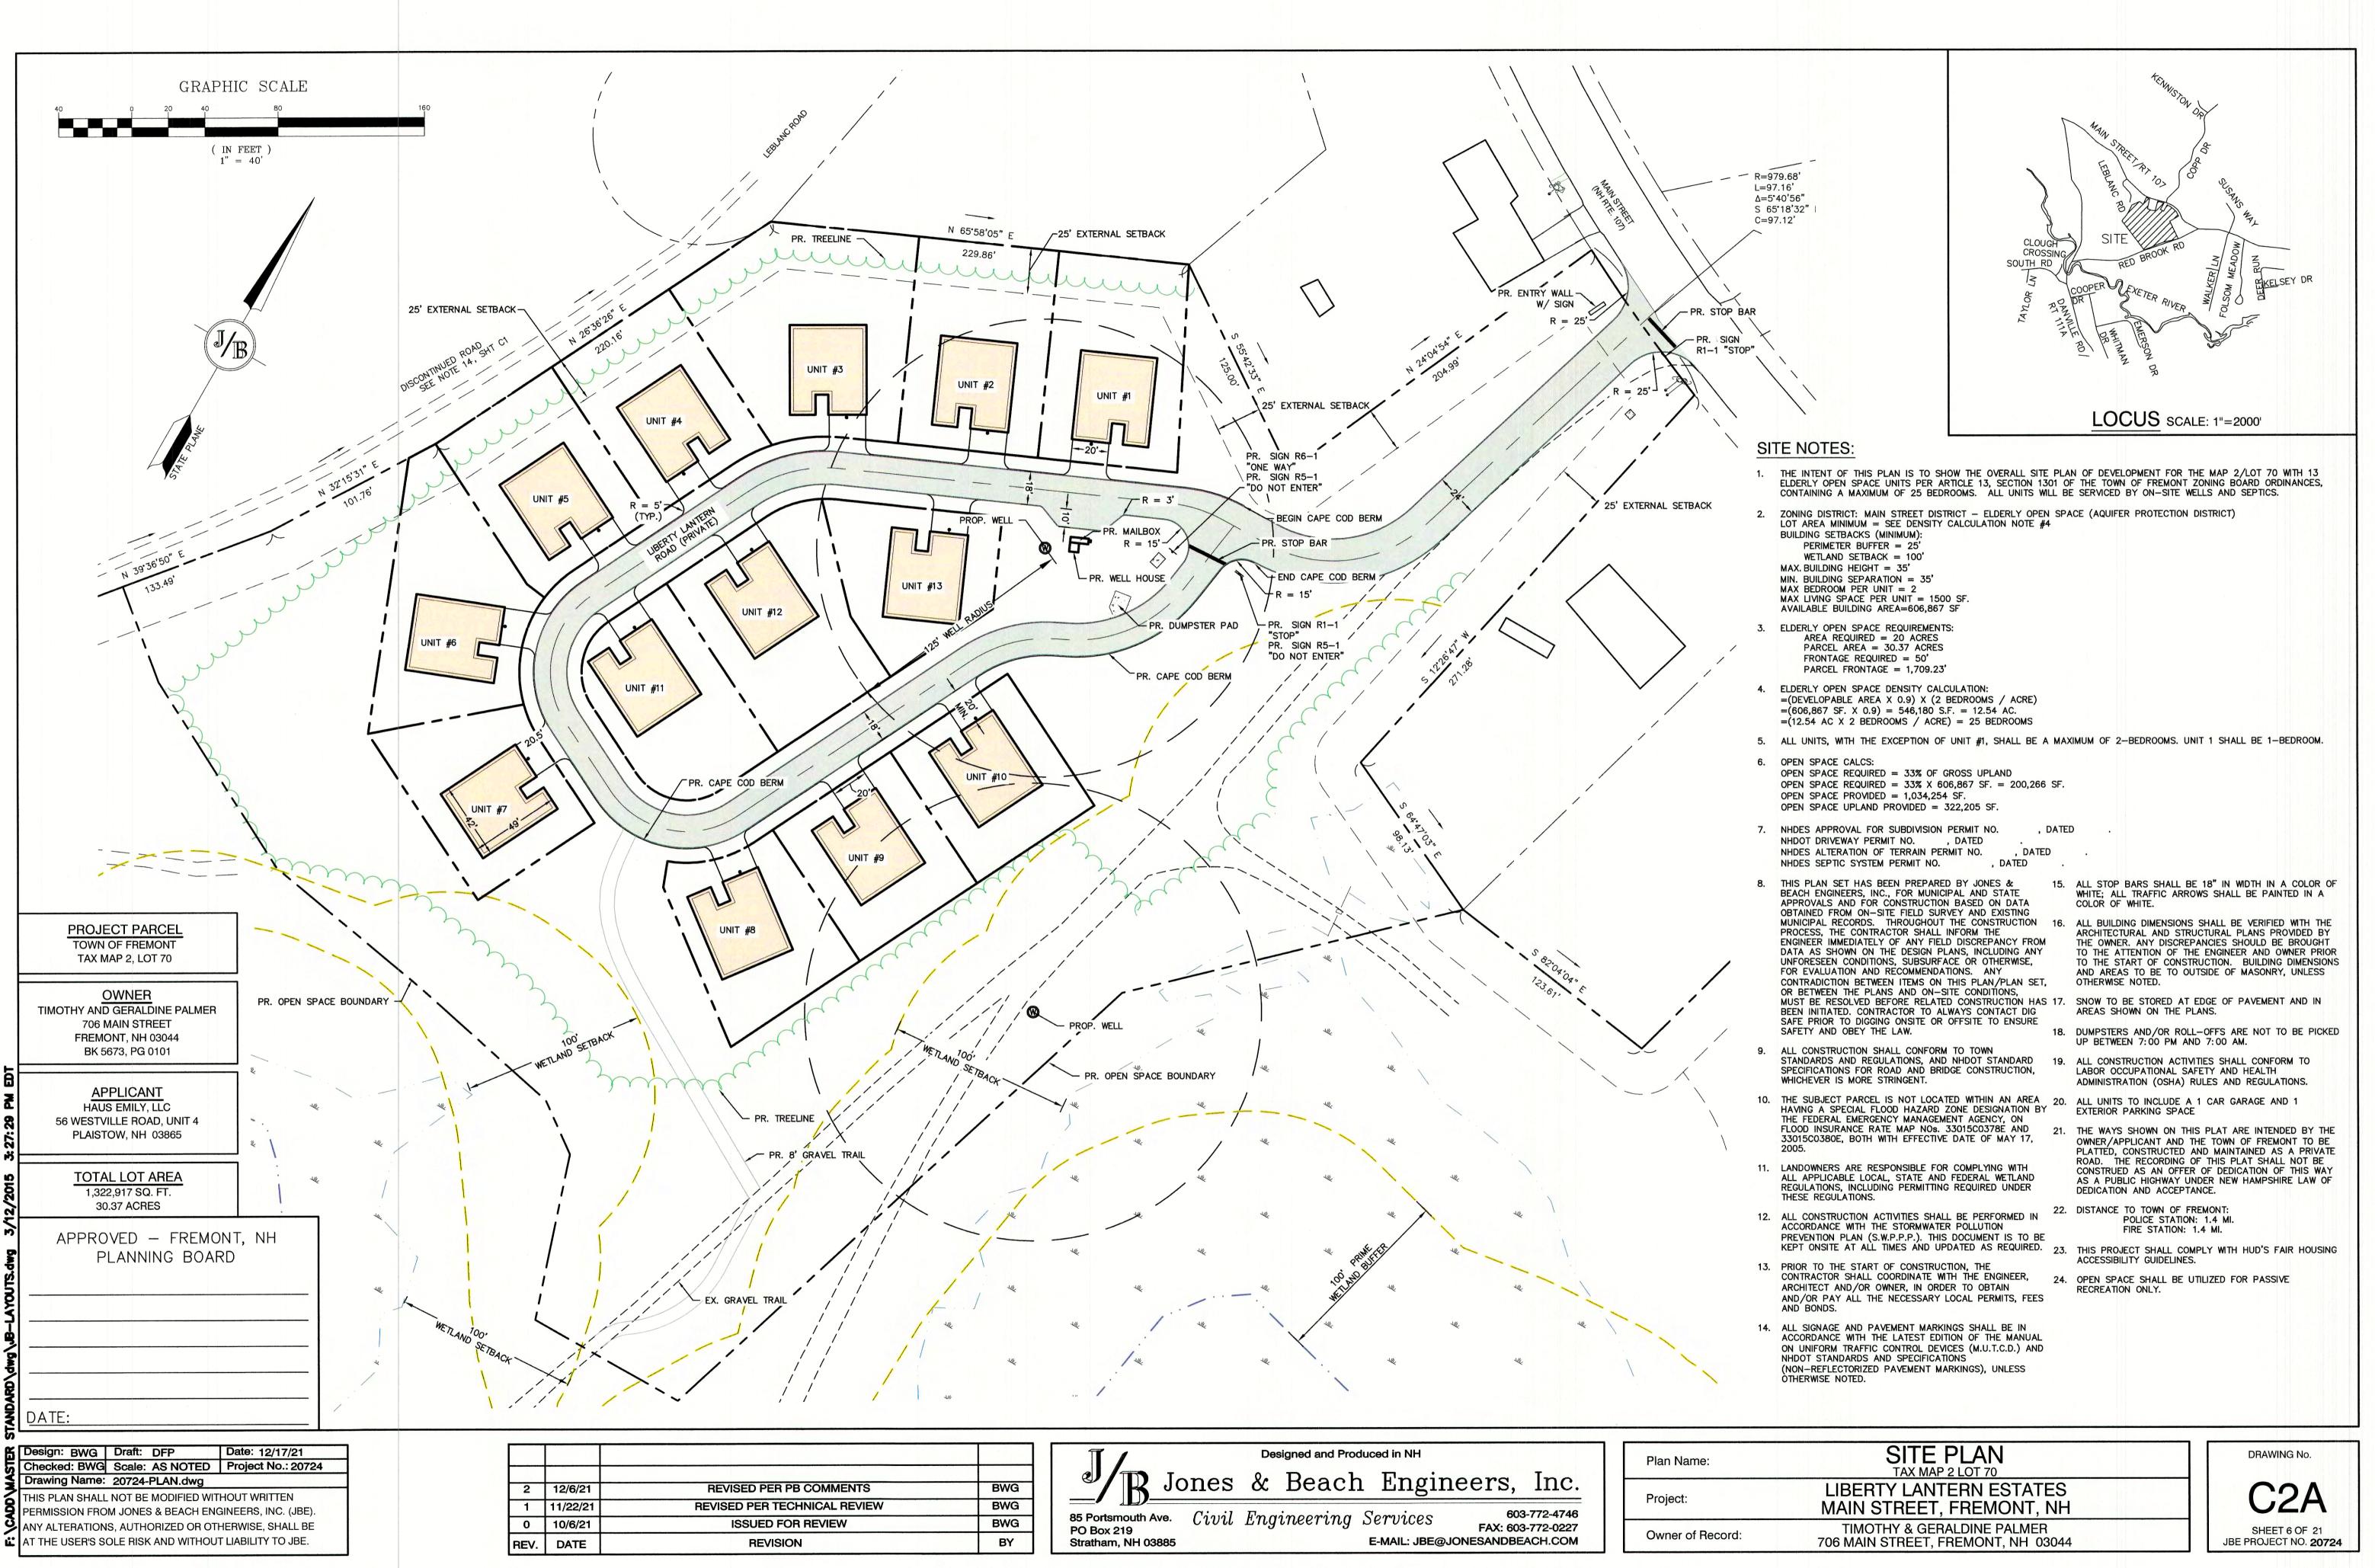



BWG		$\max \alpha$	Deach	Eligineers,	mc.
BWG		a E	· · · a		3-772-4746
BWG	85 Portsmouth Ave. PO Box 219	Civil Eng	gineering S	erutees	3-772-0227
	TO DOX 210		-		EACH COM

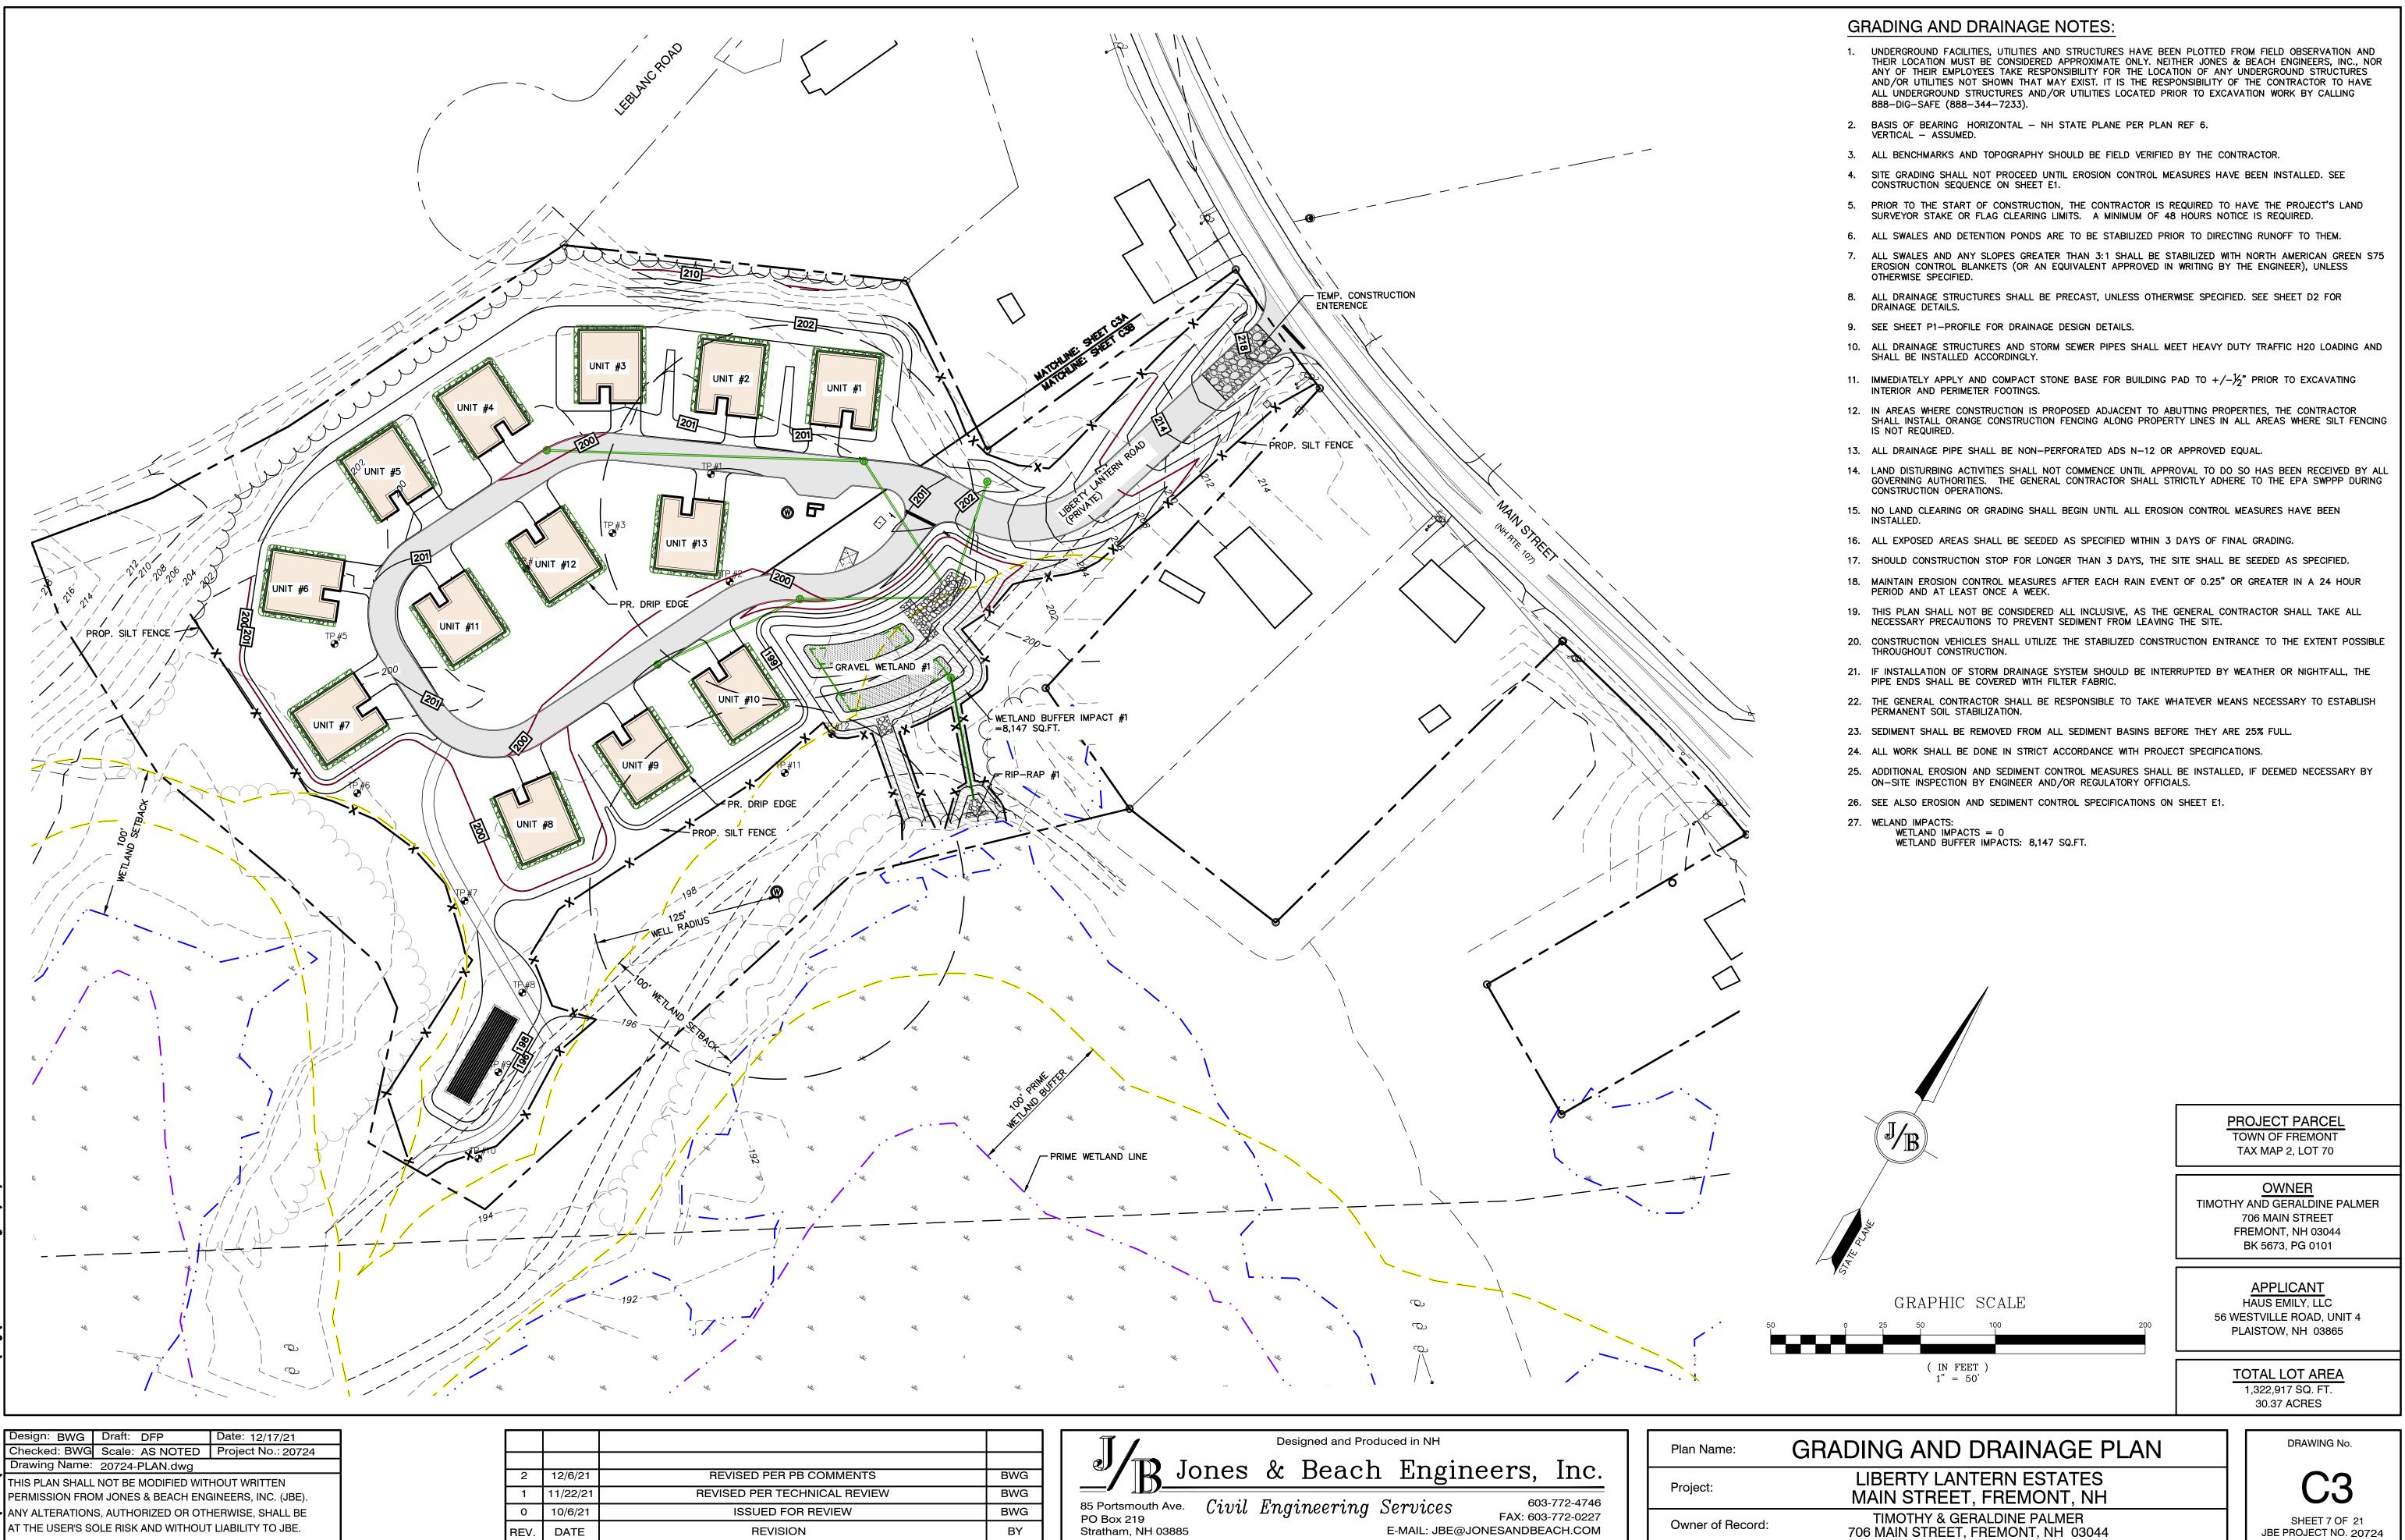

		Designed and Produced in NH	Plan Name:
TS	BWG	Jones & Beach Engineers, Inc.	Duciente
VIEW	BWG	85 Portsmouth Ave Ciavil Emgino orging Somaiooo 603-772-4746	Project:
	BWG	85 Portsmouth Ave. Civil Engineering Services PO Box 219 FAX: 603-772-4746 FAX: 603-772-0227	
	BY	Stratham, NH 03885 E-MAIL: JBE@JONESANDBEACH.COM	Owner of Record:

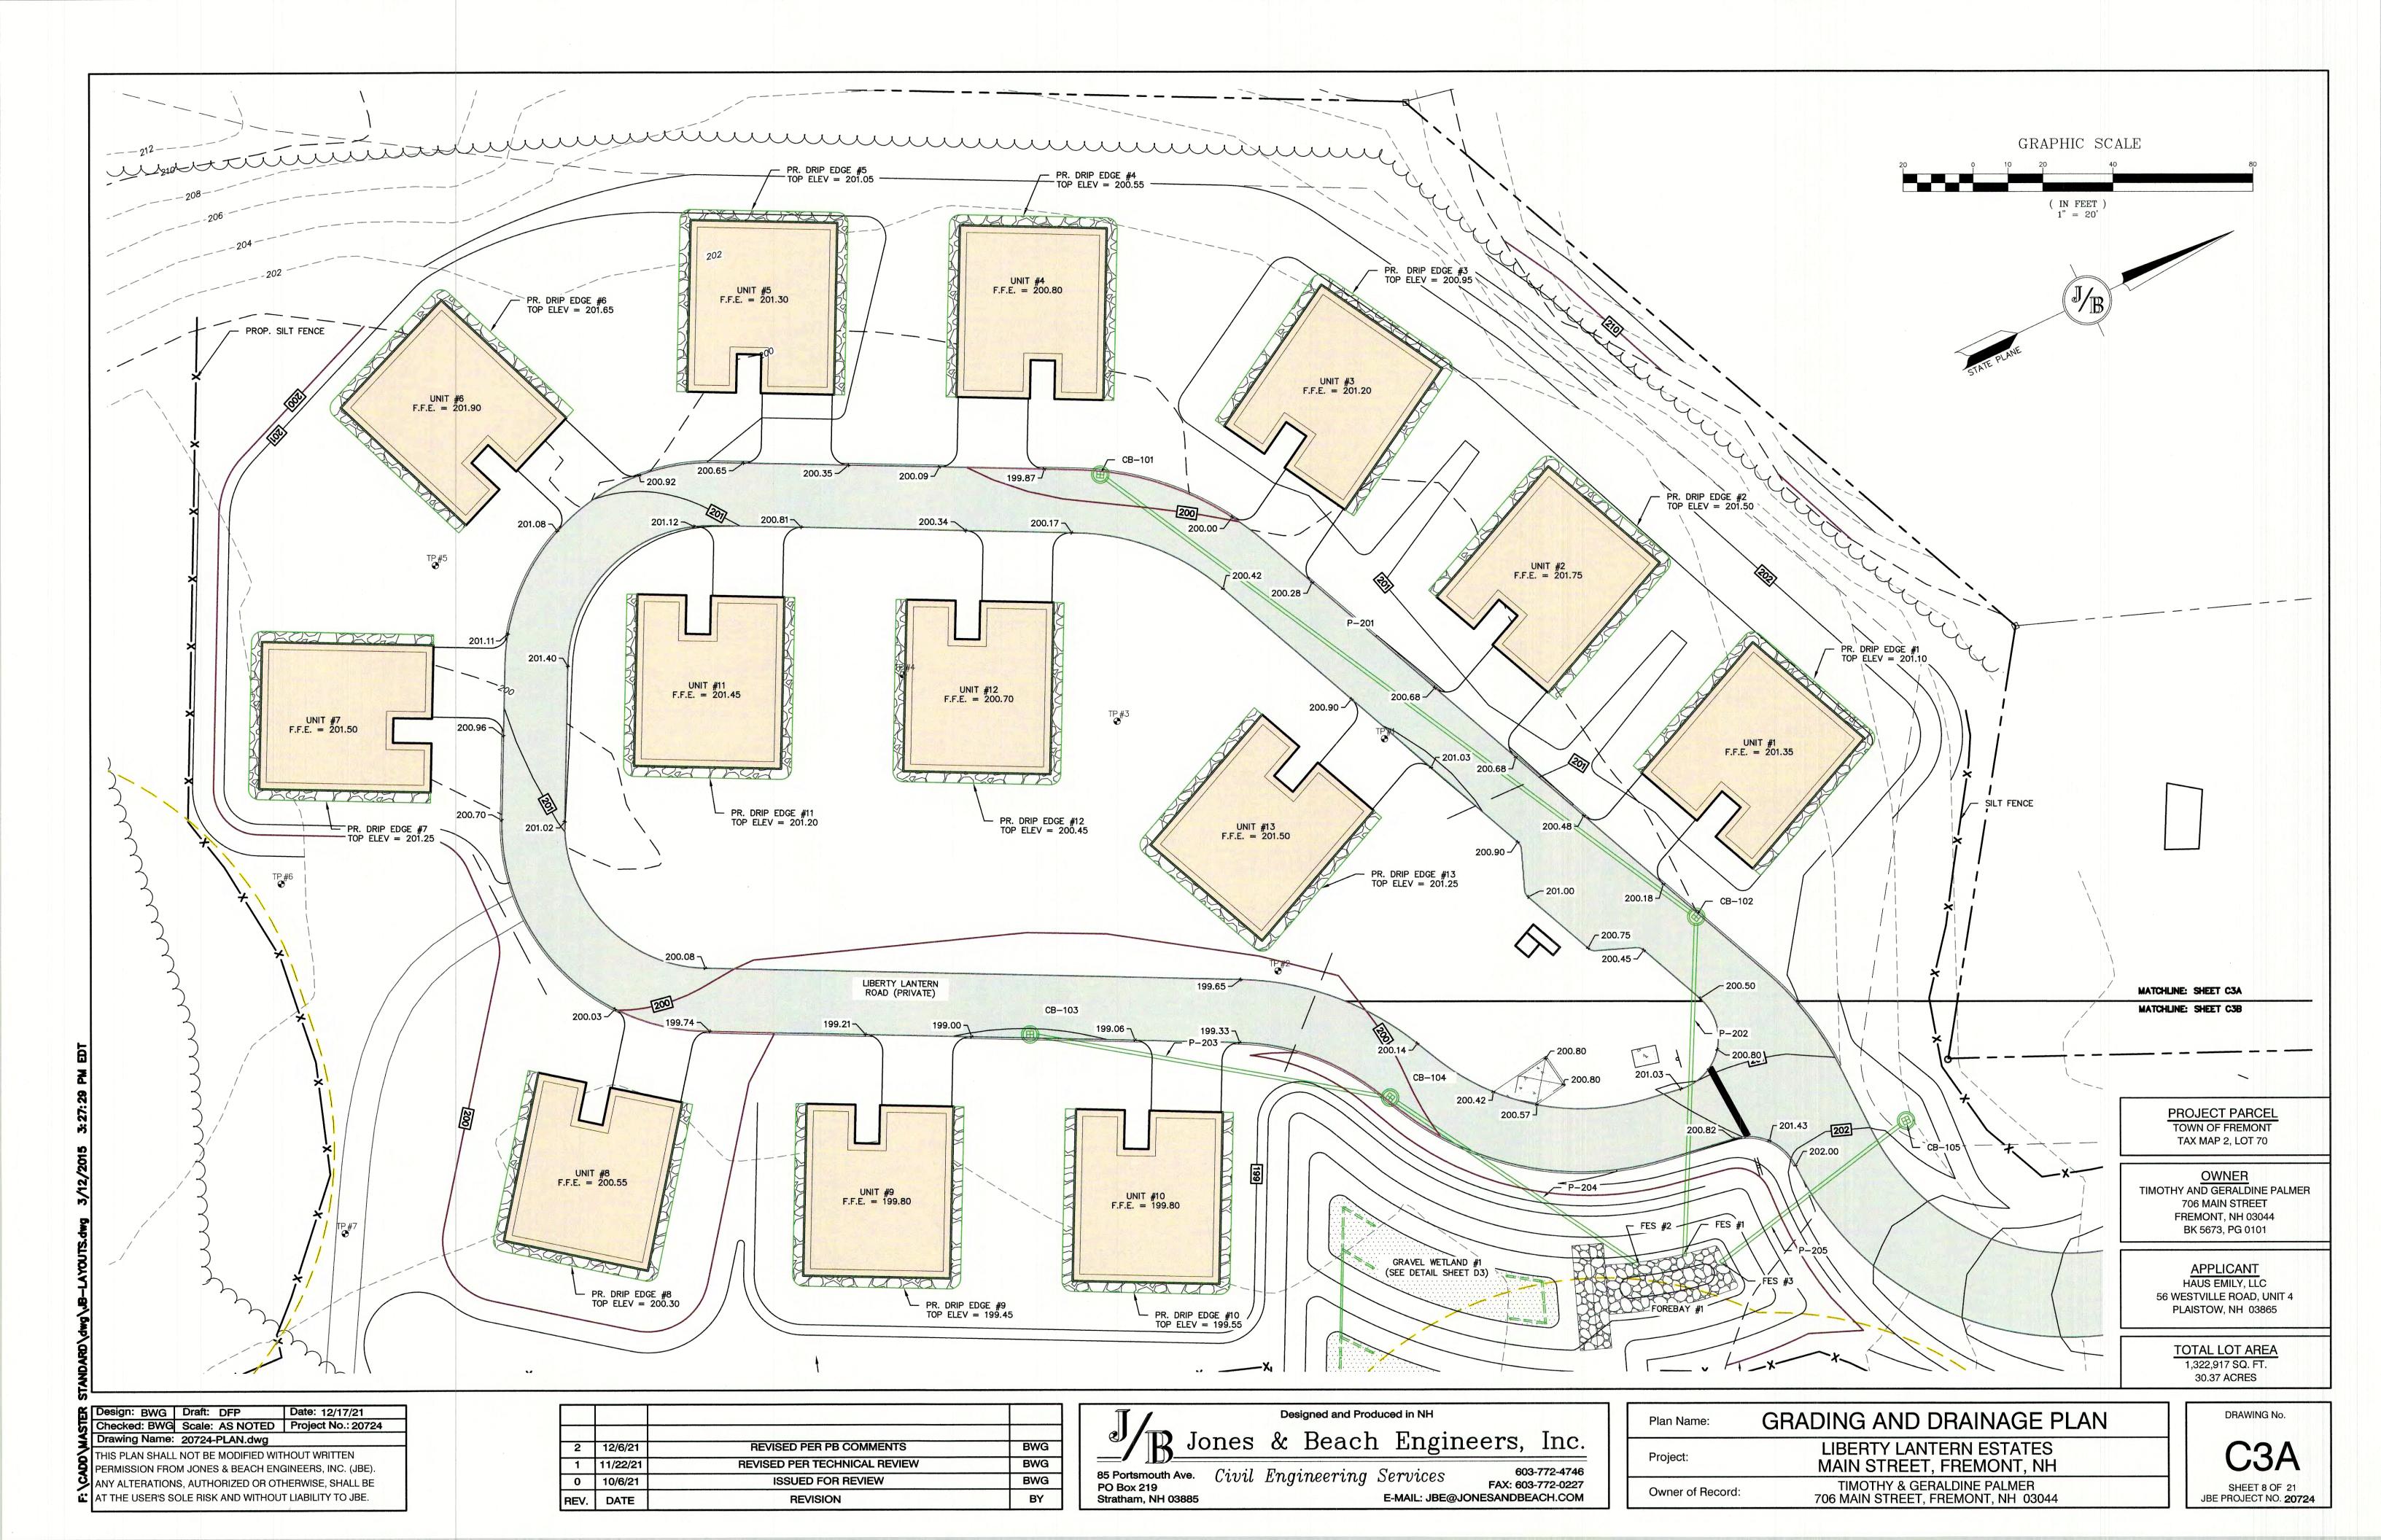

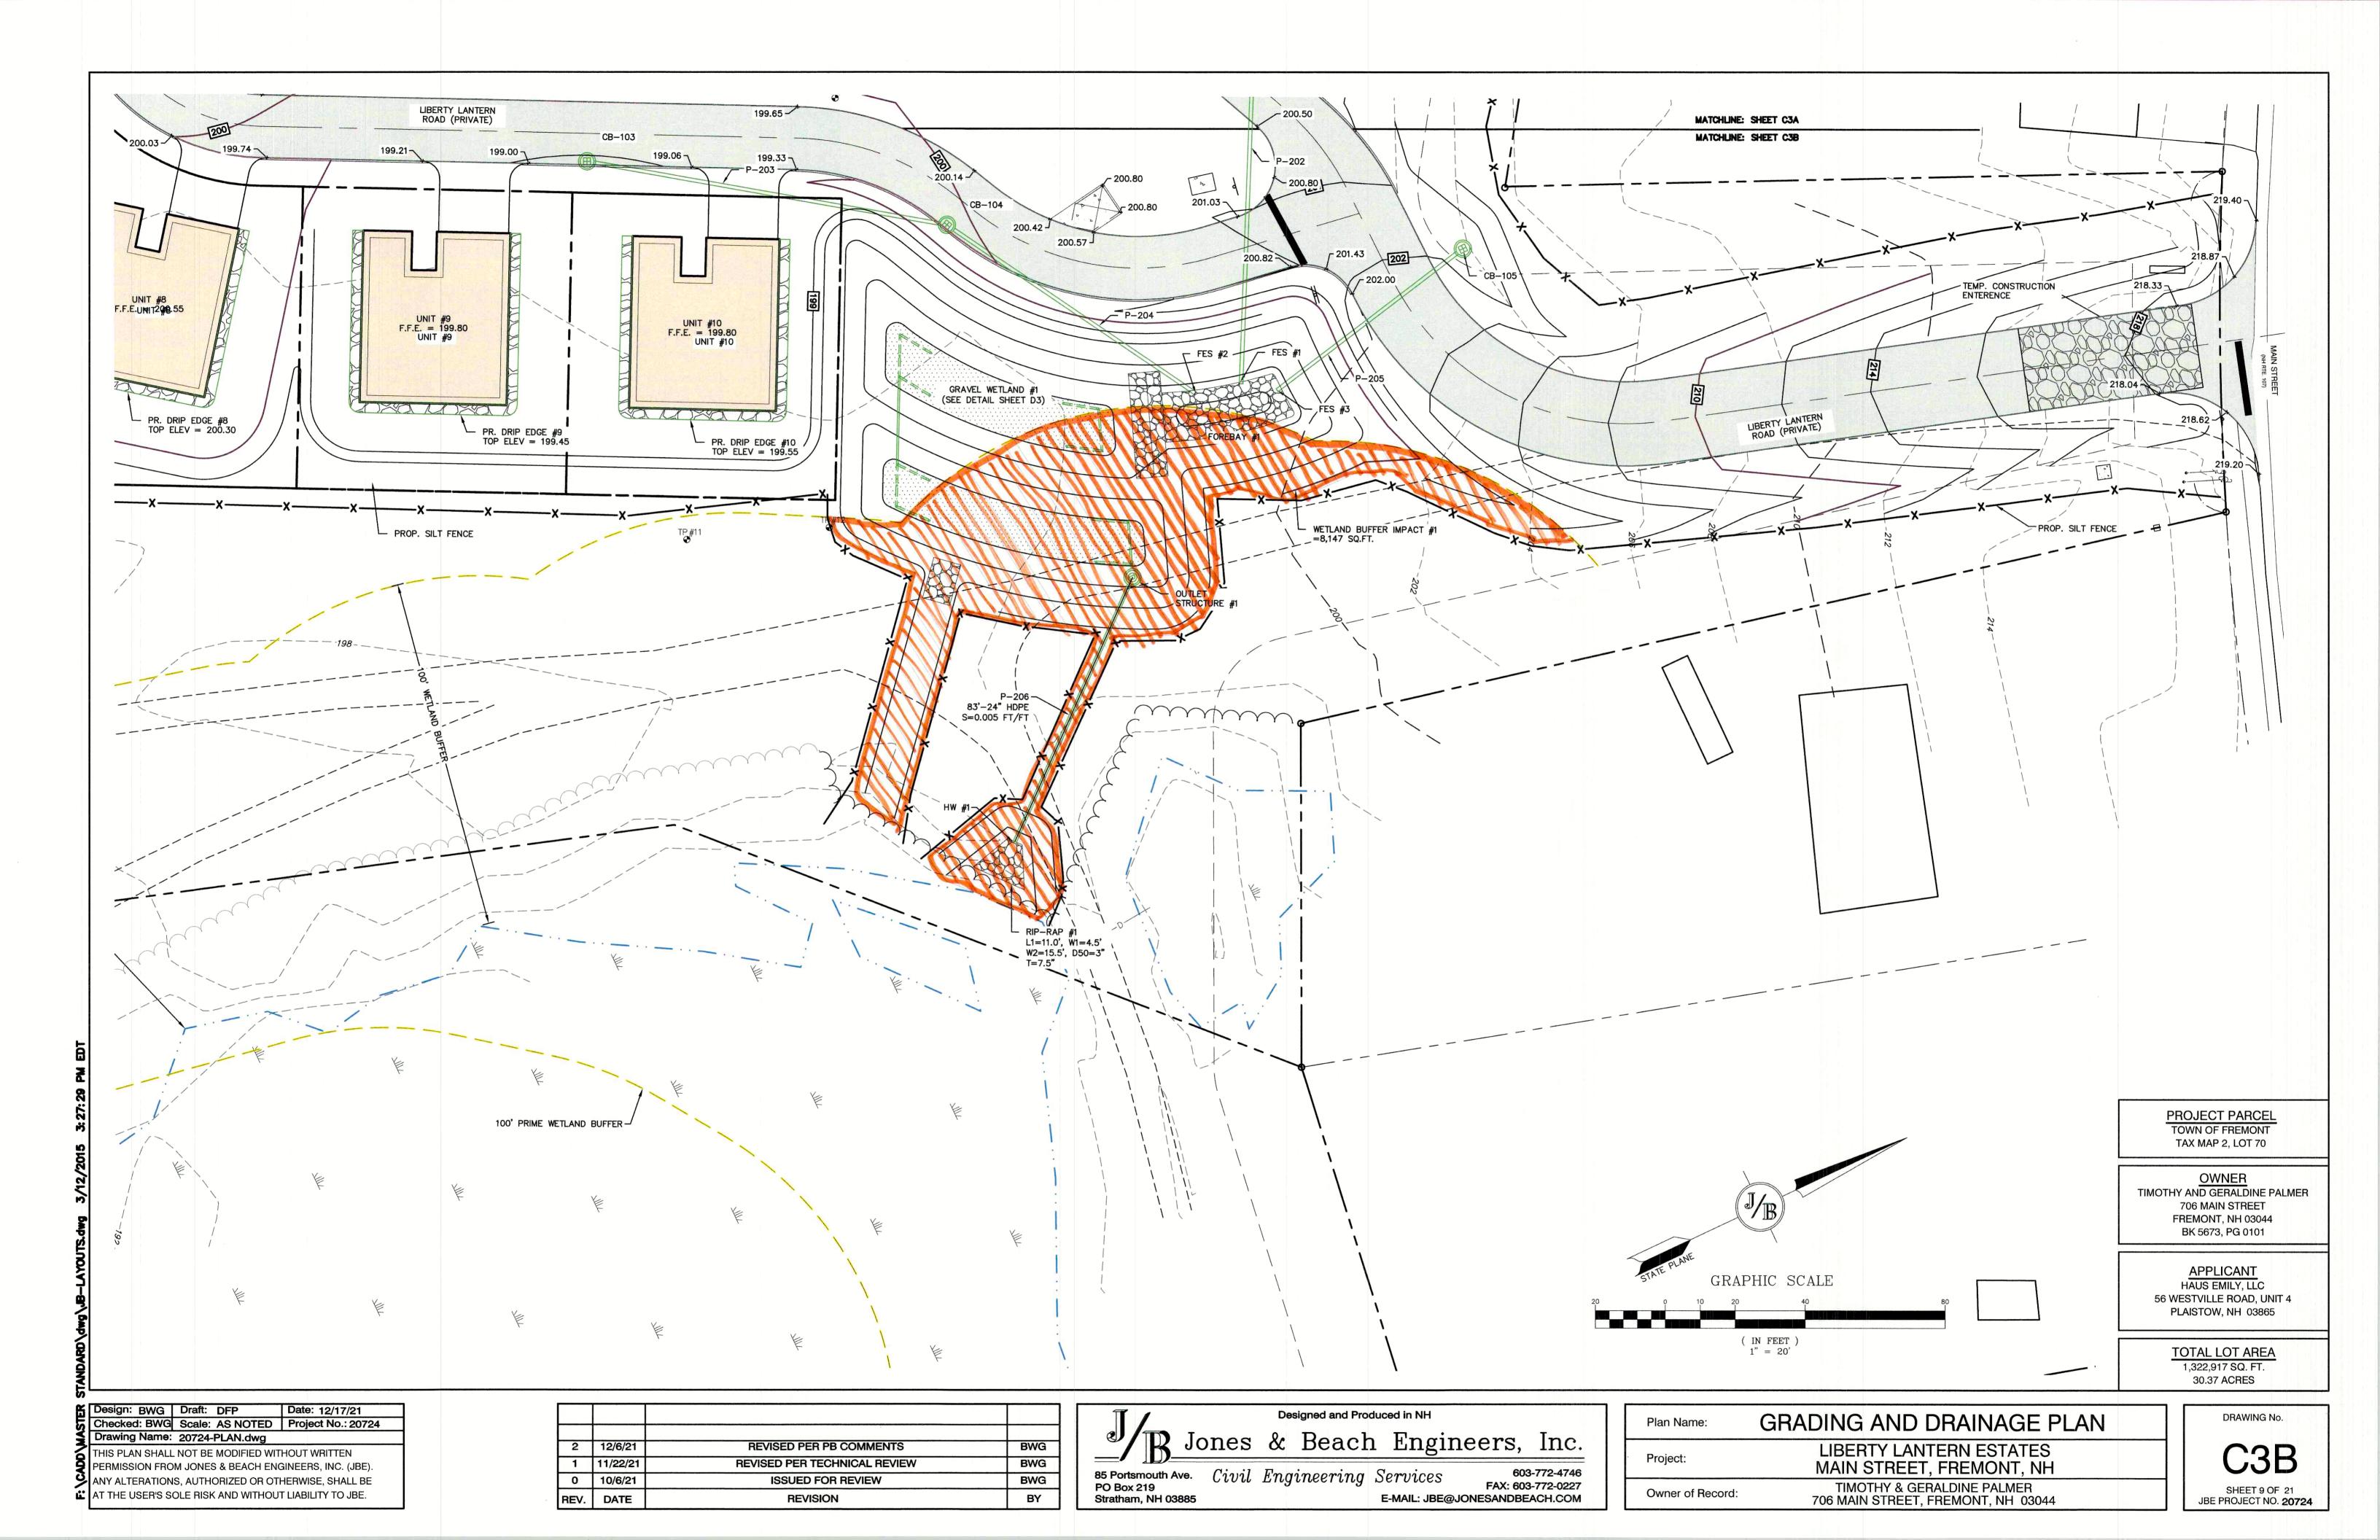

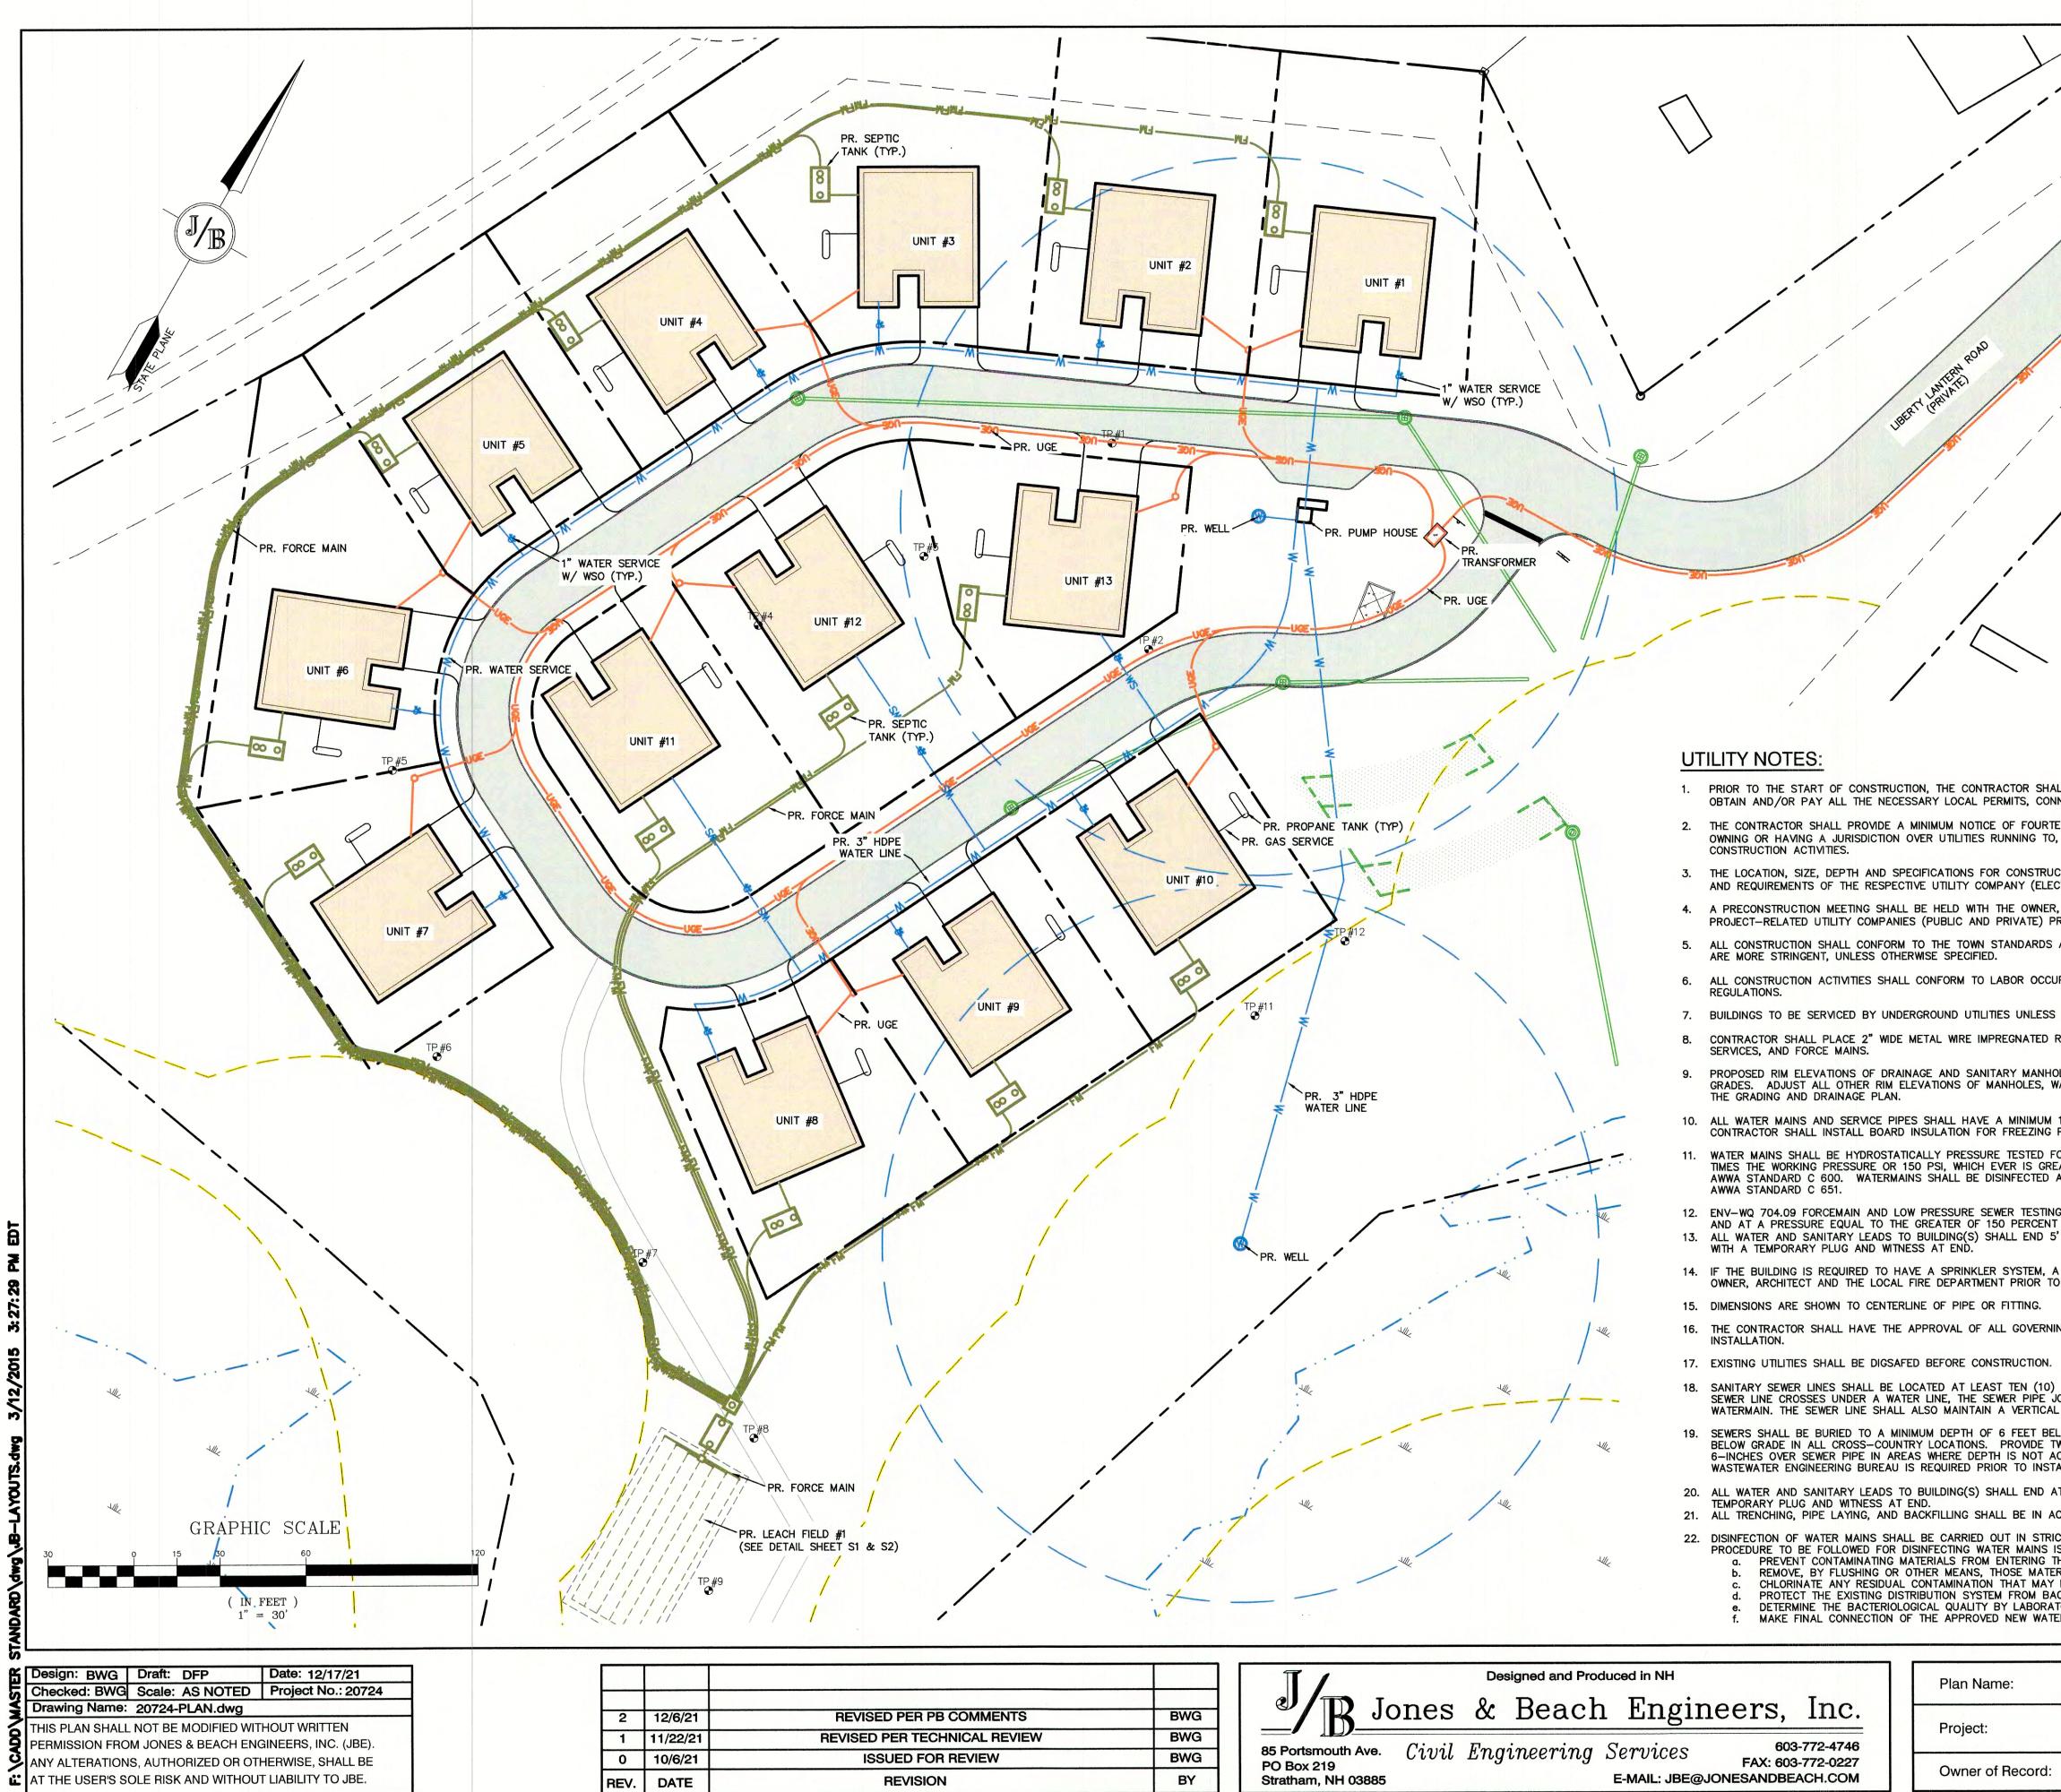

WOR WOR		i		
	TILITY NOTES:			
	PRIOR TO THE START OF CONSTRUCT OBTAIN AND/OR PAY ALL THE NECES	ION, THE CONTRACTOR SHALL COORD SSARY LOCAL PERMITS, CONNECTION I	NATE WITH THE ENGINEER, ARCHITECT AND/OR OWNER, IN ORDER TO FEES AND BONDS.	
PR. PROPANE TANK (TYP) PR. GAS SERVICE	THE CONTRACTOR SHALL PROVIDE A OWNING OR HAVING A JURISDICTION O CONSTRUCTION ACTIVITIES.	MINIMUM NOTICE OF FOURTEEN (14) OVER UTILITIES RUNNING TO, THROUG	DAYS TO ALL CORPORATIONS, COMPANIES AND/OR LOCAL AUTHORITIES H OR ACROSS PROJECT AREAS PRIOR TO DEMOLITION AND/OR	
UNIT #10.			PROPOSED PRIVATE UTILITY SERVICES SHALL BE TO THE STANDARDS EPHONE, CABLE TELEVISION, FIRE ALARM.	
4.	A PRECONSTRUCTION MEETING SHALL PROJECT-RELATED UTILITY COMPANIE		R, ARCHITECT, CONTRACTOR, LOCAL OFFICIALS, AND ALL START OF CONSTRUCTION.	
5.	ALL CONSTRUCTION SHALL CONFORM ARE MORE STRINGENT, UNLESS OTHEI	TO THE TOWN STANDARDS AND REGUNERED FOR THE TOWN STANDARDS AND REGULE	ULATIONS, AND NHDES STANDARDS AND SPECIFICATIONS, WHICHEVER	
6.	ALL CONSTRUCTION ACTIVITIES SHALL REGULATIONS.	. CONFORM TO LABOR OCCUPATIONAL	. SAFETY AND HEALTH ADMINISTRATION (OSHA) RULES AND	
TP #11 7.	BUILDINGS TO BE SERVICED BY UNDE			
8.	CONTRACTOR SHALL PLACE 2" WIDE SERVICES, AND FORCE MAINS.	METAL WIRE IMPREGNATED RED PLAS	TIC WARNING TAPE OVER ENTIRE LENGTH OF ALL GRAVITY SEWERS,	
9. PR. 3" HDPE WATER LINE	PROPOSED RIM ELEVATIONS OF DRAIN GRADES. ADJUST ALL OTHER RIM EL THE GRADING AND DRAINAGE PLAN.	NAGE AND SANITARY MANHOLES ARE EVATIONS OF MANHOLES, WATER GAT	APPROXIMATE. FINAL ELEVATIONS ARE TO BE SET FLUSH WITH FINISH TES, GAS GATES AND OTHER UTILITIES TO FINISH GRADE AS SHOWN ON	
10	ALL WATER MAINS AND SERVICE PIPE CONTRACTOR SHALL INSTALL BOARD	S SHALL HAVE A MINIMUM 12" VERTI INSULATION FOR FREEZING PROTECTION	ICAL AND 24" HORIZONTAL SEPARATION TO MANHOLES, OR ON.	
	TIMES THE WORKING PRESSURE OR 1	50 PSI, WHICH EVER IS GREATER. TI	AGE PRIOR TO ACCEPTANCE. WATERMAINS SHALL BE TESTED AT 1.5 ESTING SHALL BE CONDUCTED IN ACCORDANCE WITH SECTION 4 OF E ACCEPTANCE OF THE PRESSURE AND LEAKAGE TESTS ACCORDING TO	
	AND AT A PRESSURE EQUAL TO THE	GREATER OF 150 PERCENT OF THE BUILDING(S) SHALL END 5' OUTSIDE	L BE TESTED IN ACCORDANCE WITH SECTION 4 OF AWWA C600-05, DESIGN OPERATING TOTAL DYNAMIC HEAD OR AT LEAST 100 PSI. THE BUILDING LIMITS AS SHOWN ON PLANS AND SHALL BE PROVIDED	
	IF THE BUILDING IS REQUIRED TO HA OWNER, ARCHITECT AND THE LOCAL		STRUCTION MEETING SHALL BE HELD BETWEEN THE CONTRACTOR, ITALLATION.	
	DIMENSIONS ARE SHOWN TO CENTERL		CIES HAVING JURISDICTION OVER FIRE PROTECTION SYSTEM PRIOR TO	PROJECT PARCEL TOWN OF FREMONT
	INSTALLATION.		SIES HAVING JURISDICTION OVER FIRE PROTECTION STSTEM PRIOR TO	TAX MAP 2, LOT 70
	. EXISTING UTILITIES SHALL BE DIGSAFT . SANITARY SEWER LINES SHALL BE LO	DCATED AT LEAST TEN (10) FEET HOP	RIZONTALLY FROM AN EXISTING OR PROPOSED WATER LINE. WHEN A	OWNER
, , , , , , , , , , , , , , , , , , , ,	WATERMAIN. THE SEWER LINE SHALL	ALSO MAINTAIN A VERTICAL SEPARA		TIMOTHY AND GERALDINE PALMER 706 MAIN STREET
	BELOW GRADE IN ALL CROSS-COUNT	RY LOCATIONS. PROVIDE TWO-INCHE AS WHERE DEPTH IS NOT ACHIEVED.	DE IN ALL ROADWAY LOCATIONS, AND TO A MINIMUM DEPTH OF 4 FEET ES OF R-10 FOAM BOARD INSULATION 2-FOOT WIDE TO BE INSTALLED A WAIVER FROM THE DEPARTMENT OF ENVIRONMENTAL SERVICES EWER AT LESS THAN MINIMUM COVER.	FREMONT, NH 03044 BK 5673, PG 0101
	. ALL WATER AND SANITARY LEADS TO TEMPORARY PLUG AND WITNESS AT I . ALL TRENCHING, PIPE LAYING, AND E	END.	OF WAY AS SHOWN ON PLANS AND SHALL BE PROVIDED WITH A	APPLICANT HAUS EMILY, LLC
	PROCEDURE TO BE FOLLOWED FOR D a. PREVENT CONTAMINATING M	ISINFECTING WATER MAINS IS AS FOL ATERIALS FROM ENTERING THE WATER	DANCE WITH AWWA STANDARD C651, LATEST EDITION. THE BASIC LOWS: R MAIN DURING STORAGE, CONSTRUCTION, OR REPAIR. AT MAY HAVE ENTERED THE WATER MAINS.	56 WESTVILLE ROAD, UNIT 4 PLAISTOW, NH 03865
$\dot{-}$	 c. CHLORINATE ANY RESIDUAL d. PROTECT THE EXISTING DIST e. DETERMINE THE BACTERIOLO 	CONTAMINATION THAT MAY REMAIN.	AND FLUSH THE CHLORINATED WATER FROM THE MAIN. DUE TO HYDROSTATIC PRESSURE TEST AND DISINFECTION PROCEDURES. T AFTER DISINFECTION.	TOTAL LOT AREA 1,322,917 SQ. FT. 30.37 ACRES
Designed and Produced in NH		Plan Name:	UTILITY PLAN	DRAWING No.
BWG Jones & Beach Engi	neers, Inc.		LIBERTY LANTERN ESTATES	
BWG 85 Portsmouth Ave. Civil Engineering Services	603-772-4746	Project:	MAIN STREET, FREMONT, NH	04
PO Box 219	FAX: 603-772-0227 JONESANDBEACH.COM	Owner of Record:	TIMOTHY & GERALDINE PALMER 706 MAIN STREET, FREMONT, NH 03044	SHEET 10 OF 21 JBE PROJECT NO. 20724


PR. TRANSFORMER

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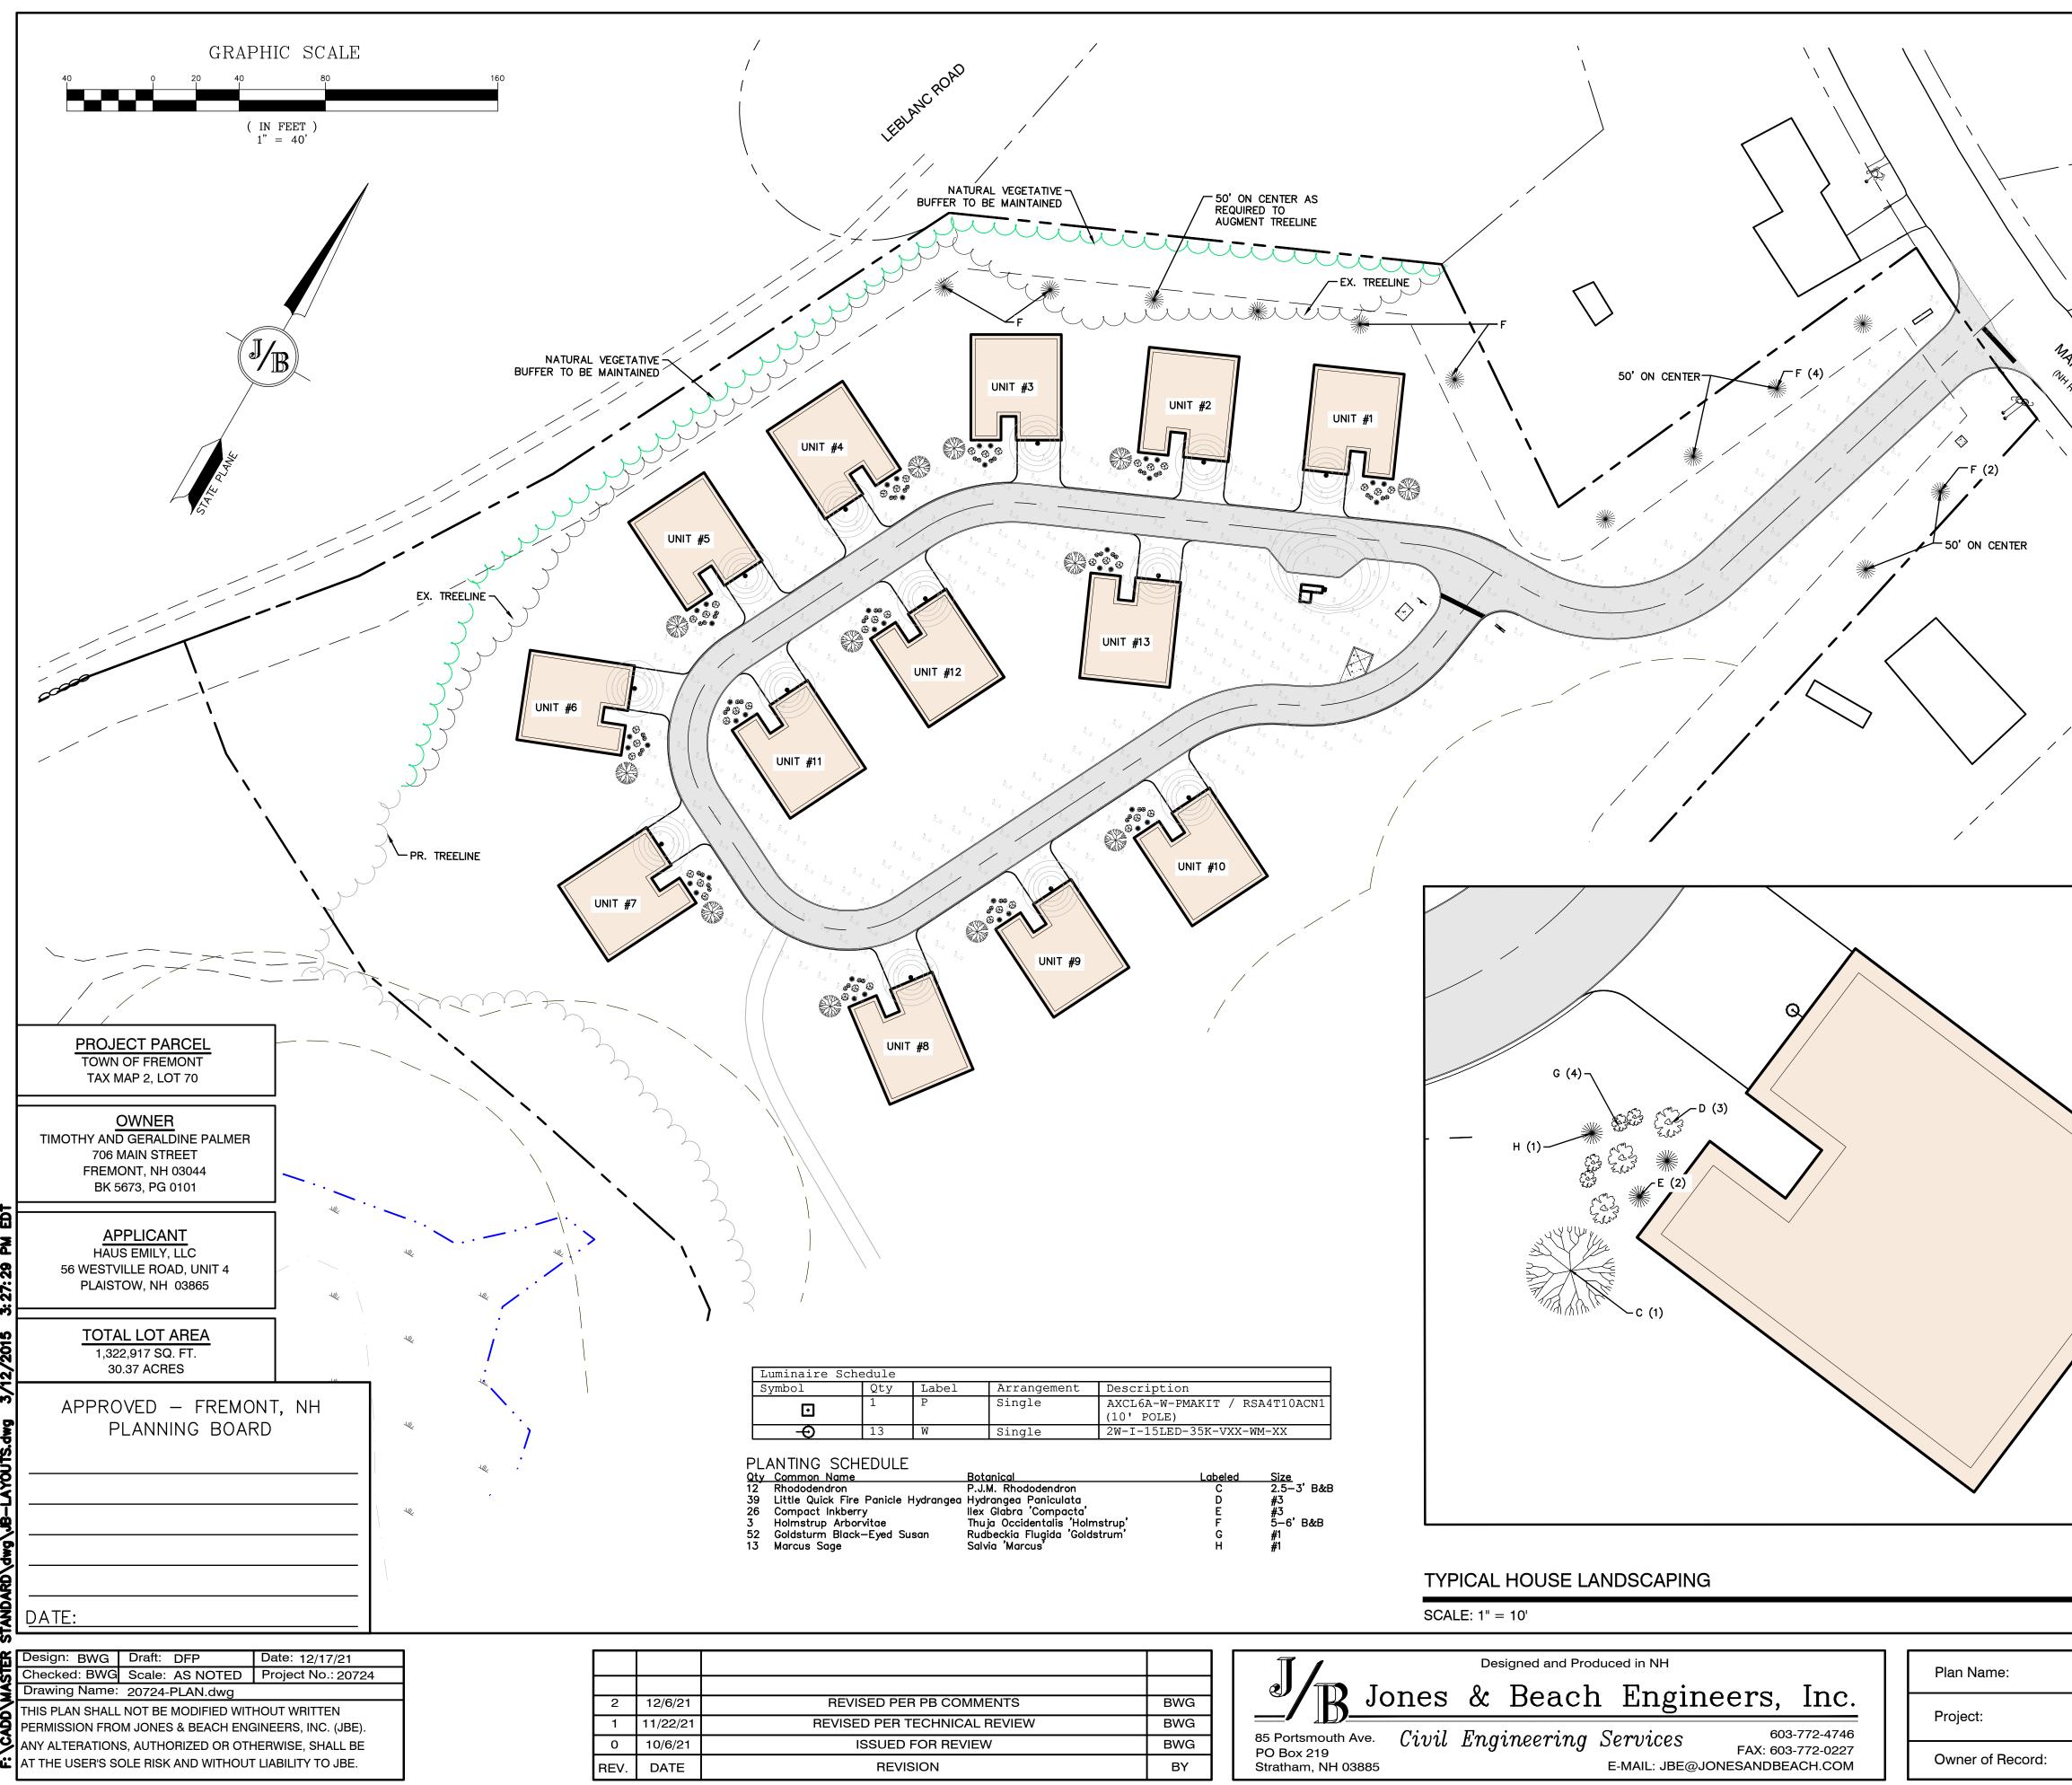
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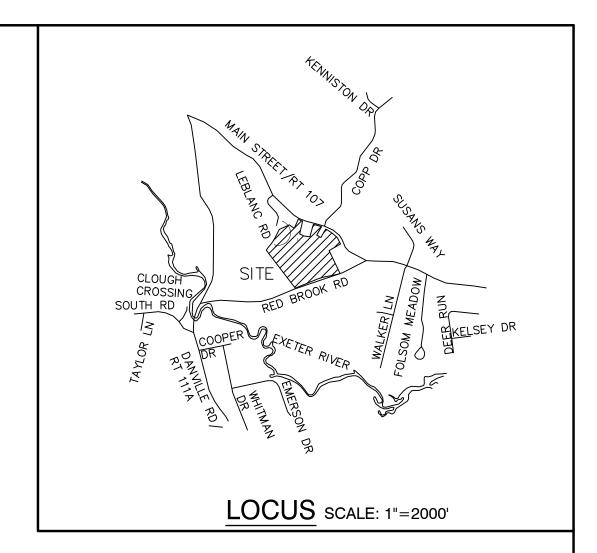
~ /

PR. UTILITY POLE DROP



		Designed and Produced in NH Plan Name:
ITS	BWG	Jones & Beach Engineers, Inc.
VIEW	BWG	Project:
	BWG	85 Portsmouth Ave. Civil Engineering Services 603-772-4746 PO Box 219 FAX: 603-772-0227
	BY	Stratham, NH 03885 E-MAIL: JBE@JONESANDBEACH.COM Owner of Record

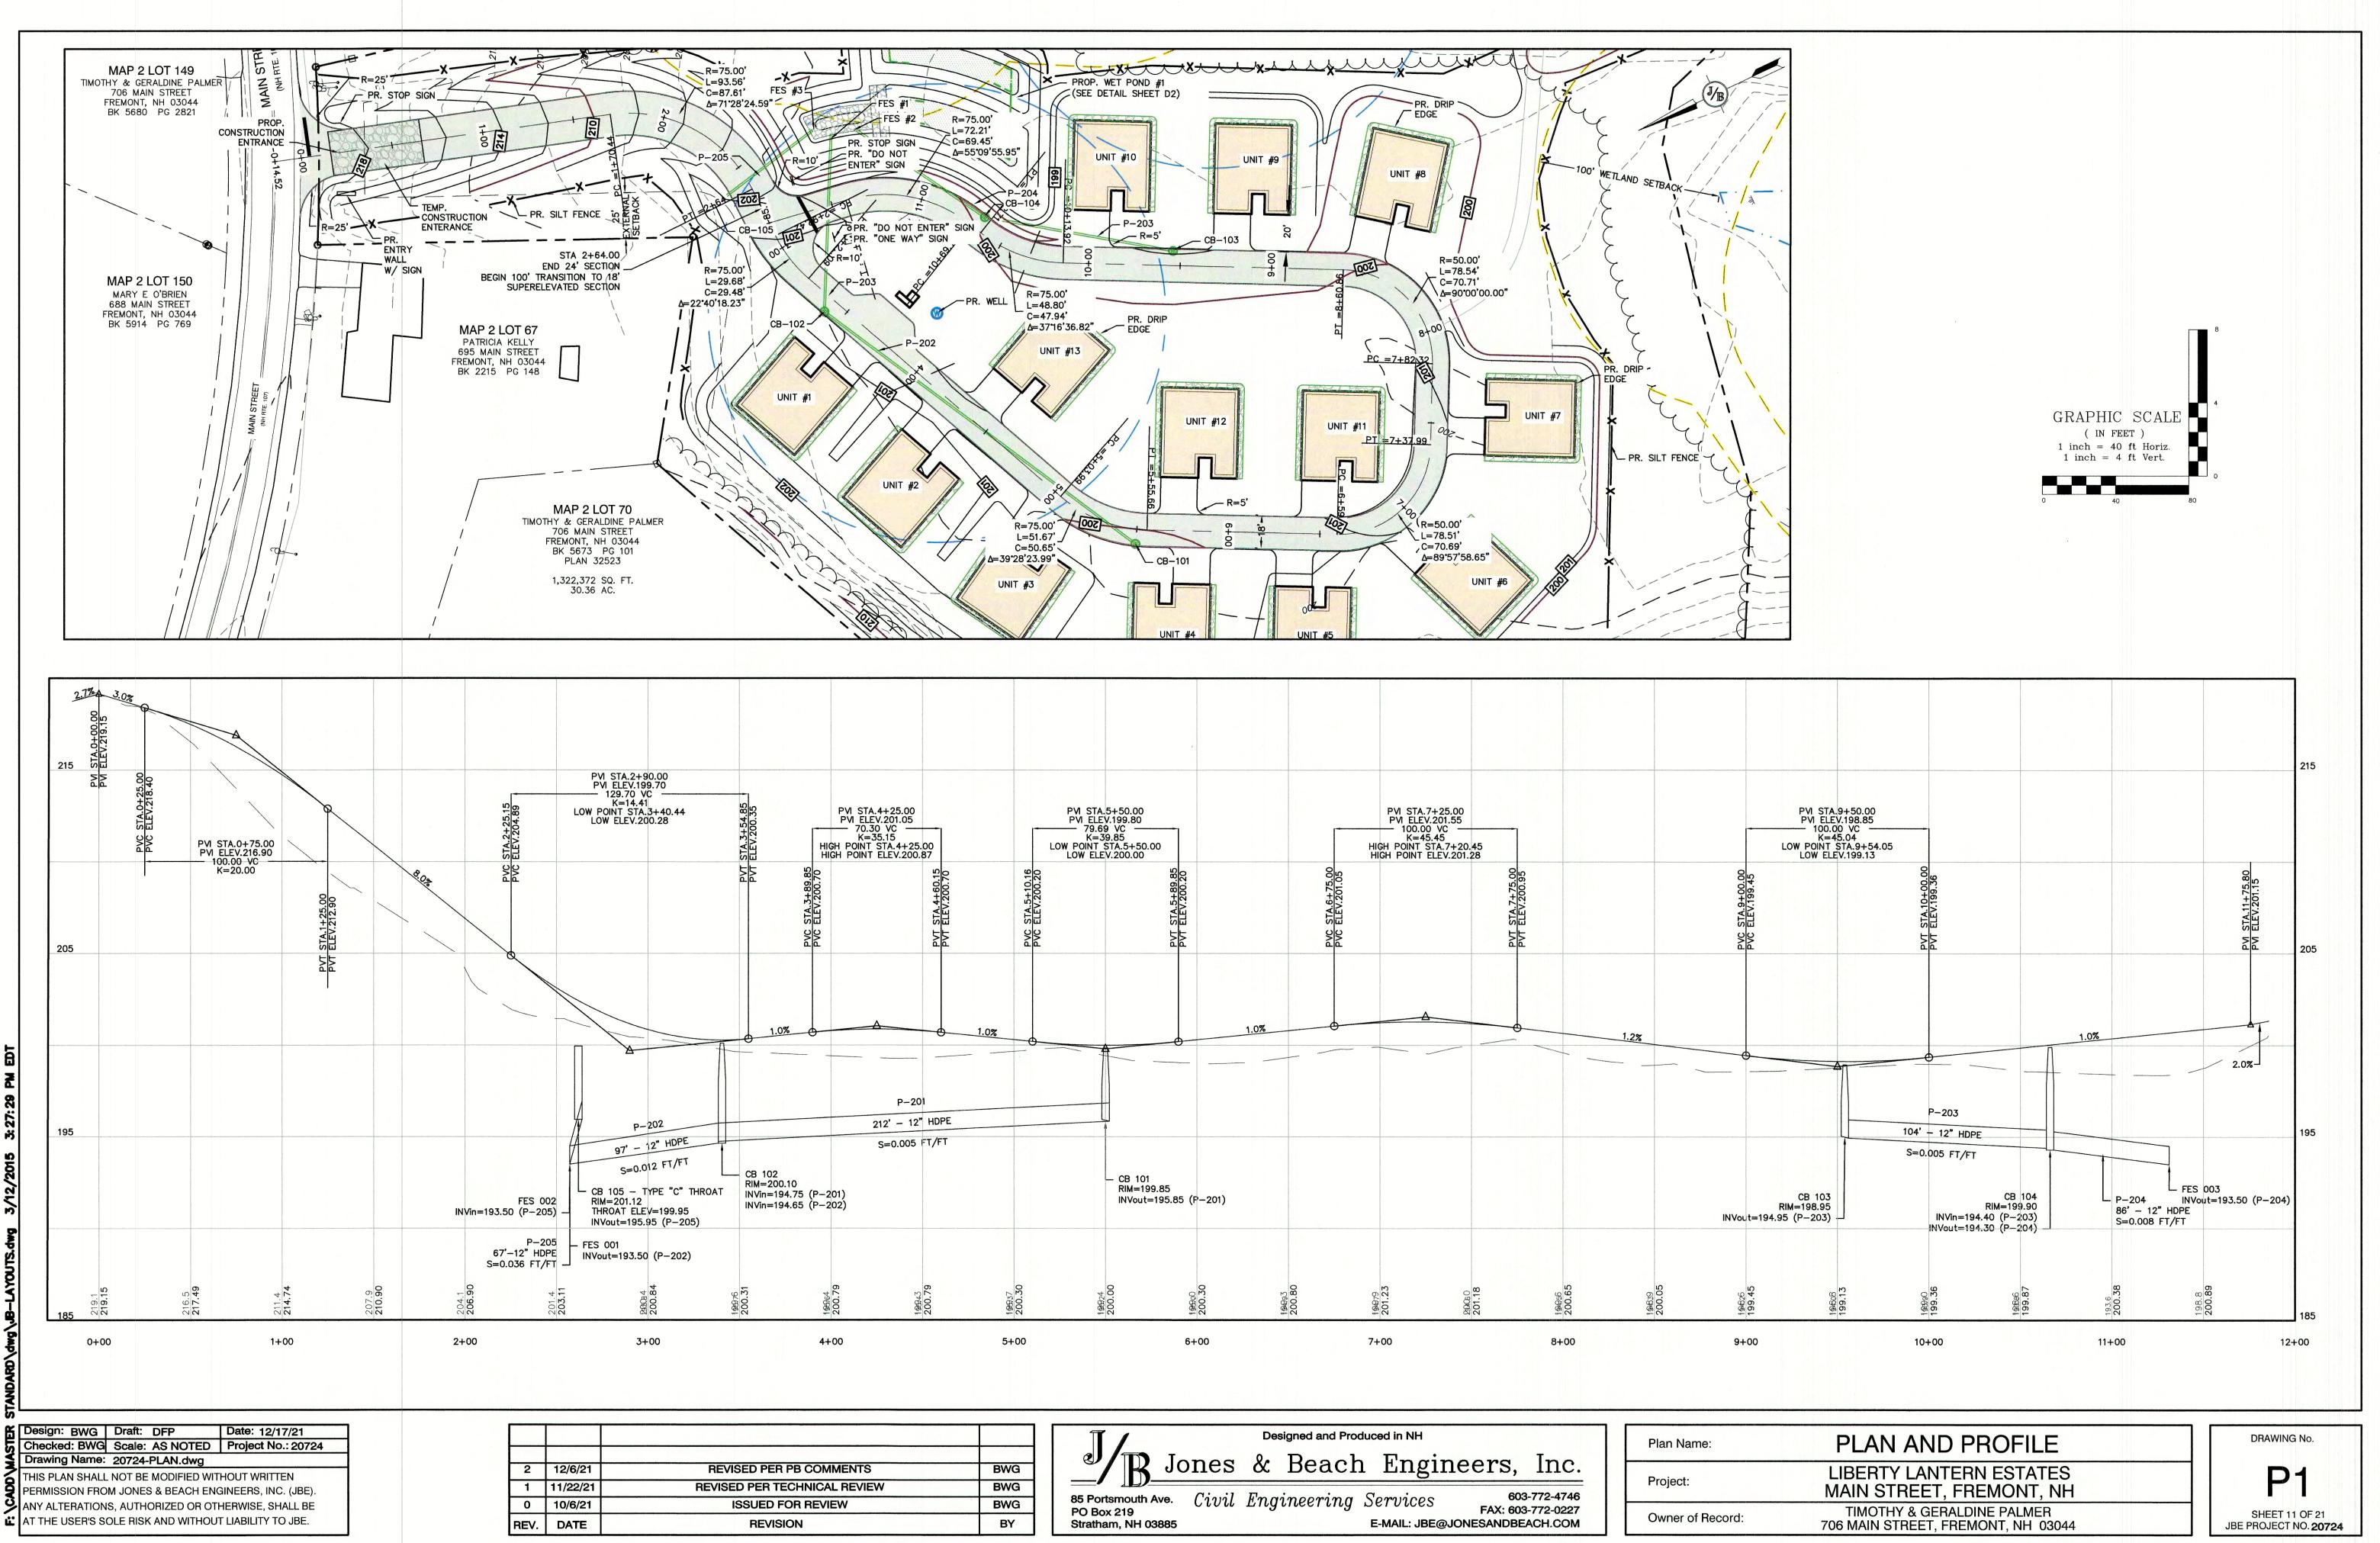





LANDSCAPE NOTES:

- THE CONTRACTOR SHALL LOCATE AND VERIFY THE EXISTENCE OF ALL UTILITIES PRIOR TO 1. STARTING WORK.
- 2. THE CONTRACTOR SHALL SUPPLY ALL PLANT MATERIALS IN QUANTITIES SUFFICIENT TO COMPLETE THE PLANTINGS SHOWN ON THE DRAWINGS.
- 3. ALL MATERIAL SHALL CONFORM TO THE GUIDELINES ESTABLISHED BY THE CURRENT AMERICAN STANDARD FOR NURSERY STOCK PUBLISHED BY THE AMERICAN ASSOCIATION OF NURSERYMEN.
- 4. ALL PLANT MATERIALS SHALL BE EXACTLY AS SPECIFIED. IF PLANT SPECIES CULTIVARS ARE FOUND TO VARY FROM THAT SPECIFIED AT ANY TIME DURING THE GUARANTEE PERIOD, THE LANDSCAPE ARCHITECT RESERVES THE RIGHT TO HAVE THE CONTRACTOR REPLACE THAT PLANT MATERIAL.
- PLANTS SHALL BE SUBJECT TO INSPECTION AND APPROVAL AT THE PLACE OF GROWTH, UPON 5. DELIVERY OR AT THE JOB SITE WHILE WORK IS ON-GOING FOR CONFORMITY TO SPECIFIED QUALITY, SIZE AND VARIETY.
- 6. PLANTS FURNISHED IN CONTAINERS SHALL HAVE THE ROOTS WELL ESTABLISHED IN THE SOIL MASS AND SHALL HAVE AT LEAST ONE (1) GROWING SEASON. ROOT-BOUND PLANTS OR INADEQUATELY SIZED CONTAINERS TO SUPPORT THE PLANT MAY BE DEEMED UNACCEPTABLE.
- 7. NO PLANT SHALL BE PUT IN THE GROUND BEFORE GRADING HAS BEEN FINISHED AND APPROVED BY THE LANDSCAPE ARCHITECT.
- 8. ALL WORK AND PLANTS SHALL BE DONE, INSTALLED AND DETAILED IN STRICT ACCORDANCE WITH PROJECT SPECIFICATIONS.
- 9. ALL PLANTS SHALL BE WATERED THOROUGHLY TWICE DURING THE FIRST 24-HOUR PERIOD AFTER PLANTING. ALL PLANTS SHALL BE WATERED WEEKLY, OR MORE OFTEN IF NECESSARY, DURING THE FIRST GROWING SEASON.
- 10. ALL PLANTS SHALL BE GUARANTEED BY THE CONTRACTOR FOR NOT LESS THAN ONE FULL YEAR FROM THE TIME OF PROVISIONAL ACCEPTANCE. DURING THIS TIME, THE OWNER SHALL MAINTAIN ALL PLANT MATERIALS IN THE ABOVE MANNER. IT IS THE CONTRACTOR'S RESPONSIBILITY TO INSPECT THE PLANTS TO ENSURE PROPER CARE. IF THE CONTRACTOR IS DISSATISFIED WITH THE CARE GIVEN, HE SHALL IMMEDIATELY, AND IN SUFFICIENT TIME TO PERMIT THE CONDITION TO BE RECTIFIED, NOTIFY THE LANDSCAPE ARCHITECT IN WRITING OR OTHERWISE FORFEIT HIS CLAIM.
- 11. FINAL ACCEPTANCE WILL BE MADE UPON THE CONTRACTOR'S REQUEST AFTER ALL CORRECTIVE WORK HAS BEEN COMPLETED.
- 12. BY THE END OF THE GUARANTEE PERIOD, THE CONTRACTOR SHALL HAVE REPLACED ANY PLANT MATERIAL THAT IS MISSING, NOT TRUE TO SIZE AS SPECIFIED, THAT HAS DIED, LOST NATURAL SHAPE DUE TO DEAD BRANCHES, EXCESSIVE PRUNING OR INADEQUATE OR IMPROPER CARE, OR THAT IS, IN THE OPINION OF THE LANDSCAPE ARCHITECT, IN UNHEALTHY OR UNSIGHTLY CONDITION.
- 13. THE CONTRACTOR SHALL REMOVE WEEDS, ROCKS, CONSTRUCTION ITEMS, ETC. FROM ANY LANDSCAPE AREA SO DESIGNATED TO REMAIN, WHETHER ON OR OFF-SITE. GRASS SEED OR PINE BARK MULCH SHALL BE APPLIED AS DEPICTED ON PLANS.
- 14. ALL LANDSCAPING SHALL MEET THE TOWN STANDARDS AND REGULATIONS.
- 15. ALL MULCH AREAS SHALL RECEIVE A 3" LAYER OF SHREDDED PINE BARK MULCH OVER A 10 MIL WEED MAT EQUAL TO 'WEEDBLOCK' BY EASY GARDENER OR DEWITT WEED BARRIER.
- 16. ALL LANDSCAPED AREAS SHALL HAVE SELECT MATERIALS REMOVED TO A DEPTH OF AT LEAST 9" BELOW FINISH GRADE. THE RESULTING VOID IS TO BE FILLED WITH A MINIMUM OF 9" HIGH-QUALITY SCREENED LOAM AMENDED WITH 3" OF AGED ORGANIC COMPOST.
- 17. THIS PLAN IS INTENDED FOR LANDSCAPING PURPOSES ONLY. REFER TO CIVIL/SITE DRAWINGS FOR OTHER SITE CONSTRUCTION INFORMATION.

LANDSCAPING PLAN
TAX MAP 2 LOT 70
LIBERTY LANTERN ESTATES MAIN STREET, FREMONT, NH
TIMOTHY & GERALDINE PALMER

706 MAIN STREET, FREMONT, NH 03044

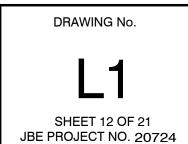

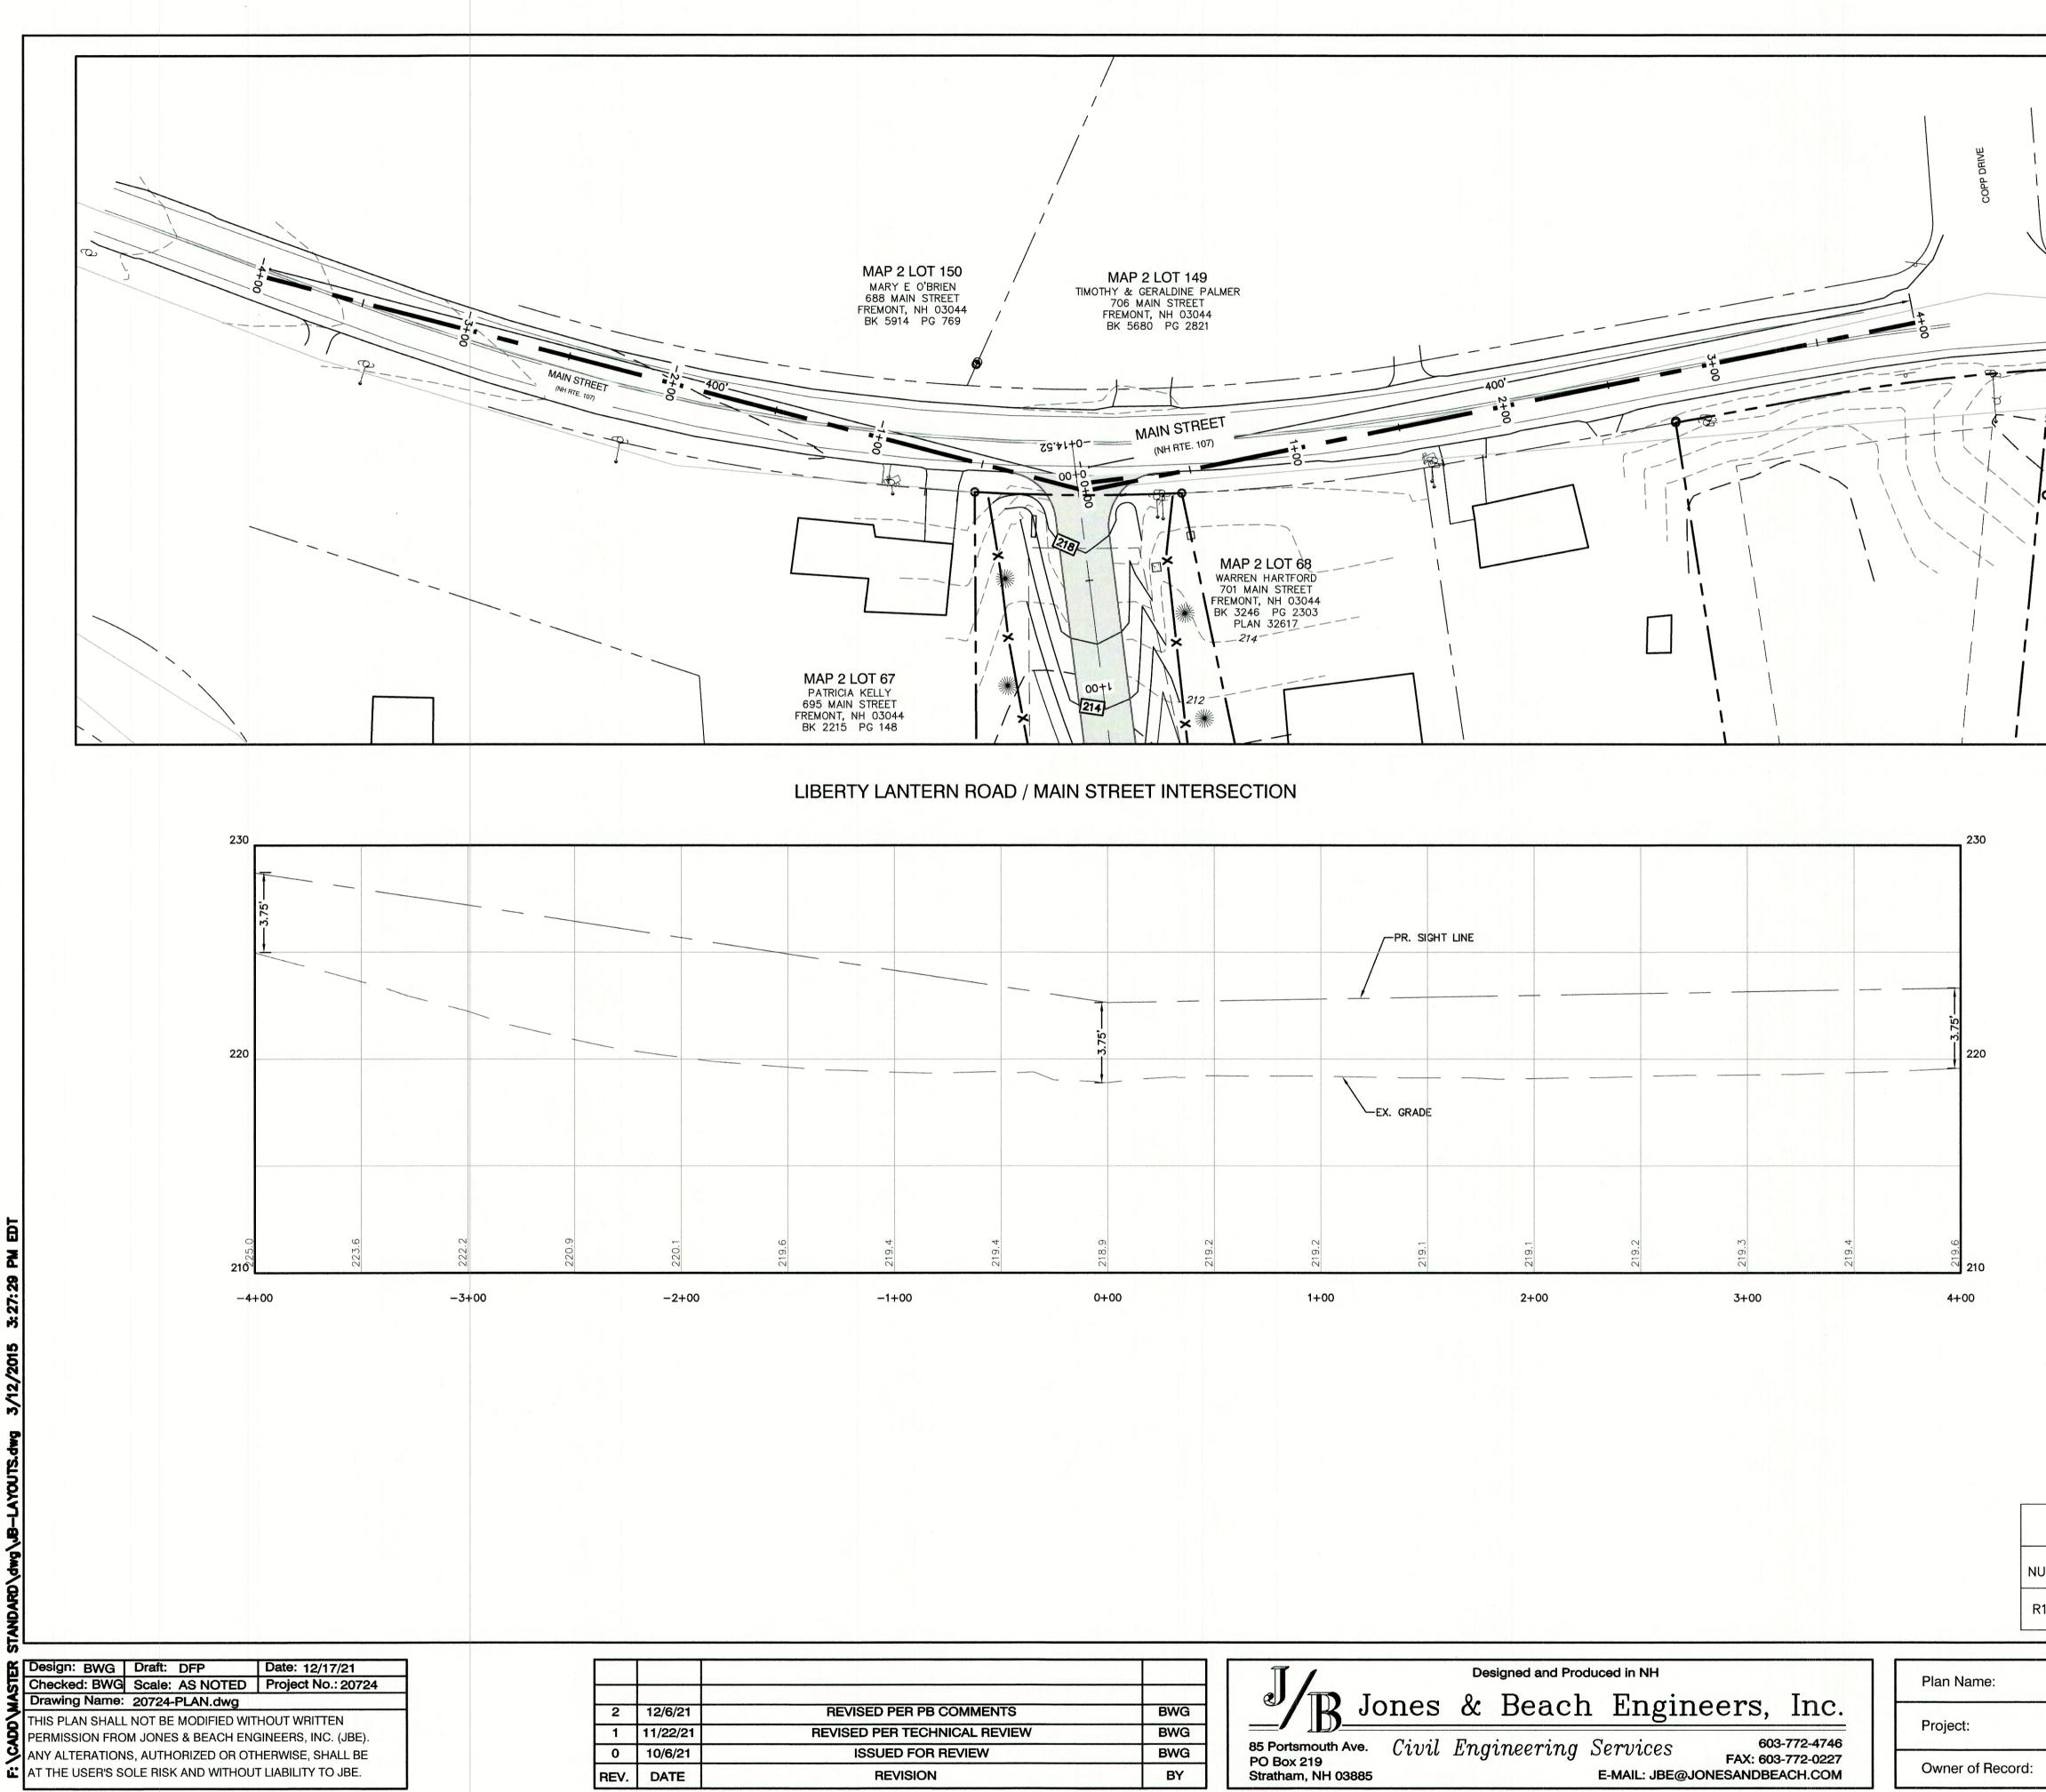


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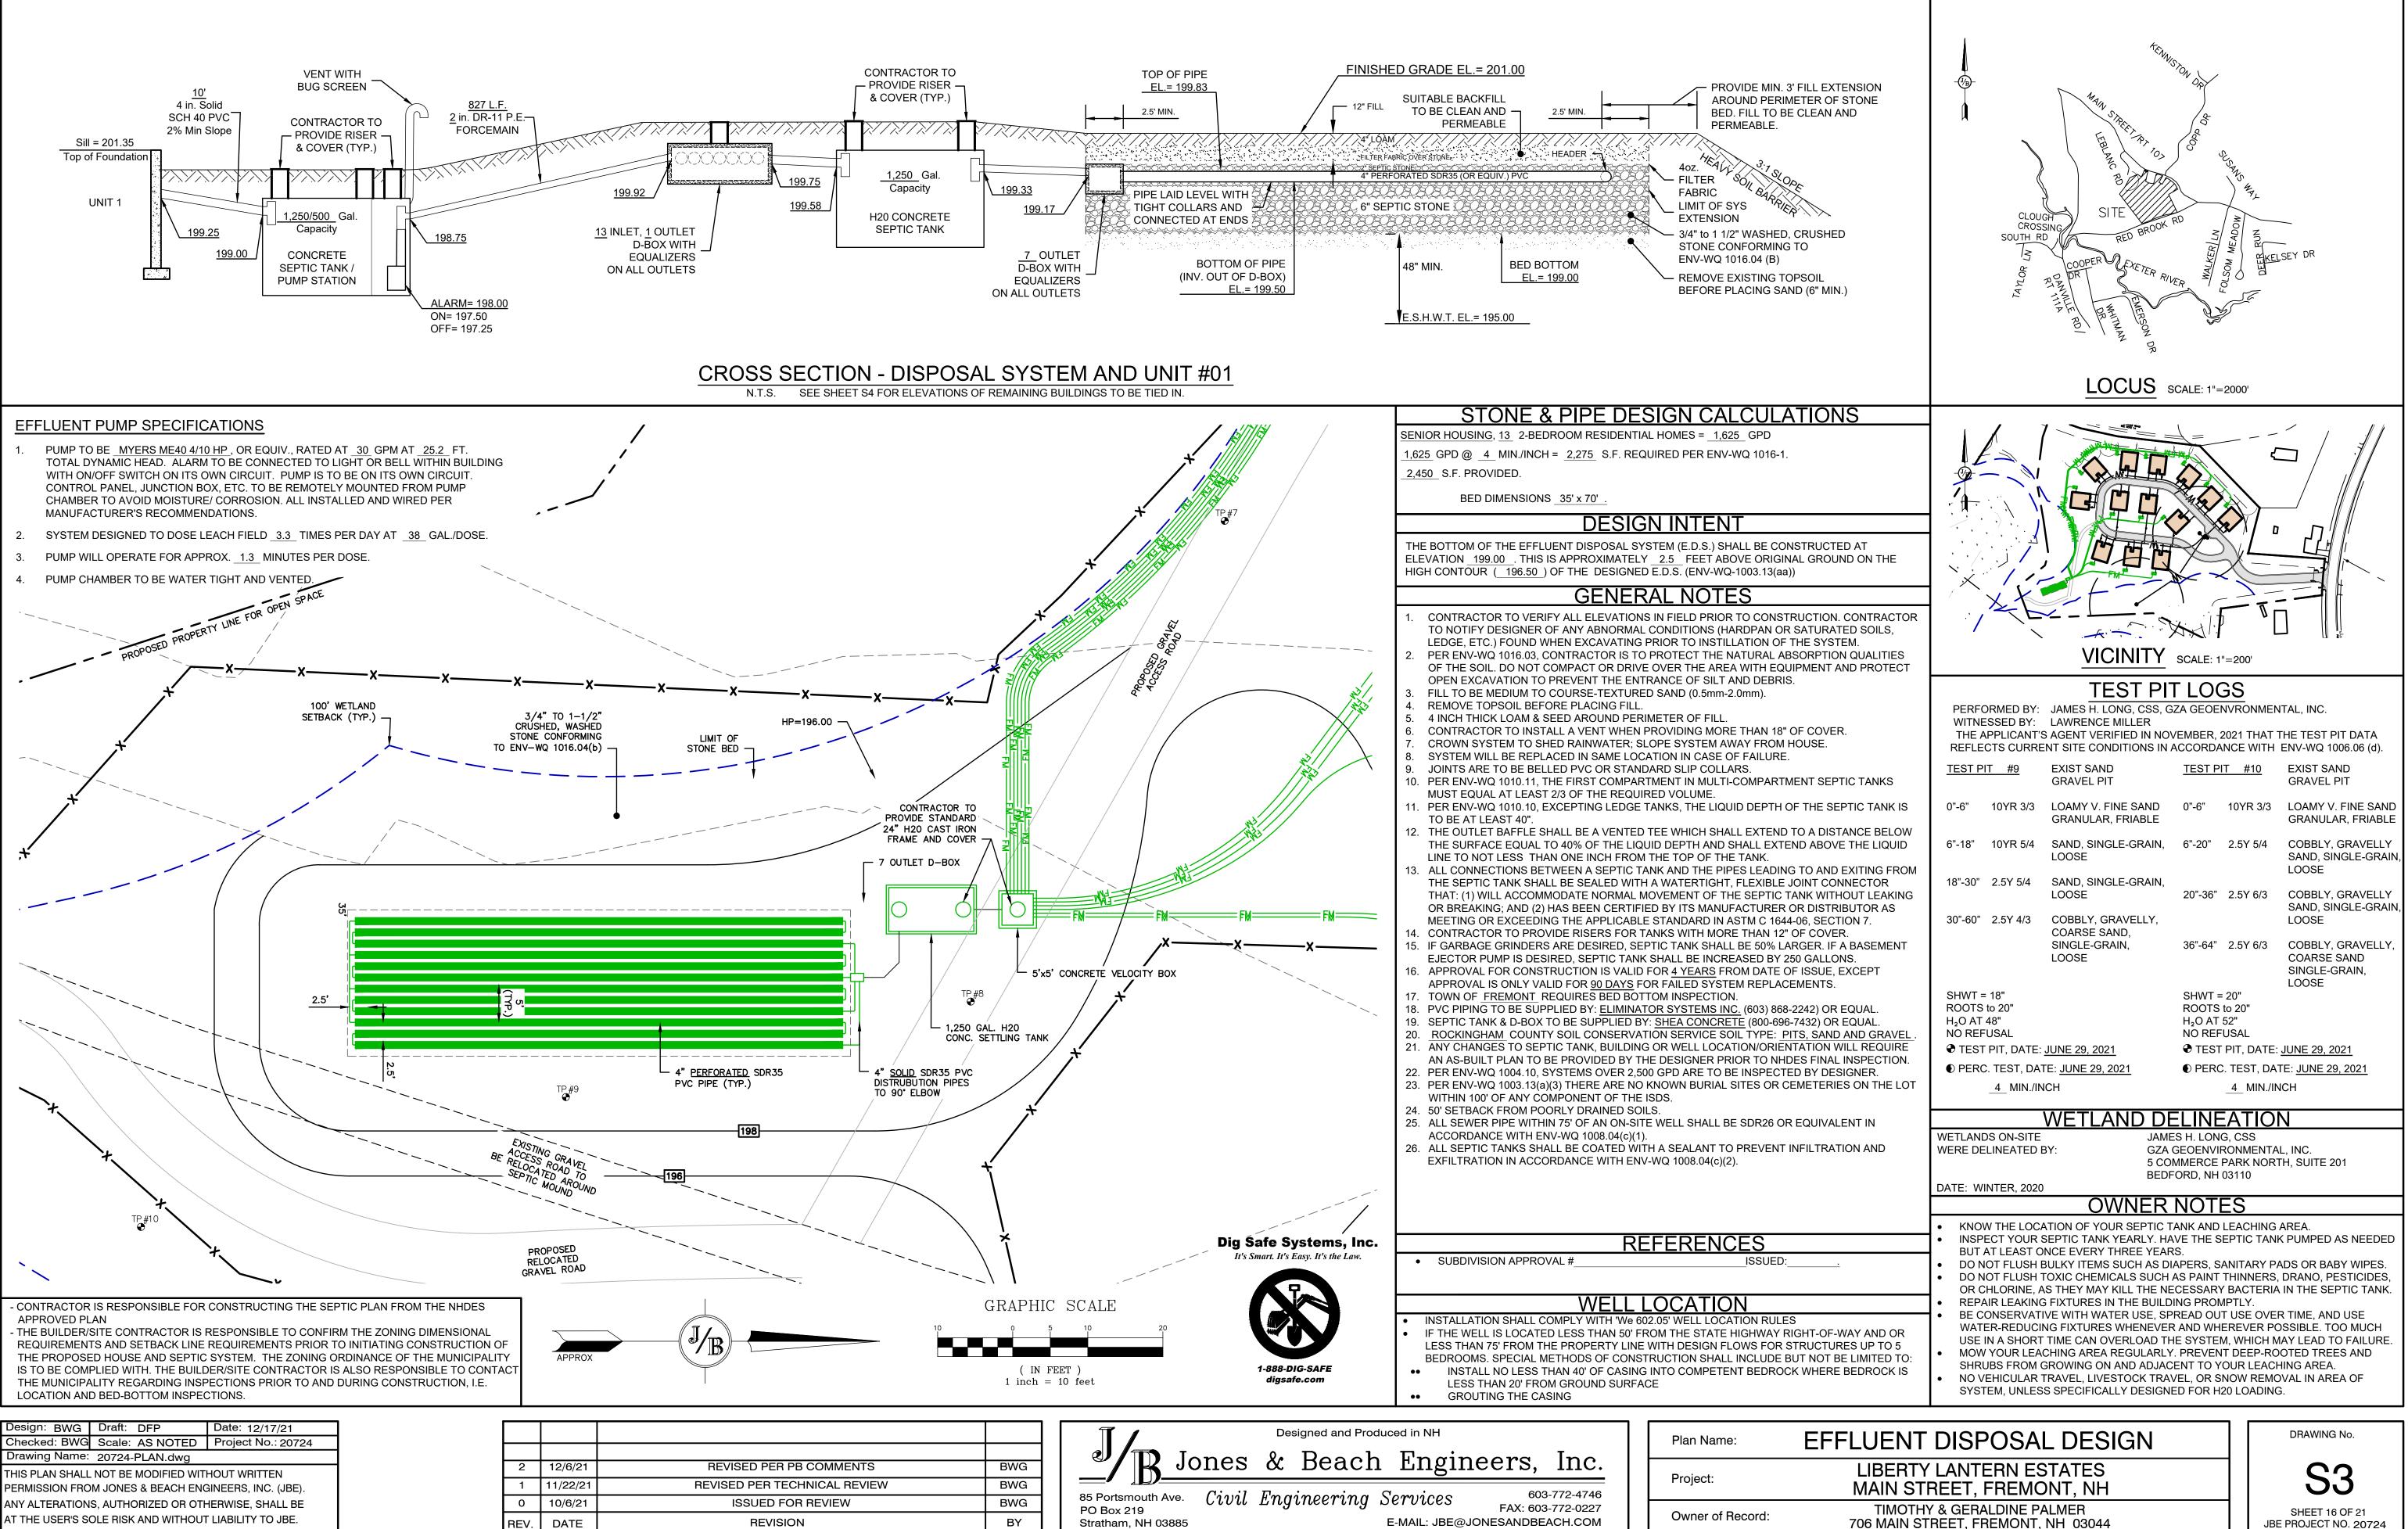
	T		LEGEND EXISTING 	MAJOR (MINOR C EDGE OF SINGLE DOUBLE STONEW/ TREELINE IRON PIF DRILL HO STONE/(TY LINES CONTOUR CONTOUR F PAVEMENT WHITE LINE YELLOW LINE ALL E PE/IRON ROD OLE GRANITE BOUND ATER WETLANDS
	1. 2. CO ST. 3. NH	NTROL DEVICES (MUTO ANDARDS. SIGN, HARDWARE, AN DOT STANDARD SPEC	T= 40 MPH THE MANUAL OF UNIFOR CD) STANDARDS AND NH ID INSTALLATION TO CON IFICATIONS, SECTION 615 ORM TO NHDOT PM-9 ST	HDOT NFORM TO 20 5 – TRAFFIC	SIGNS.
	D	GRAPHIC SCAL (IN FEET) 1 inch = 40 ft Horiz. 1 inch = 4 ft Vert.			
IUMBER R1–1	SIGN	SIZE OF SIGN WIDTH HEIGHT	DNTROL SCHEE SCRIPTION MOUNT TYPE TE ON RED CHANNEL	DULE MOUNT HEIGHT 7'-0"	REMARKS REFLECTORIZED SIGN
	LIBEF MAIN TIMO	VAY ACCES RTY LANTERN I STREET, FREM DTHY & GERALDINE N STREET, FREMON	ESTATES MONT, NH PALMER		DRAWING No. H11 SHEET 13 OF 21 JBE PROJECT NO. 20724


SHEET 13 OF 21 JBE PROJECT NO. **20724**



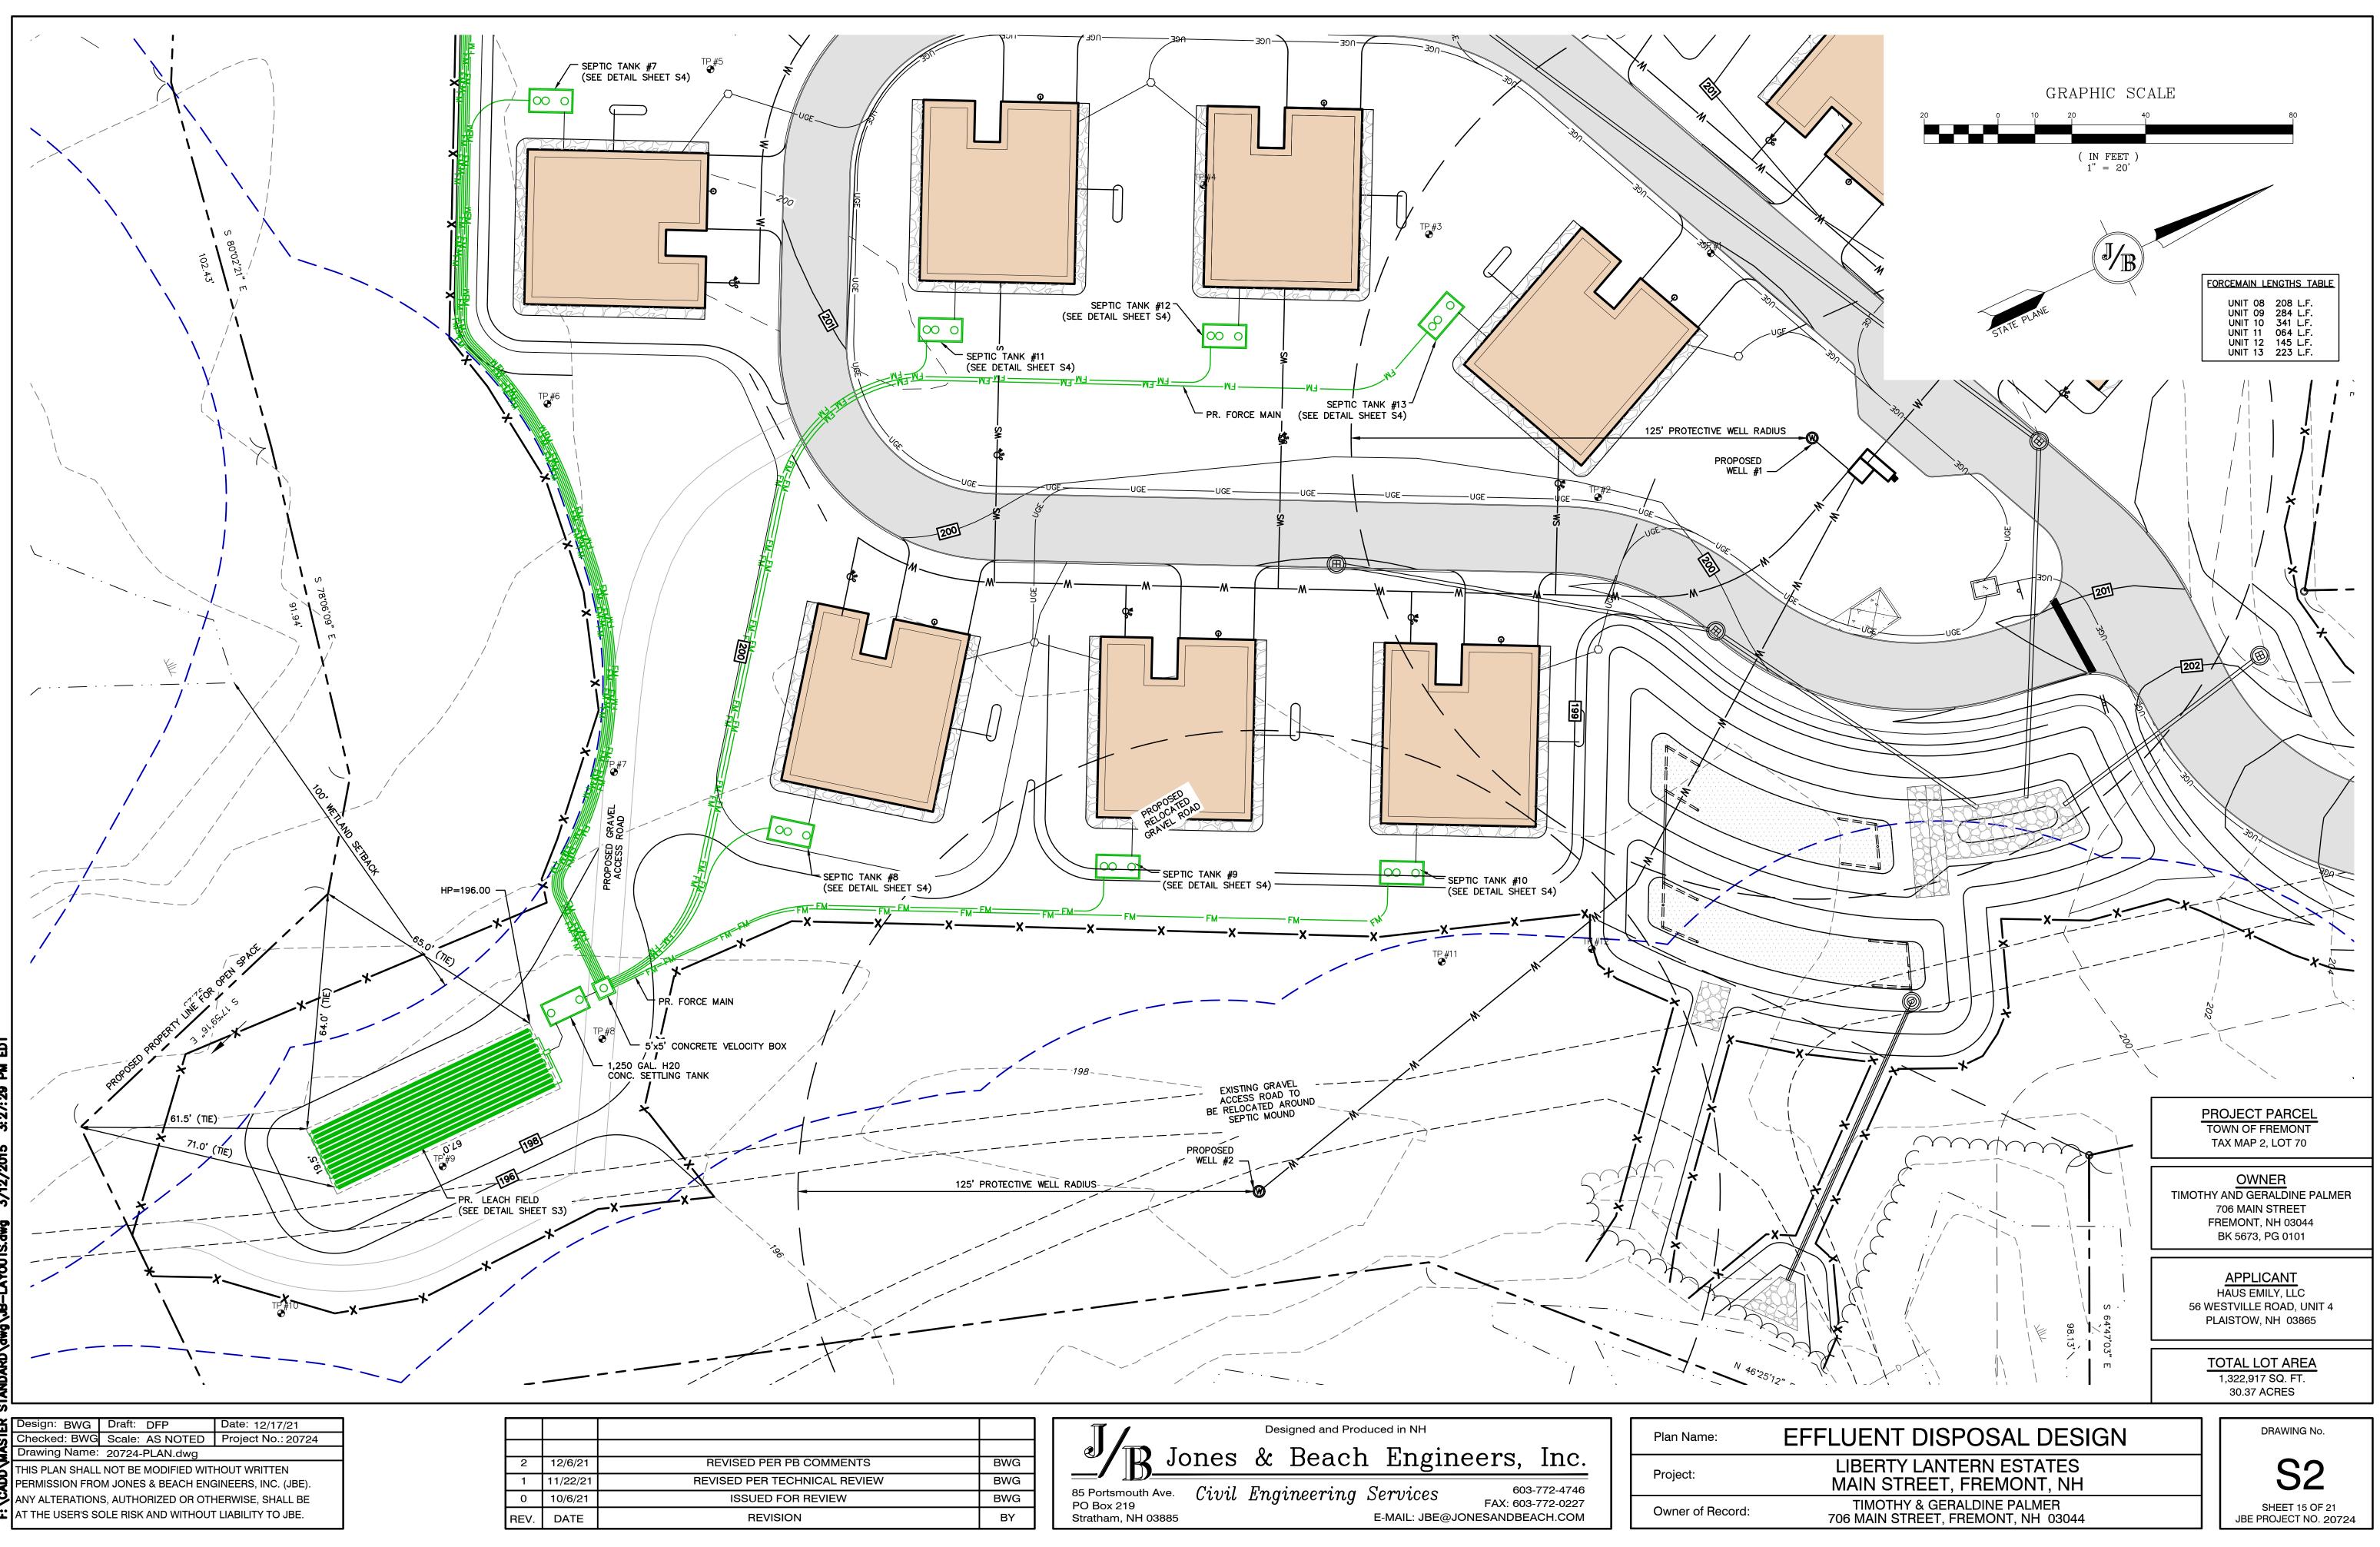



nni	Services	603-772-4746	-
ing	Dervices	FAX: 603-772-0227	0
	E-MAIL: JBE@JONESANDBEACH.COM		Ownei



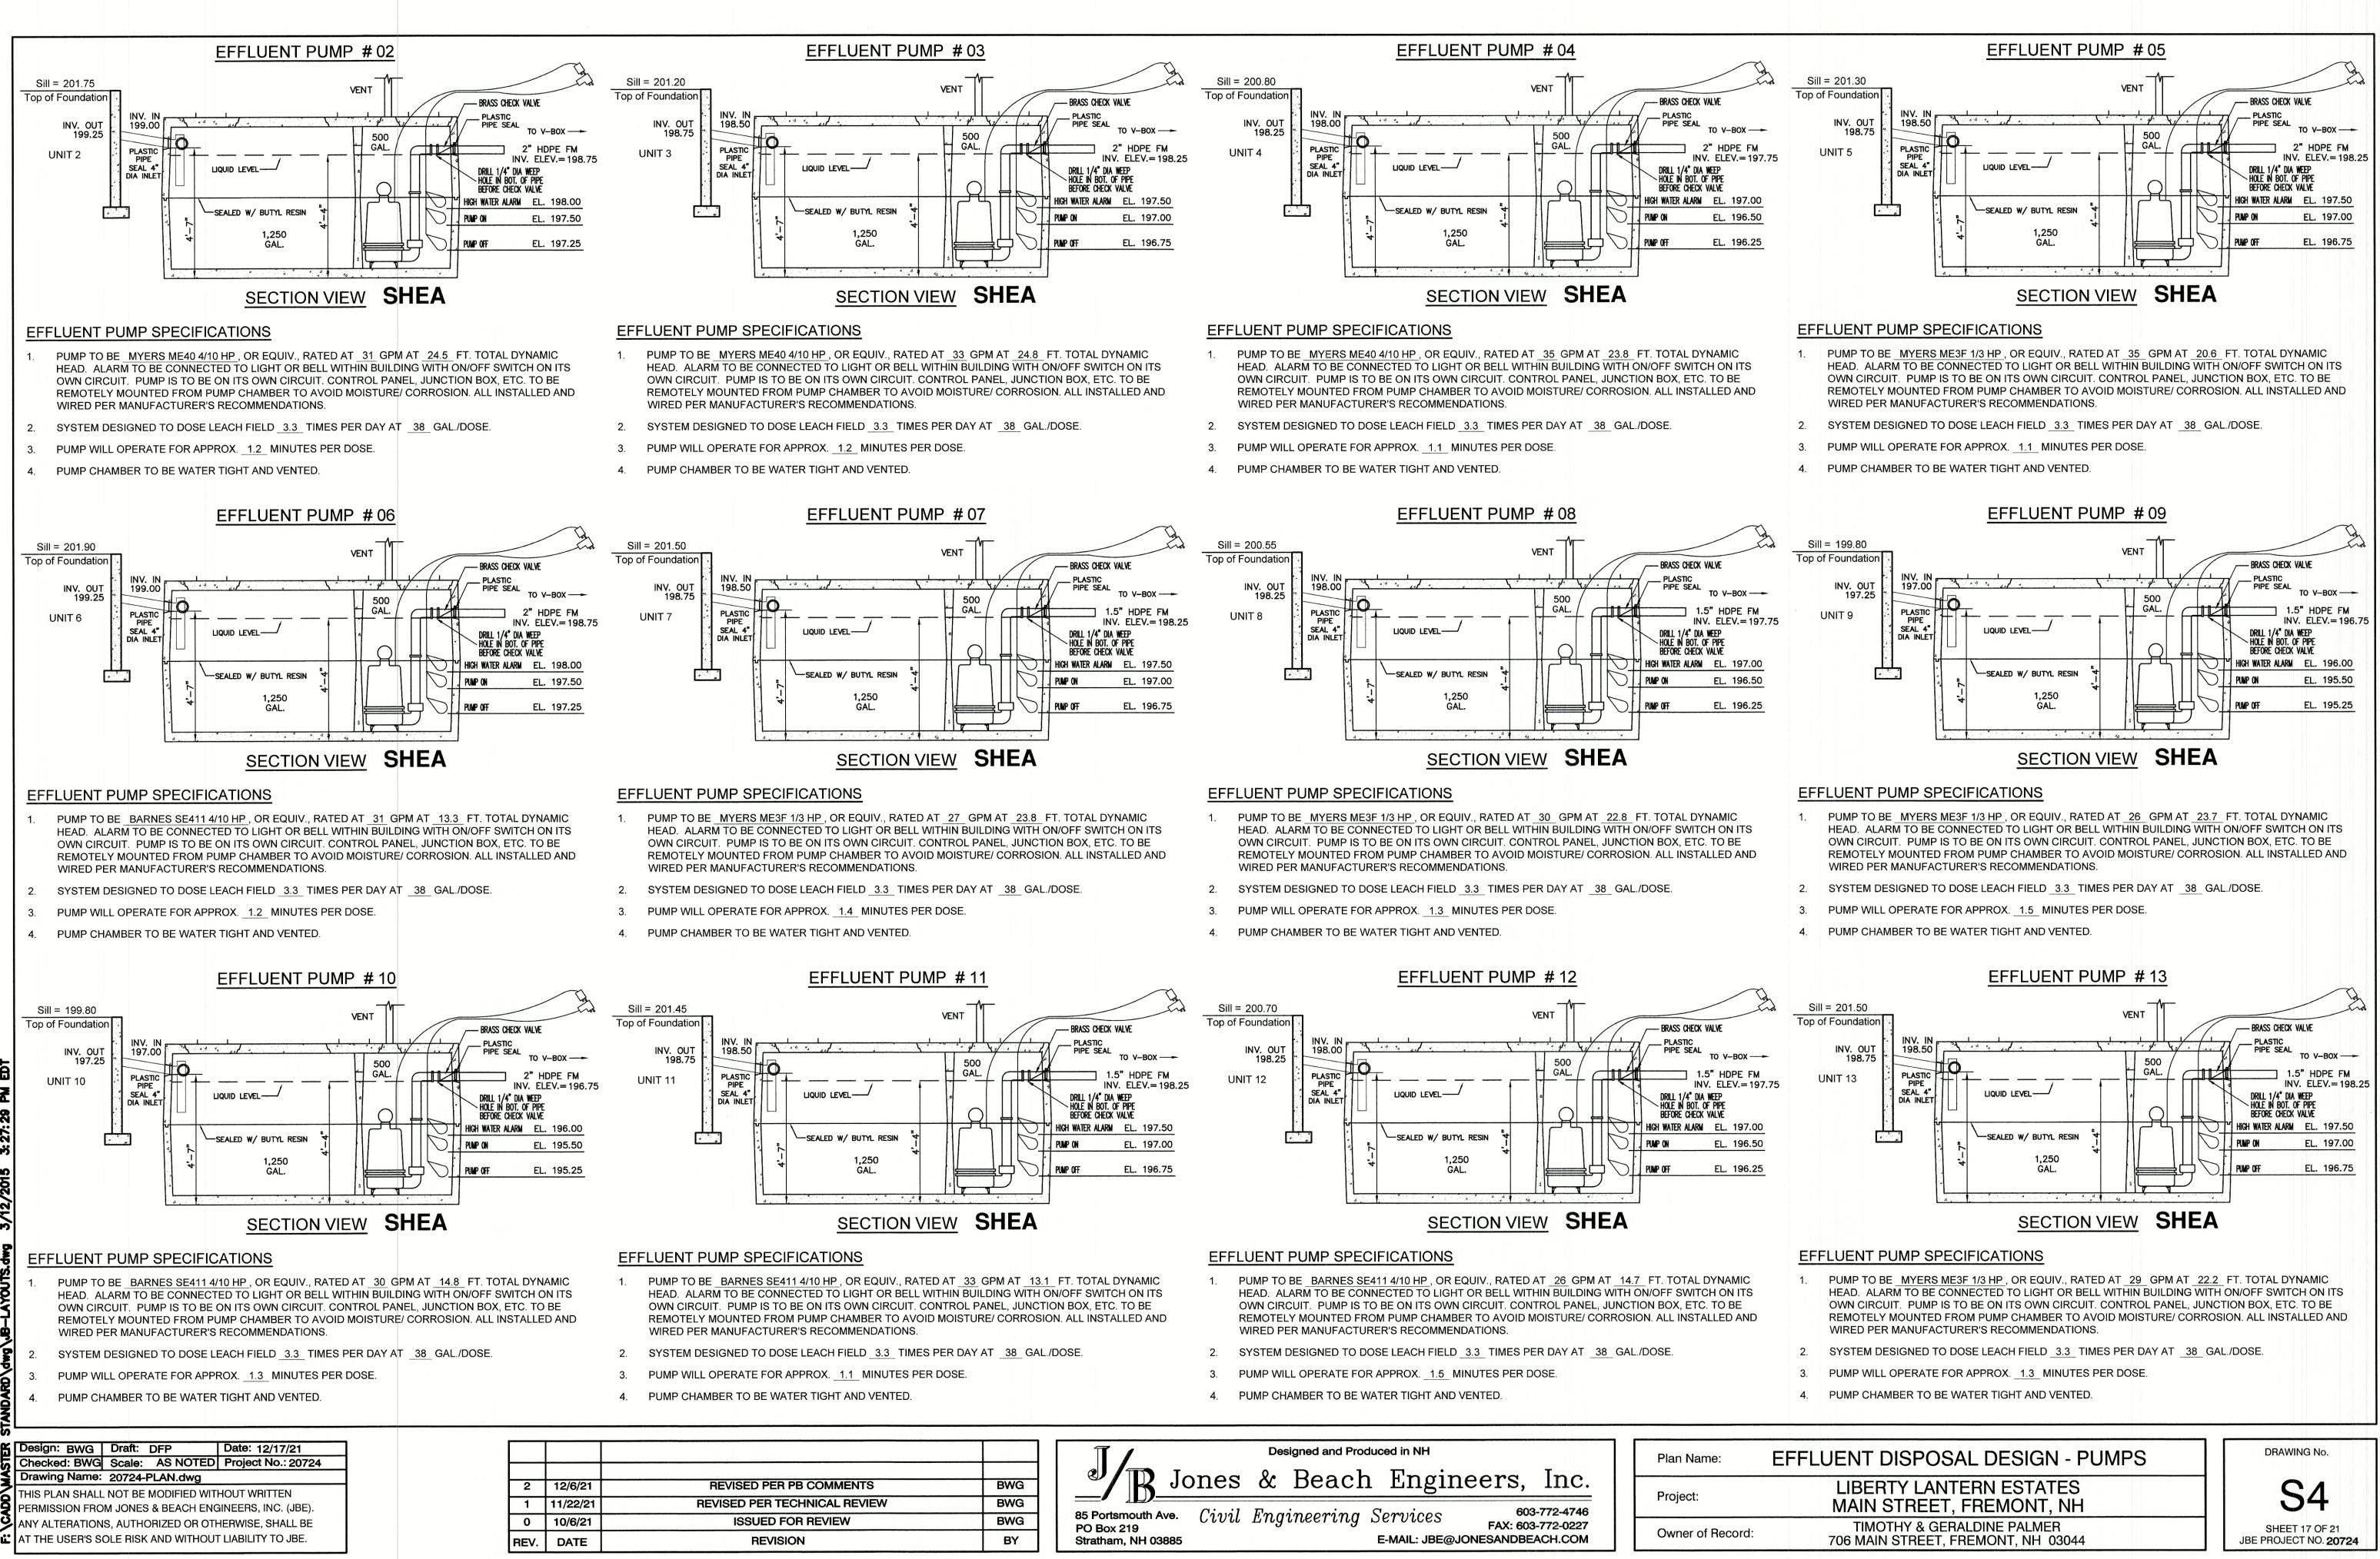


		Designed and Produced in NH	Plan Name:
	BWG	Jones & Beach Engineers, Inc.	
		Jonies & Deach Highleers, me:	Project:
N	BWG	85 Portsmouth Ave Cinuil Emaim coming Somulass 603-772-4746	Project.
	BWG	85 Portsmouth Ave. Civil Engineering Services 603-772-4746 PO Box 219 FAX: 603-772-0227	
	BY	Stratham, NH 03885 E-MAIL: JBE@JONESANDBEACH.COM	Owner of Record:

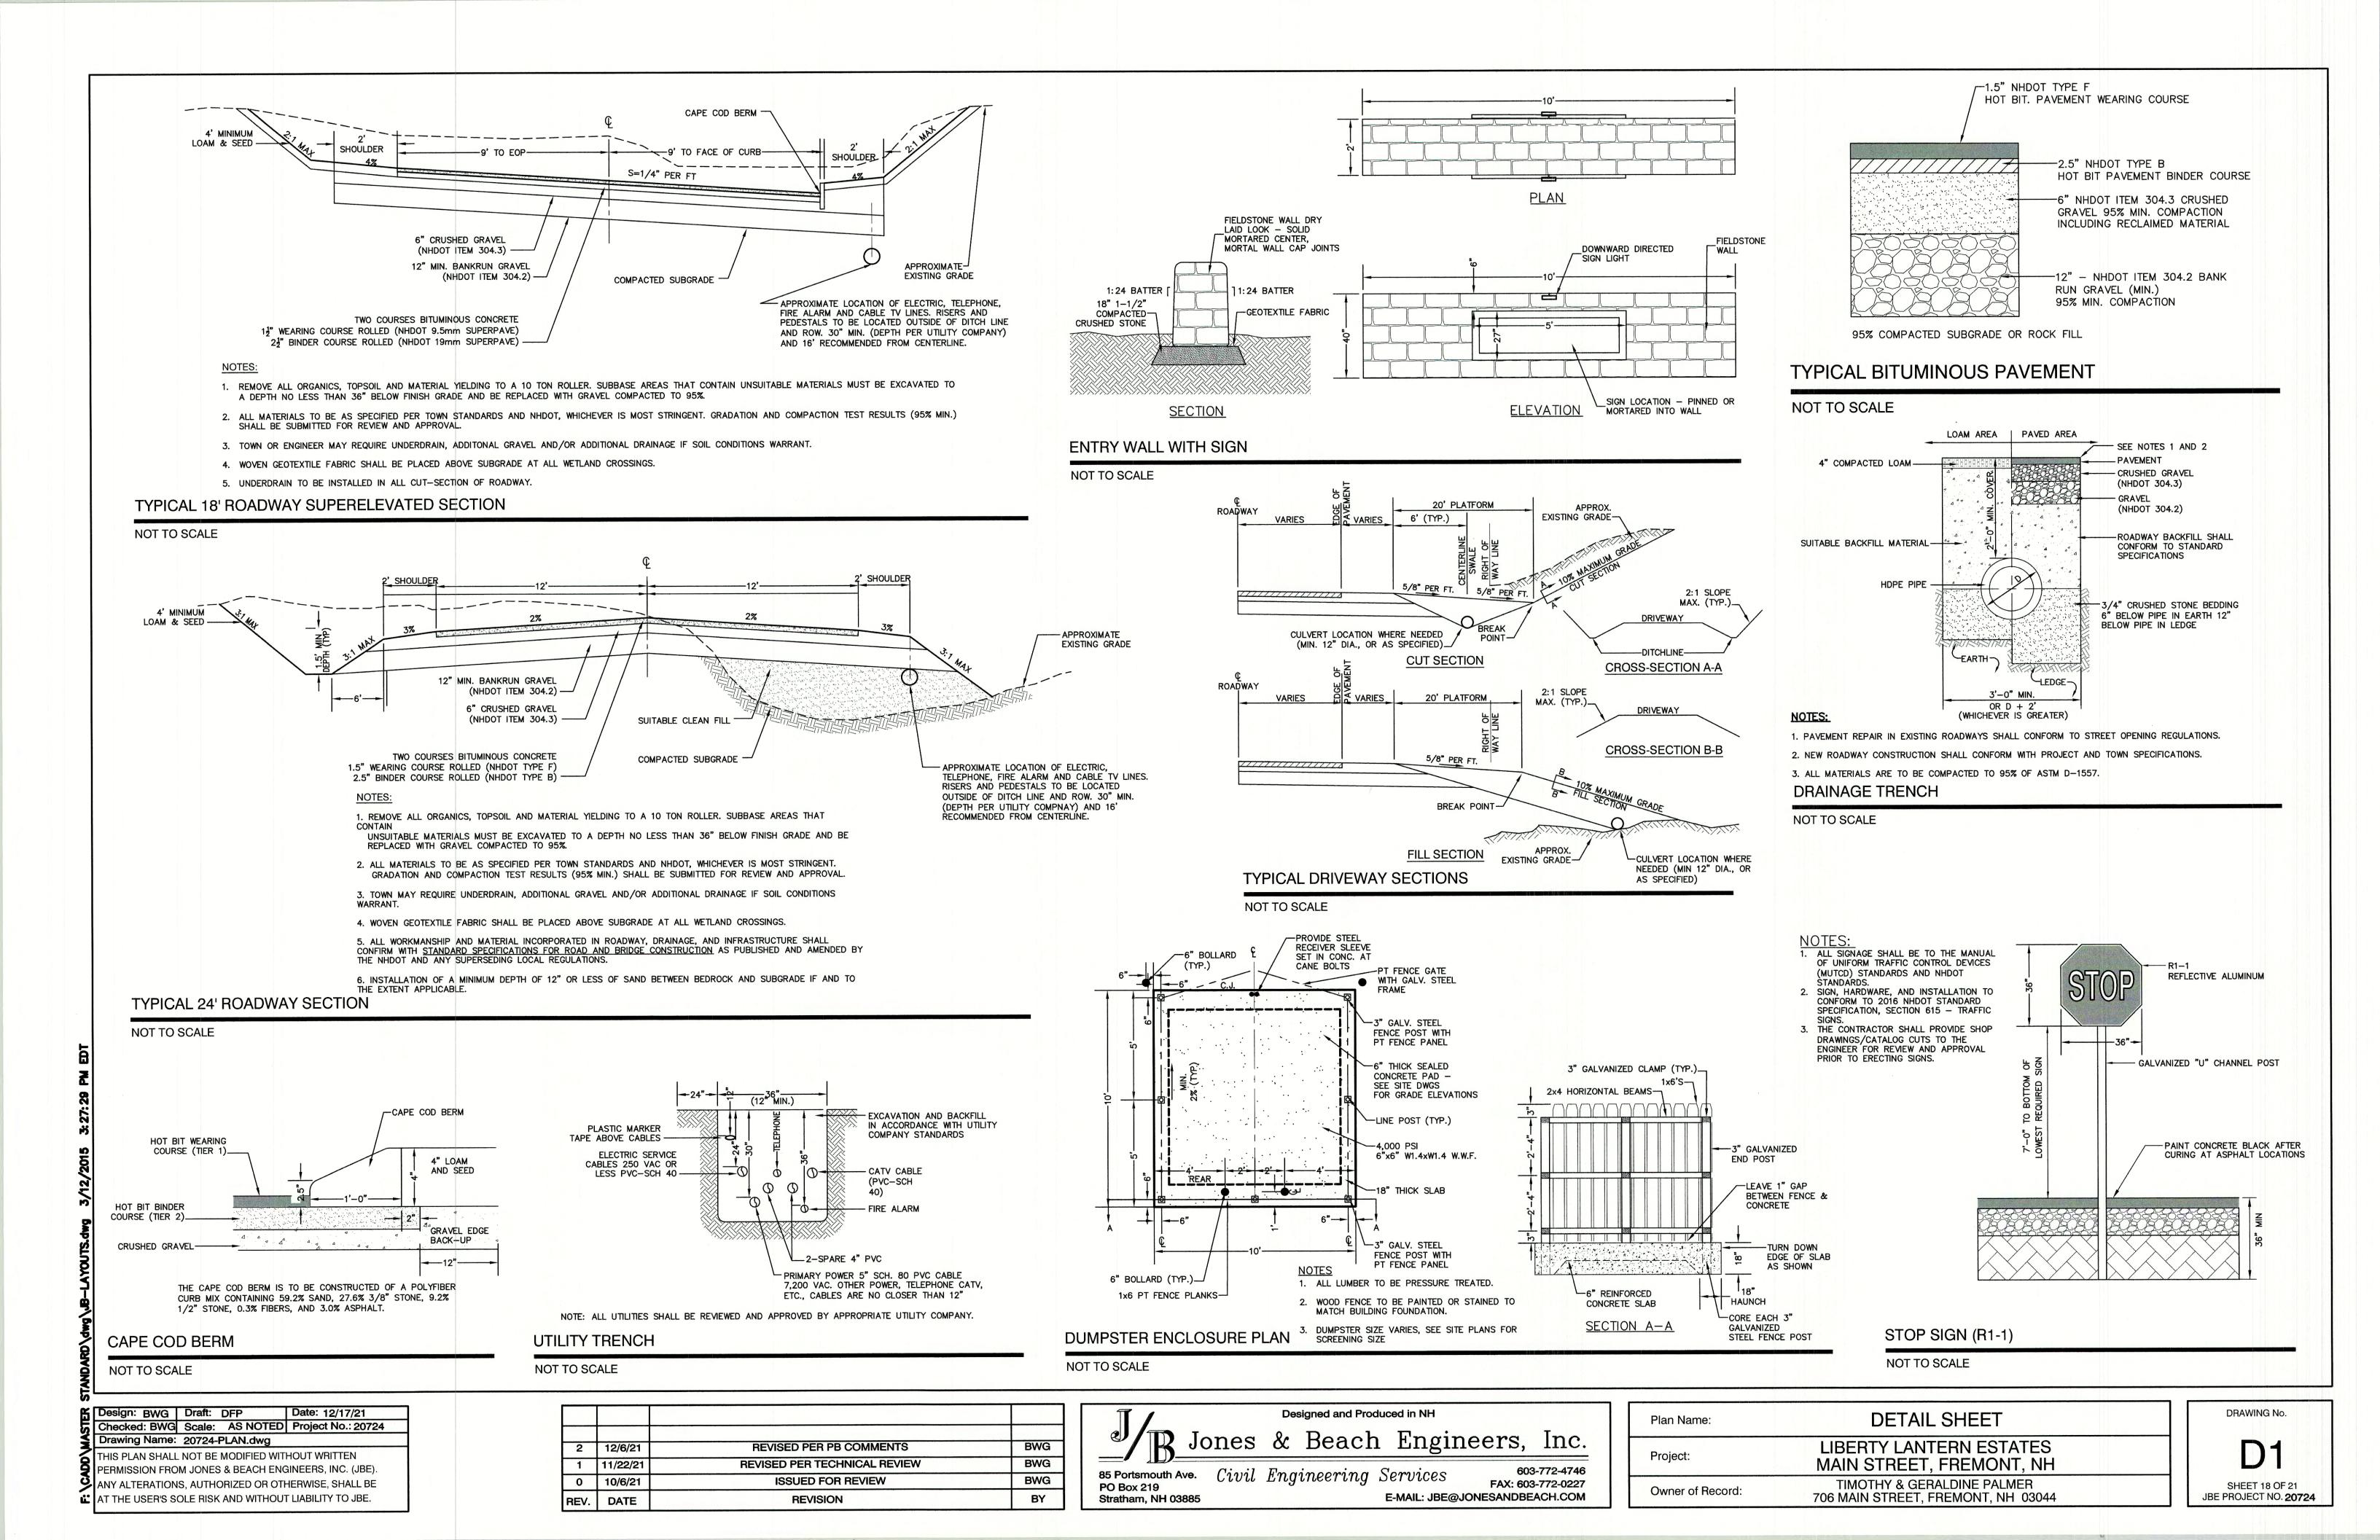

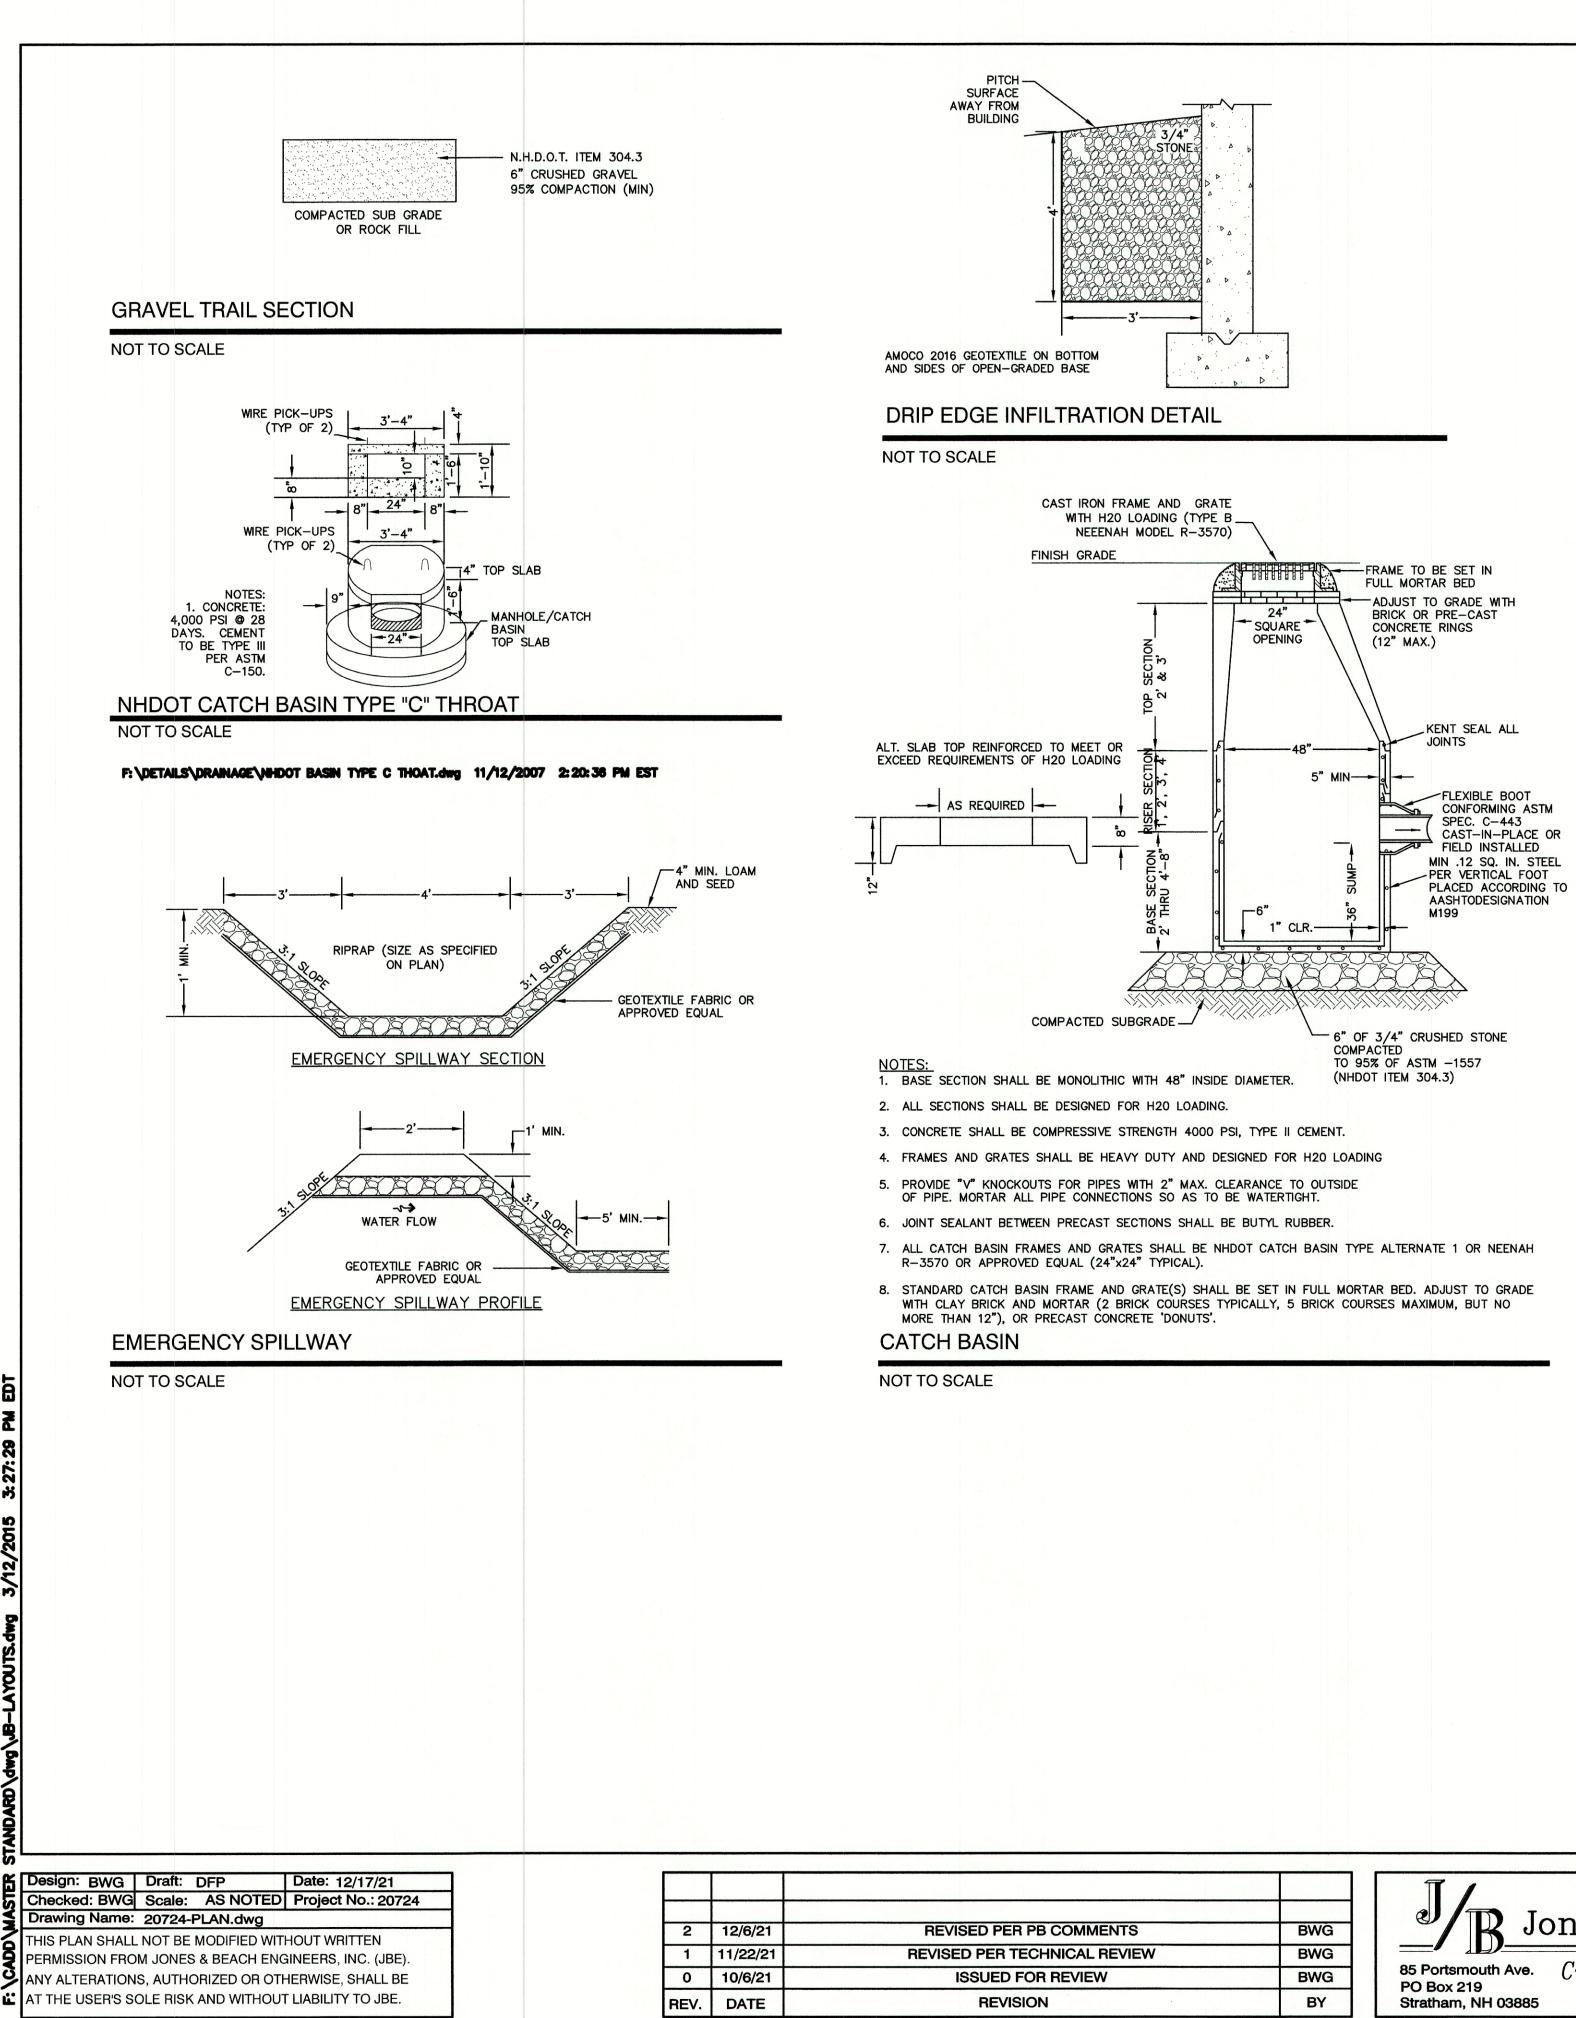

Calvin Wall

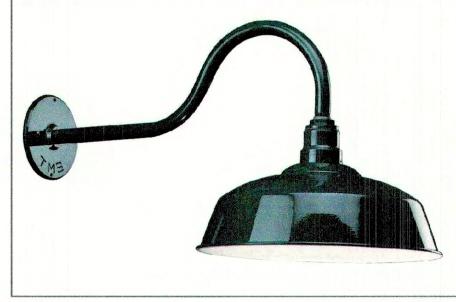

Features

- Provides excellent coverage and uniformity with cut-off
- Practical and aesthetic options for application and design flexibility
- Weatherproof construction to withstand the elements
- Quality components combined with the most current technology for high efficiency and reduced lighting costs

Applications

The Calvin wall-mount luminaire is ideal for illuminating areas where localized distribution is necessary, such as doorways and entrances, laneways, patios and could provide adequate night time security lighting. It lends itself to commercial, and industrial applications that could benefit from materials and maintenance cost reductions. Calvin could either augment the existing lighting, or illuminate a small to medium-sized area.

Calvin is also available as a pendant-style model.

WALL MOUNTED LUMINAIRE DETAIL

NOT TO SCALE

		Designed and Produced in NH	Plan Name:
	BWG	Jones & Beach Engineers, Inc	
W	BWG		Project:
	BWG	85 Portsmouth Ave. Civil Engineering Services PO Box 219 FAX: 603-772-4746 FAX: 603-772-0227	
	BY	Stratham, NH 03885 E-MAIL: JBE@JONESANDBEACH.COM	Owner of Record:

Construction High grade spun aluminum, brushed solid copper, or brushed 316L stainless steel

Operates with Cree™ LED (19W max.), compact fluorescent (42W max.), metal halide (100W max.), or incandescent (150W max.). Specify 3000K, 3500K or 4000K CCT for LED systems. A dimmable, screw-type, 17W LED lamp is also available (PAR 38, E26 base, 120V, 4000K CCT). Note: LED systems are available with 120-277V supply voltage only. LED modules do not require a socket, and are wired directly to the integral driver. Incandescent and metal halide systems, and those using the 17W LED PAR 38 lamp, use a medium base socket (E26). Diffuser

Globe: clear and prismatic, elongated, glass globes are available. Lens: the clear, flat lens provides slight diffusion, and protects any components located in the reflector. Note: G3 is used with 100IN, 32CF, and 15LED max. Only prismatic globes are compatible with LED systems.

Globes are not available with the 17W LED PAR 38 lamps. Option

light projectiles, wildlife, and serves as a vandal deterrent. Ballast/LED Driver

sound rating.

power Ballast and LED drivers are electronic, and available for integral and remote mounting, indoor or outdoor.


TMSLIGHTING **ESTABLISHED 1923**

reflector, with stainless steel mounting hardware, for indoor and outdoor applications.

Wire Guard: a steel, chrome-plated wire guard is available for lamp protection against

Ballasts are efficient with a high power factor greater than 90%, and quiet with an "A"


The LED source is controlled by an advanced electronic driver that delivers consistent

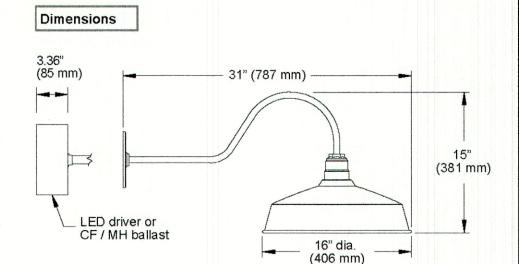

DETAIL SHEET LIBERTY LANTERN ESTATES MAIN STREET, FREMONT, NH TIMOTHY & GERALDINE PALMER 706 MAIN STREET, FREMONT, NH 03044

D2 SHEET 19 OF 21 JBE PROJECT NO. 20724


DRAWING No.

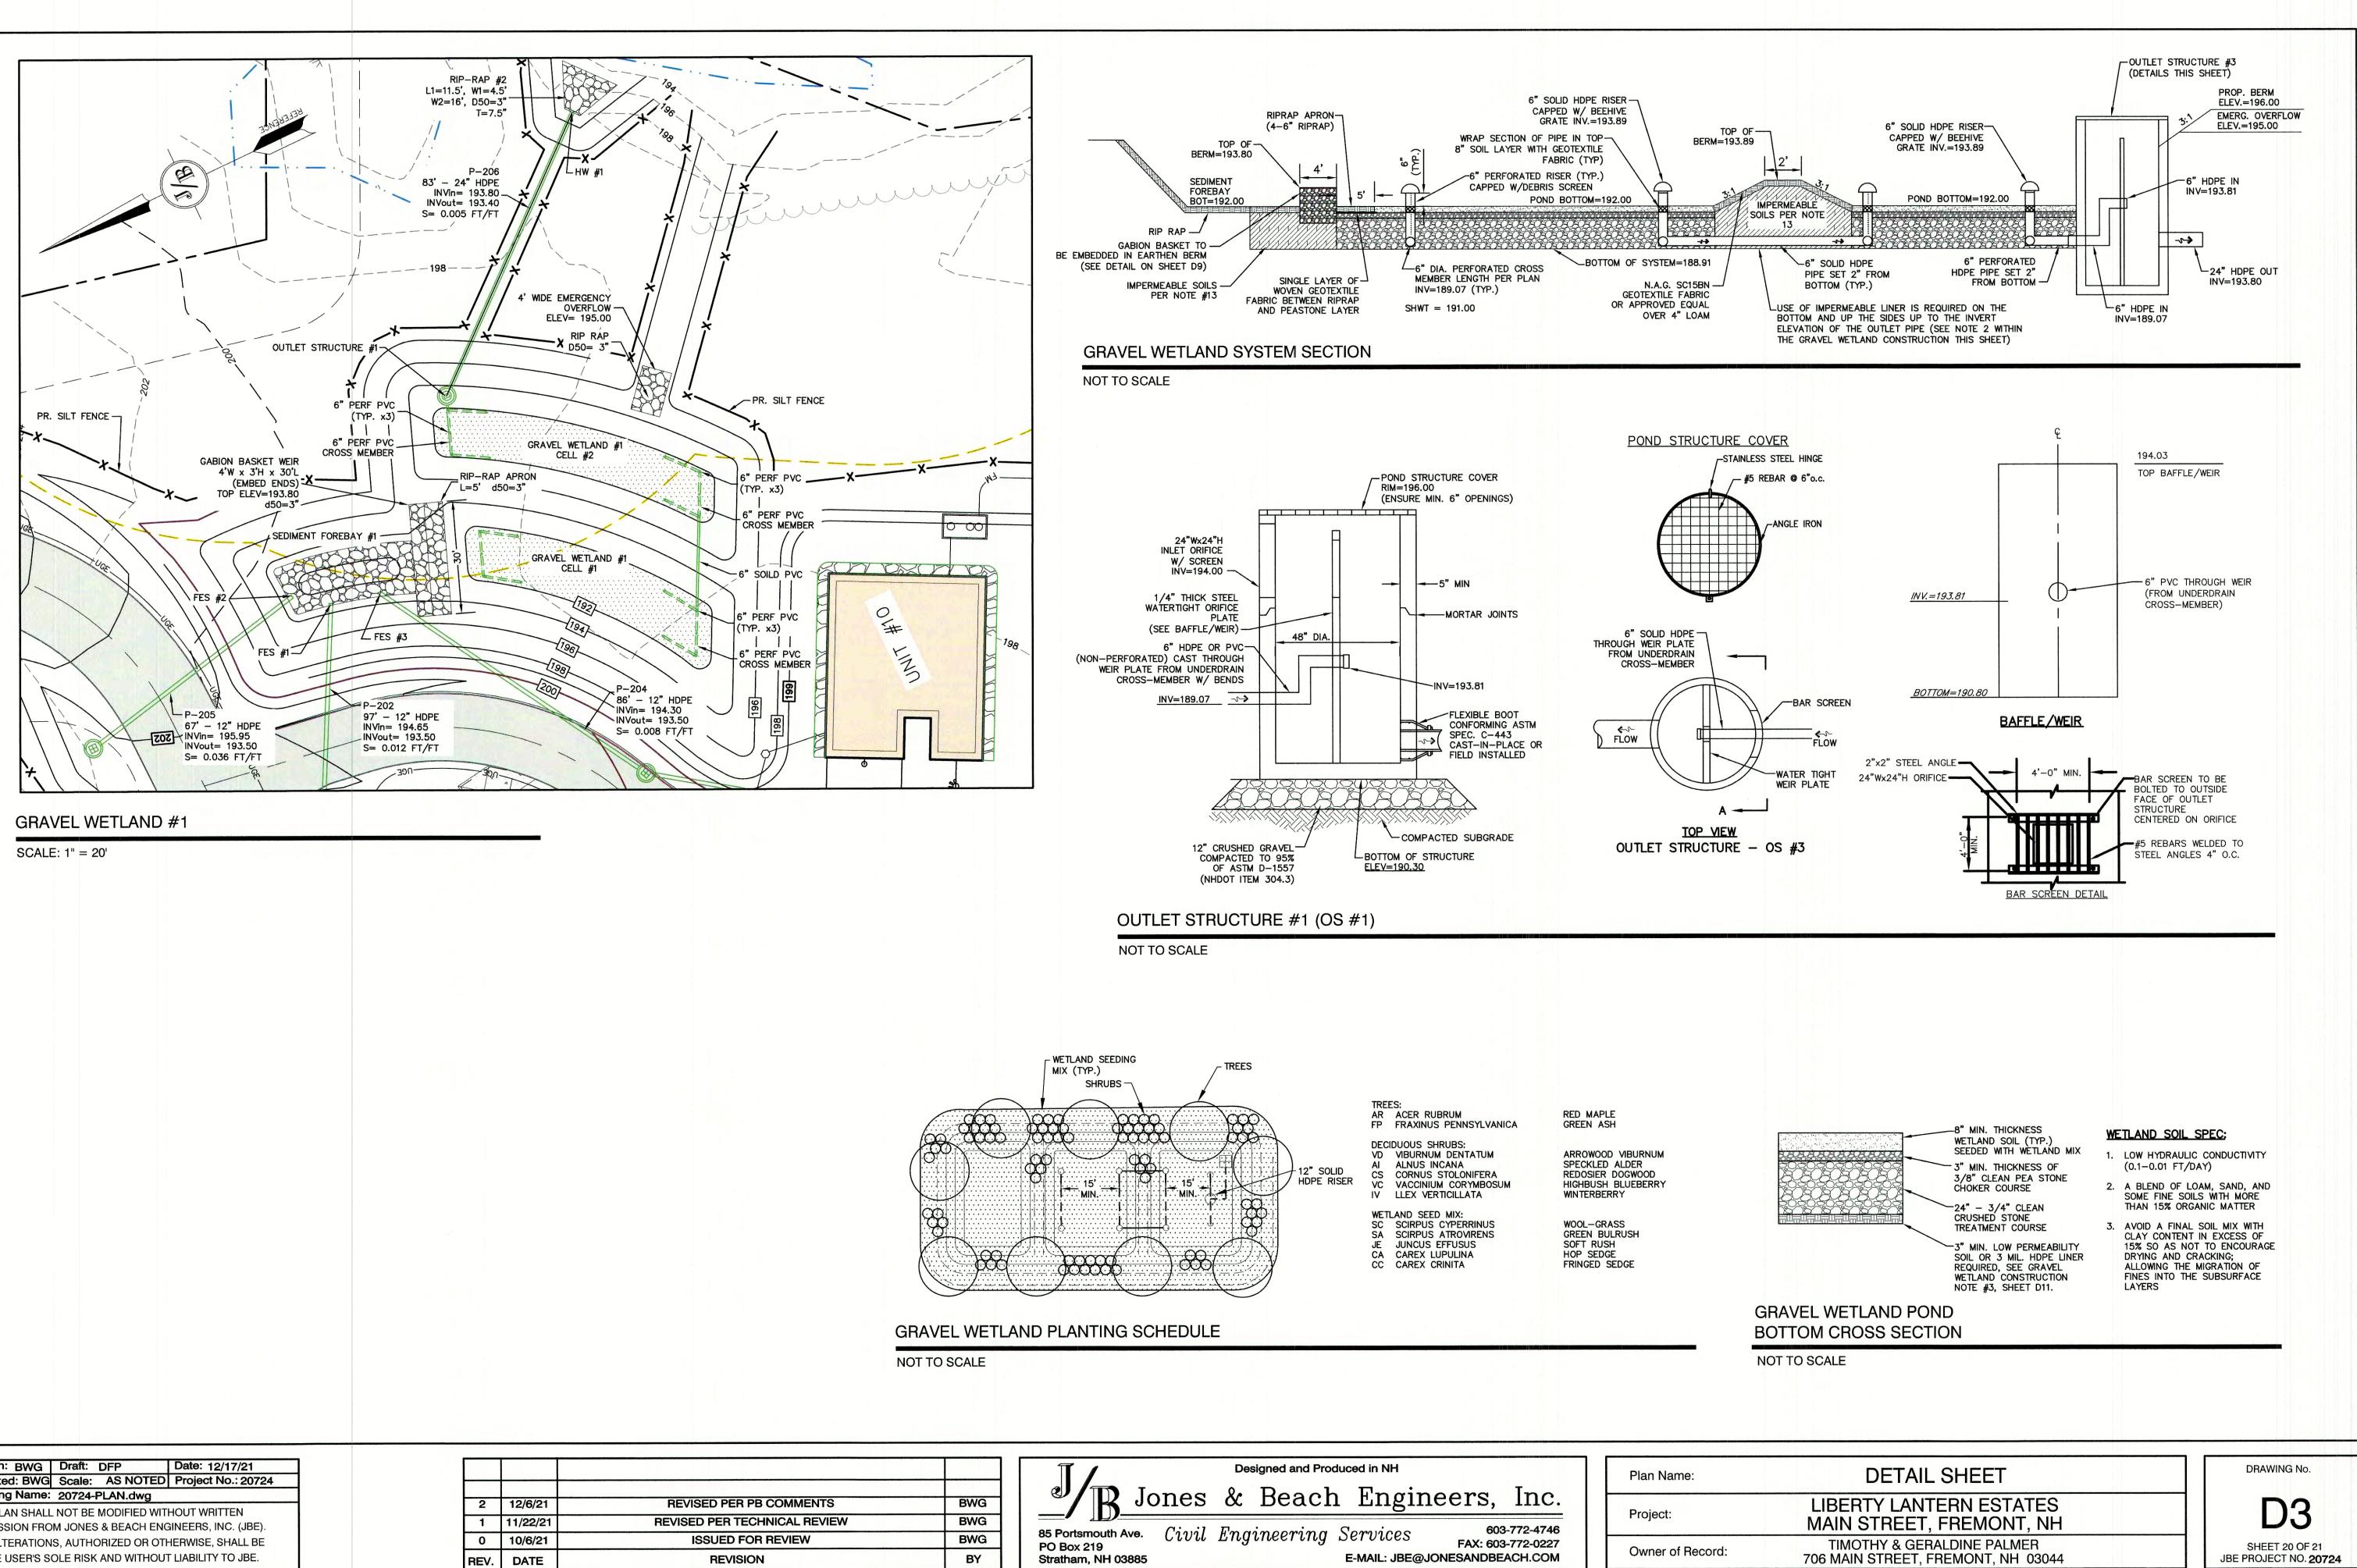

Design: BWG Draft: DFP Date: 12/17/21 Checked: BWG Scale: AS NOTED Project No.: 20724				Designed and Produced in NH	Plan Name:
Drawing Name: 20724-PLAN.dwg THIS PLAN SHALL NOT BE MODIFIED WITHOUT WRITTEN PERMISSION FROM JONES & BEACH ENGINEERS, INC. (JBE).	2 12/6/21 1 11/22/21	REVISED PER PB COMMENTS REVISED PER TECHNICAL REVIEW	BWG BWG	B Jones & Beach Engineers, Inc.	Project:
ANY ALTERATIONS, AUTHORIZED OR OTHERWISE, SHALL BE AT THE USER'S SOLE RISK AND WITHOUT LIABILITY TO JBE.	0 10/6/21 REV. DATE	ISSUED FOR REVIEW REVISION	BWG BY	85 Portsmouth Ave. Civil Engineering Services PO Box 219 Stratham, NH 03885 E-MAIL: JBE@JONESANDBEACH.COM	Owner of Record:



- . THE SMALLEST PRACTICAL AREA OF LAND SHALL BE EXPOSED AT ANY ONE TIME. AT NO TIME SHALL AN AREA IN EXCESS OF 5 ACRES BE EXPOSED AT ANY ONE TIME BEFORE DISTURBED AREAS ARE STABILIZED.
- EROSION, SEDIMENT AND DETENTION MEASURES SHALL BE INSTALLED AS SHOWN ON THE PLANS AND AT LOCATIONS AS REQUIRED, DIRECTED BY THE ENGINEER.
- ALL DISTURBED AREAS (INCLUDING POND AREAS BELOW THE PROPOSED WATERLINE) SHALL BE RETURNED TO PROPOSED GRADES AND ELEVATIONS. DISTURBED AREAS SHALL BE LOAMED WITH A MINIMUM OF 6" OF SCREENED ORGANIC LOAM AND SEEDED WITH SEED MIXTURE 'C' AT A RATE NOT LESS THAN 1.10 POUNDS OF SEED PER 1,000 S.F. OF AREA (48 LBS. / ACRE).
- SILT FENCES AND OTHER BARRIERS SHALL BE INSPECTED EVERY SEVEN CALENDAR DAYS AND WITHIN 24 HOURS OF A RAINFALL OF 0.5" OR GREATER. ALL DAMAGED AREAS SHALL BE REPAIRED, AND SEDIMENT DEPOSITS SHALL PERIODICALLY BE REMOVED AND DISPOSED OF.
- 5. AFTER ALL DISTURBED AREAS HAVE BEEN STABILIZED, THE TEMPORARY EROSION CONTROL MEASURES SHALL BE REMOVED AND THE AREA DISTURBED BY THE REMOVAL SMOOTHED AND RE-VEGETATED.
- AREAS MUST BE SEEDED AND MULCHED OR OTHERWISE PERMANENTLY STABILIZED WITHIN 3 DAYS OF FINAL GRADING, OR TEMPORARILY STABILIZED WITHIN 14 DAYS OF THE INITIAL DISTURBANCE OF SOIL. ALL AREAS SHALL BE STABILIZED WITHIN 45 DAYS OF INITIAL DISTURBANCE.
- 7. ALL PROPOSED VEGETATED AREAS THAT DO NOT EXHIBIT A MINIMUM OF 85 PERCENT VEGETATIVE GROWTH BY OCTOBER 15, OR WHICH ARE DISTURBED AFTER OCTOBER 15, SHALL BE STABILIZED BY SEEDING AND INSTALLING NORTH AMERICAN GREEN S75 EROSION CONTROL BLANKETS (OR AN EQUIVALENT APPROVED IN WRITING BY THE ENGINEER) ON SLOPES GREATER THAN 3:1, AND SEEDING AND PLACING 3 TO 4 TONS OF MULCH PER ACRE, SECURED WITH ANCHORED NETTING, ELSEWHERE. THE INSTALLATION OF EROSION CONTROL BLANKETS OR MULCH AND NETTING SHALL NOT OCCUR OVER ACCUMULATED SNOW OR ON FROZEN GROUND AND SHALL BE COMPLETED IN ADVANCE OF THAW OR SPRING MELT EVENTS.
- ALL DITCHES OR SWALES WHICH DO NOT EXHIBIT A MINIMUM OF 85 PERCENT VEGETATIVE GROWTH BY OCTOBER 15. OR WHICH ARE DISTURBED AFTER OCTOBER 15, SHALL BE STABILIZED TEMPORARILY WITH STONE OR EROSION CONTROL BLANKETS APPROPRIATE FOR THE DESIGN FLOW CONDITIONS.
- 9. AFTER OCTOBER 15th, INCOMPLETE ROAD OR PARKING SURFACES, WHERE WORK HAS STOPPED FOR THE WINTER SEASON, SHALL BE PROTECTED WITH A MINIMUM OF 3" OF CRUSHED GRAVEL PER NHDOT ITEM 304.3.
- 10. AN AREA SHALL BE CONSIDERED STABLE IF ONE OF THE FOLLOWING HAS OCCURRED:
 - a. BASE COURSE GRAVELS HAVE BEEN INSTALLED IN AREAS TO BE PAVED;
 - b. A MINIMUM OF 85% VEGETATED GROWTH HAS BEEN ESTABLISHED;
 - c. A MINIMUM OF 3" OF NON-EROSIVE MATERIAL SUCH STONE OR RIPRAP HAS BEEN INSTALLED; OR
 - d. EROSION CONTROL BLANKETS HAVE BEEN PROPERLY INSTALLED.
- 11. FUGITIVE DUST CONTROL IS REQUIRED TO BE CONTROLLED IN ACCORDANCE WITH ENV-A 1000, AND THE PROJECT IS TO MEET THE REQUIREMENTS AND INTENT OF RSA 430:53 AND AGR 3800 RELATIVE TO INVASIVE SPECIES.
- 12. PRIOR TO BEGINNING CONSTRUCTION, THE CONTRACTOR'S NAME, ADDRESS, AND PHONE NUMBER SHALL BE SUBMITTED TO DES VIA EMAIL (SEE BELOW).
- 13. PRIOR TO CONSTRUCTION, A PHASING PLAN THAT DELINEATES EACH PHASE OF THE PROJECT SHALL BE SUBMITTED. ALL TEMPORARY SEDIMENT BASINS THAT WILL BE NEEDED FOR DEWATERING WORK AREAS SHALL BE LOCATED AND IDENTIFIED ON THIS
- IN ORDER TO ENSURE THE STABILITY OF THE SITE AND EFFECTIVE IMPLEMENTATION OF THE SEDIMENT AND EROSION CONTROL MEASURES SPECIFIED IN THE PLANS FOR THE DURATION OF CONSTRUCTION, THE CONTRACTOR SHALL BE IN STRICT COMPLIANCE WITH THE FOLLOWING INSPECTION AND MAINTENANCE REQUIREMENTS IN ADDITION TO THOSE CALLED FOR IN THE SWPPP:
 - a. A CERTIFIED PROFESSIONAL IN EROSION AND SEDIMENT CONTROL OR A PROFESSIONAL ENGINEER LICENSED IN THE STATE OF NEW HAMPSHIRE ("MONITOR") SHALL BE EMPLOYED TO INSPECT THE SITE FROM THE START OF ALTERATION OF TERRAIN ACTIVITIES UNTIL THE SITE IS STABLE
 - b. DURING THIS PERIOD, THE MONITOR SHALL INSPECT THE SUBJECT SITE AT LEAST ONCE A WEEK, AND IF POSSIBLE, DURING ANY 1/2 INCH OR GREATER RAIN EVENT (I.E. 1/2 INCH OF PRECIPITATION OR MORE WITHIN A 24 HOUR PERIOD). IF UNABLE TO BE PRESENT DURING SUCH A STORM, THE MONITOR SHALL INSPECT THE SITE WITHIN 24 HOURS OF THIS EVENT
 - c. THE MONITOR SHALL PROVIDE TECHNICAL ASSISTANCE AND RECOMMENDATIONS TO THE CONTRACTOR ON THE APPROPRIATE BEST MANAGEMENT PRACTICES FOR EROSION AND SEDIMENT CONTROLS REQUIRED TO MEET THE REQUIREMENTS OF RSA 485 A:17 AND ALL APPLICABLE DES PERMIT CONDITIONS.

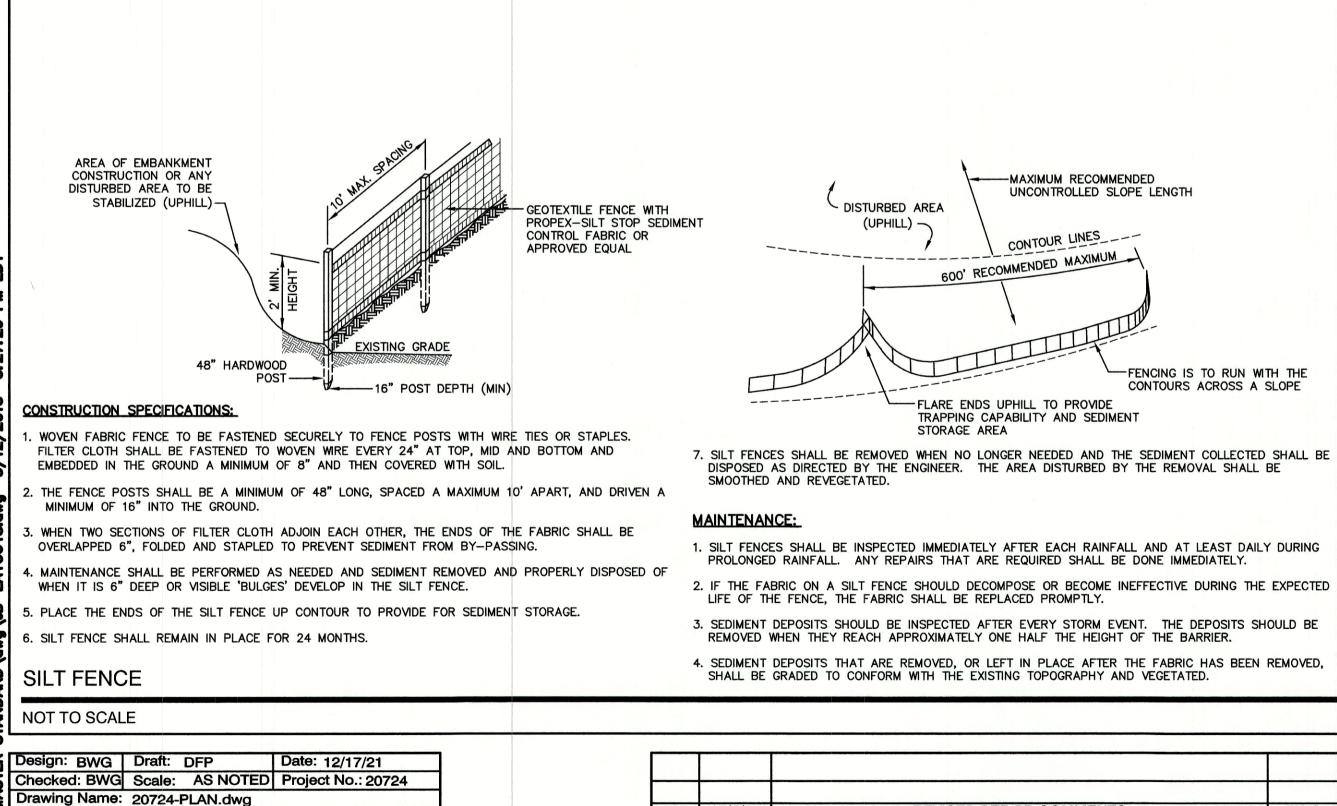

THIS PLAN SHALL NOT BE MODIFIED WITHOUT WRITTEN

PERMISSION FROM JONES & BEACH ENGINEERS, INC. (JBE).

ANY ALTERATIONS, AUTHORIZED OR OTHERWISE, SHALL BE AT THE USER'S SOLE RISK AND WITHOUT LIABILITY TO JBE.

REVISED PER PB COMM 2 | 12/6/21 1 11/22/21 **REVISED PER TECHNICAL** 10/6/21 **ISSUED FOR REVIEW** 0 REVISION DATE REV.

SEEDING SPECIFICATIONS

- 1. GRADING AND SHAPING A. SLOPES SHALL NOT BE STEEPER THAN 2:1 WITHOUT APPROPRIATE EROSION CONTROL MEASURES AS SPECIFIED ON THE PLANS (3:1 SLOPES OR FLATTER ARE PREFERRED).
- B. WHERE MOWING WILL BE DONE, 3:1 SLOPES OR FLATTER ARE RECOMMENDED.
- 2. SEEDBED PREPARATION
- A. SURFACE AND SEEPAGE WATER SHOULD BE DRAINED OR DIVERTED FROM THE SITE TO PREVENT DROWNING OR WINTER KILLING OF THE PLANTS.
- B. STONES LARGER THAN 4 INCHES AND TRASH SHOULD BE REMOVED BECAUSE THEY INTERFERE WITH SEEDING AND FUTURE MAINTENANCE OF THE AREA. WHERE FEASIBLE, THE SOIL SHOULD BE TILLED TO A DEPTH OF ABOUT 4 INCHES TO PREPARE A SEEDBED AND FERTILIZER AND LIME MIXED INTO THE SOIL. THE SEEDBED SHOULD BE LEFT IN A REASONABLY FIRM AND SMOOTH CONDITION. THE LAST TILLAGE OPERATION SHOULD BE PERFORMED ACROSS THE SLOPE WHEREVER PRACTICAL.
- 3. ESTABLISHING A STAND
- A. LIME AND FERTILIZER SHOULD BE APPLIED PRIOR TO OR AT THE TIME OF SEEDING AND INCORPORATED INTO THE SOIL. TYPES AND AMOUNTS OF LIME AND FERTILIZER SHOULD BE BASED ON AN EVALUATION OF SOIL TESTS. WHEN A SOIL TEST IS NOT AVAILABLE, THE FOLLOWING MINIMUM AMOUNTS SHOULD BE APPLIED:
 - AGRICULTURAL LIMESTONE, 2 TONS PER ACRE OR 100 LBS. PER 1,000 SQ.FT.
 - NITROGEN(N), 50 LBS. PER ACRE OR 1.1 LBS. PER 1,000 SQ.FT. PHOSPHATE(P205), 100 LBS. PER ACRE OR 2.2 LBS. PER 1,000 SQ.FT.
 - POTASH(K20), 100 LBS. PER ACRE OR 2.2 LBS. PER 1,000 SQ.FT.
 - (NOTE: THIS IS THE EQUIVALENT OF 500 LBS. PER ACRE OF 10-20-20 FERTILIZER OR 1,000 LBS. PER ACRE OF 5-10-10.)
- B. SEED SHOULD BE SPREAD UNIFORMLY BY THE METHOD MOST APPROPRIATE FOR THE SITE. METHODS INCLUDE BROADCASTING, DRILLING AND HYDROSEEDING. WHERE BROADCASTING IS USED, COVER SEED WITH .25 INCH OF SOIL OR LESS, BY CULTIPACKING OR RAKING.
- C. REFER TO THE 'SEEDING GUIDE' AND 'SEEDING RATES' TABLES ON THIS SHEET FOR APPROPRIATE SEED MIXTURES AND RATES OF SEEDING. ALL LEGUMES (CROWNVETCH, BIRDSFOOT, TREFOIL AND FLATPEA) MUST BE INOCULATED WITH THEIR SPECIFIC INOCULANT PRIOR TO THEIR INTRODUCTION TO THE SITE.
- D. WHEN SEEDED AREAS ARE MULCHED, PLANTINGS MAY BE MADE FROM EARLY SPRING TO EARLY OCTOBER. WHEN SEEDED AREAS ARE NOT MULCHED, PLANTINGS SHOULD BE MADE FROM EARLY SPRING TO MAY 20th OR FROM AUGUST 10th TO SEPTEMBER 1st.

4. MULCH

- A. HAY, STRAW, OR OTHER MULCH, WHEN NEEDED, SHOULD BE APPLIED IMMEDIATELY AFTER SEEDING. B. MULCH WILL BE HELD IN PLACE USING APPROPRIATE TECHNIQUES FROM THE BEST MANAGEMENT PRACTICE
- FOR MULCHING. HAY OR STRAW MULCH SHALL BE PLACED AT A RATE OF 90 LBS PER 1000 S.F. 5. MAINTENANCE TO ESTABLISH A STAND
- A. PLANTED AREAS SHOULD BE PROTECTED FROM DAMAGE BY FIRE, GRAZING, TRAFFIC, AND DENSE WEED GROWTH
- B. FERTILIZATION NEEDS SHOULD BE DETERMINED BY ONSITE INSPECTIONS. SUPPLEMENTAL FERTILIZER IS USUALLY THE KEY TO FULLY COMPLETE THE ESTABLISHMENT OF THE STAND BECAUSE MOST PERENNIALS TAKE 2 TO 3 YEARS TO BECOME FULLY ESTABLISHED.
- C. IN WATERWAYS, CHANNELS, OR SWALES WHERE UNIFORM FLOW CONDITIONS ARE ANTICIPATED, ANNUAL MOWING MAY BE NECESSARY TO CONTROL GROWTH OF WOODY VEGETATION.

USE	SEEDING MIXTURE 1/	DROUGHTY	WELL DRAINED	MODERATELY WELL DRAINED	POORLY DRAINED
STEEP CUTS AND FILLS, BORROW AND DISPOSAL AREAS	A B C	FAIR POOR POOR	GOOD GOOD GOOD	GOOD FAIR EXCELLENT	FAIR FAIR GOOD
	D	FAIR	EXCELLENT	EXCELLENT	POOR
WATERWAYS, EMERGENC SPILLWAYS, AND OTHER CHANNELS WITH FLOWING WATER.		GOOD GOOD	GOOD EXCELLENT	GOOD EXCELLENT	FAIR FAIR
LIGHTLY USED PARKING LOTS, ODD AREAS, UNUSED LANDS, AND LOW INTENSITY USE RECREATION SITES.	A B C	GOOD GOOD GOOD	GOOD GOOD EXCELLENT	GOOD FAIR EXCELLENT	FAIR POOR FAIR
PLAY AREAS AND ATHLETIC FIELDS. (TOPSOIL IS ESSENTIAL FOR GOOD TURF.)	E F	FAIR FAIR	EXCELLENT EXCELLENT	EXCELLENT EXCELLENT	<u>2/</u> 2/

GRAVEL PIT, SEE NH-PM-24 IN APPENDIX FOR RECOMMENDATION REGARDING RECLAMATION OF SAND AND GRAVEL PITS.


/ REFER TO SEEDING MIXTURES AND RATES IN TABLE BELOW. 27 POORLY DRAINED SOILS ARE NOT DESIRABLE FOR USE AS PLAYING AREA AND ATHLETIC FIELDS. NOTE: TEMPORARY SEED MIX FOR STABILIZATION OF TURF SHALL BE WINTER RYE OR OATS AT A RATE OF

2.5 LBS. PER 1000 S.F. AND SHALL BE PLACED PRIOR TO OCTOBER 15th, IF PERMANENT SEEDING NOT YET COMPLETE.

SEEDING GUIDE

MIXTURE	POUNDS PER ACRE	POUNDS PER 1.000 Sq. Ft.
A. TALL FESCUE	20	0.45
CREEPING RED FESCUE	20	0.45
RED TOP	<u>2</u>	<u>0.05</u>
TOTAL	42	0.95
B. TALL FESCUE CREEPING RED FESCUE CROWN VETCH OR	15 10 15	0.35 0.25 0.35
FLAT PEA	<u>30</u>	0.75
TOTAL	40 OR 55	0.95 OR 1.35
C. TALL FESCUE	20	0.45
CREEPING RED FESCUE	20	0.45
BIRDS FOOT TREFOIL	<u>8</u>	<u>0.20</u>
TOTAL	48	1.10
D. TALL FESCUE	20	0.45
FLAT PEA	<u>30</u>	<u>0.75</u>
TOTAL	50	1.20
E. CREEPING RED FESCUE 1/	50	1.15
KENTUCKY BLUEGRASS 1/	<u>50</u>	<u>1.15</u>
TOTAL	100	2.30
	150	3.60

SEEDING RATES

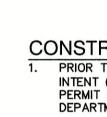

2. WETLAND ROADBEI

- 3. CUT AND INSTALL 4.
- MAINTAI
- STRUCTL 6. CONSTRU
- SHALL E
- 7. STRIP LC ENGINEER
- 8. PERFORM
- PREPARE 10. INSTALL
- BETWEEN
- 11. ALL SWA 12. DAILY, O
- EROSION
- 13. PERFORM
- 14. PAVE AL 15. PERFORM
- 16. LOAM A
- EROSION 17. FINISH F
- 18. ALL ROA
- 19. ALL CUT
- 20. COMPLE 21. REMOVE
- IMPROVE
- 22. CLEAN S 23. INSTALL
- 24. ALL ERO
- 25. UPON CO
- AGENCIE
- Designed and Produced in NH Plan Name: 🗕 Jones & Beach Engineers, Inc. Project: 85 Portsmouth Ave. Civil Engineering Services 603-772-4746 PO Box 219 FAX: 603-772-0227 Owner of Record: E-MAIL: JBE@JONESANDBEACH.COM Stratham, NH 03885

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MIMIMIN AND AND AND AND AND AND AND AND AND AN
BERM (OPTIONAL)
FILTER FABRIC PROFILE
-50' MINIMUM (75' WITHOUT MOUNTABLE BERM)-
NOTES: PLAN VIEW
1. STONE FOR STABILIZED CONSTRUCTION ENTRANCE SHALL BE 3 INCH STONE, RECLAIMED STONE, OR RECYCLED CONCRETE EQUIVALENT.
2. THE LENGTH OF THE STABILIZED ENTRANCE SHALL NOT BE LESS THAN 50 FEET, 75' WITHOUT A MOUNTABLE BERM, AND EXCEPT FOR A SINGLE RESIDENTIAL LOT WHERE A 30 FOOT MINIMUM LENGTH WOULD APPLY.
 THICKNESS OF THE STONE FOR THE STABILIZED ENTRANCE SHALL NOT BE LESS THAN 6 INCHES. THE WIDTH OF THE ENTRANCE SHALL NOT BE LESS THAN THE FULL WIDTH OF THE ENTRANCE WHERE INGRESS OR EGRESS OCCURS, OR 10 FEET, WHICHEVER IS GREATER.
 GEOTEXTILE FILTER FABRIC SHALL BE PLACED OVER THE ENTIRE AREA PRIOR TO PLACING THE STONE. FILTER FABRIC IS NOT REQUIRED FOR A SINGLE FAMILY RESIDENTIAL LOT. ALL SURFACE WATER THAT IS FLOWING TO OR DIVERTED TOWARD THE CONSTRUCTION ENTRANCE SHALL BE
PIPED BENEATH THE ENTRANCE. IF PIPING IS IMPRACTICAL, A STONE BERM WITH 5:1 SLOPES THAT CAN BE CROSSED BY VEHICLES MAY BE SUBSTITUTED FOR THE PIPE. 7. THE ENTRANCE SHALL BE MAINTAINED IN A CONDITION THAT WILL PREVENT TRACKING OR FLOWING OF
SEDIMENT ONTO THE PUBLIC RIGHT-OF-WAY. THIS MAY REQUIRE PERIODIC TOP DRESSING WITH ADDITIONAL STONE AS CONDITIONS DEMAND AND REPAIR AND/OR CLEAN OUT OF ANY MEASURES USED TO TRAP SEDIMENT. ALL SEDIMENT SPILLED, WASHED, OR TRACKED ONTO THE PUBLIC RIGHT-OF-WAY MUST BE
STABILIZED CONSTRUCTION ENTRANCE
NOT TO SCALE
UCTION SEQUENCE O THE START OF ANY ACTIVITY, IT IS THE RESPONSIBILITY OF THE SITE'S SITE DEVELOPER (OR OWNER) TO FILE A NOTICE OF (NOI) FORM WITH THE ENVIRONMENTAL PROTECTION AGENCY (EPA) IN ORDER TO GAIN COVERAGE UNDER THE NPDES GENERAL
FOR STORM WATER DISCHARGES FROM CONSTRUCTION ACTIVITIES. A PRE CONSTRUCTION MEETING IS TO BE HELD WITH ALL MENT HEADS PRIOR TO THE START OF CONSTRUCTION.
D BOUNDARIES ARE TO BE CLEARLY MARKED PRIOR TO THE START OF CONSTRUCTION. AT LEAST A TEMPORARY CULVERT OR D TO BE IN PLACE PRIOR TO THE START OF CONSTRUCTION.
D REMOVE TREES IN CONSTRUCTION AREA AS REQUIRED OR DIRECTED. SILT FENCING, HAY BALES AND CONSTRUCTION ENTRANCES PRIOR TO THE START OF CONSTRUCTION. THESE ARE TO BE
NED UNTIL THE FINAL PAVEMENT SURFACING AND LANDSCAPING AREAS ARE ESTABLISHED.
JRES, UTILITIES, ETC.
JCT AND/OR INSTALL TEMPORARY OR PERMANENT SEDIMENT AND/OR DETENTION BASIN(S) AS REQUIRED. THESE FACILITIES THE INSTALLED AND STABILIZED PRIOR TO DIRECTING RUN-OFF TO THEM.
DAM AND PAVEMENT, OR RECLAIM EXISTING PAVEMENT WITHIN LIMITS OF WORK PER THE RECOMMENDATIONS OF THE PROJECT R AND STOCKPILE EXCESS MATERIAL. STABILIZE STOCKPILE AS NECESSARY.
A PRELIMINARY SITE GRADING IN ACCORDANCE WITH THE PLANS. E BUILDING PAD(S) TO ENABLE BUILDING CONSTRUCTION TO BEGIN.
THE DRAINAGE SYSTEMS FIRST, THEN ANY OTHER UTILITIES IN ACCORDANCE WITH THE PLAN AND DETAILS. ANY CONFLICTS I UTILITIES ARE TO BE RESOLVED WITH THE INVOLVEMENT AND APPROVAL OF THE ENGINEER.
LES AND DRAINAGE STRUCTURES ARE TO BE CONSTRUCTED AND STABILIZED PRIOR TO HAVING RUN-OFF DIRECTED TO THEM.
R AS REQUIRED, CONSTRUCT TEMPORARY BERMS, DRAINAGE DITCHES, CHECK DAMS, SEDIMENT TRAPS, ETC., TO PREVENT ON THE SITE AND PREVENT ANY SILTATION OF ABUTTING WATERS AND/OR PROPERTY.
I FINAL FINE GRADING, INCLUDING PLACEMENT OF 'SELECT' SUBGRADE MATERIALS.
A ALL REMAINING SITE CONSTRUCTION (i.e. BUILDING, UTILITY CONNECTIONS, ETC.).
ND SEED ALL DISTURBED AREAS AND INSTALL ANY REQUIRED SEDIMENT AND EROSION CONTROL FACILITIES (i.e. RIP RAP, CONTROL BLANKETS, ETC.).
AVING ALL ROADWAYS AND PARKING AREAS WITH 'FINISH' COURSE.
DWAYS AND PARKING LOTS SHALL BE STABILIZED WITHIN 72 HOURS OF ACHIEVING FINISHED GRADE.
TE PERMANENT SEEDING AND LANDSCAPING.
TEMPORARY EROSION CONTROL MEASURES AFTER SEEDING AREAS HAVE BEEN 75%-85% ESTABLISHED AND SITE MENTS ARE COMPLETE. SMOOTH AND RE-VEGETATE ALL DISTURBED AREAS.
SITE AND ALL DRAINAGE STRUCTURES, PIPES AND SUMPS OF ALL SILT AND DEBRIS. ALL PAINTED PAVEMENT MARKINGS AND SIGNAGE PER THE PLANS AND DETAILS.
SION CONTROLS SHALL BE INSPECTED WEEKLY AND AFTER EVERY HALF-INCH OF RAINFALL.
OMPLETION OF CONSTRUCTION, IT IS THE RESPONSIBILITY OF THE CONTRACTOR TO NOTIFY ANY RELEVANT PERMITTING S THAT THE CONSTRUCTION HAS BEEN FINISHED IN A SATISFACTORY MANNER.
OSION AND SEDIMENT CONTROL DETAILS
LIBERTY LANTERN ESTATES MAIN STREET EREMONT NH
MAIN STREET, FREMONT, NH

TIMOTHY & GERALDINE PALMER 706 MAIN STREET, FREMONT, NH 03044

SHEET 21 OF 21 JBE PROJECT NO. 20724